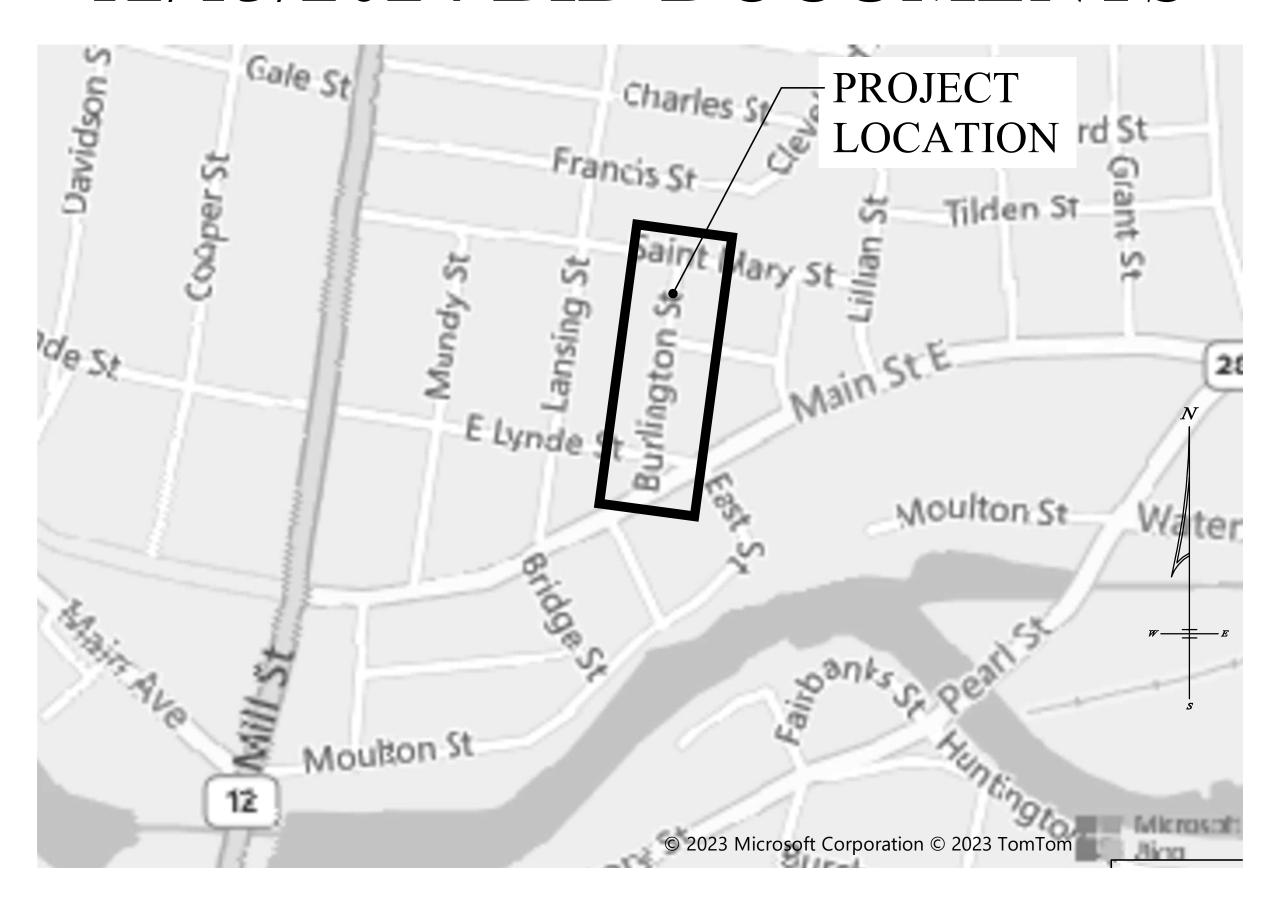
# BURLINGTON STREET RECONSTRUCTION PROJECT

## CITY OF WATERTOWN ENGINEERING DEPARTMENT JEFFERSON COUNTY, STATE OF NEW YORK 12/13/2024 BID DOCUMENTS



#### CITY OF WATERTOWN OFFICIALS

MAYOR:

CITY COUNCIL:

SARAH V.C. PIERCE

LISA A. RUGGIERIO

CLIFFORD G. OLNEY III

ROBERT O. KIMBALL
BENJAMIN P. SHOEN
EDIC E. WAGENAAR

CITY MANAGER: ERIC F. WAGENAAR
CITY ENGINEER: THOMAS S.M. COMPO

CITY ATTORNEY:

BOND SCHOENECK & KING, PLLC

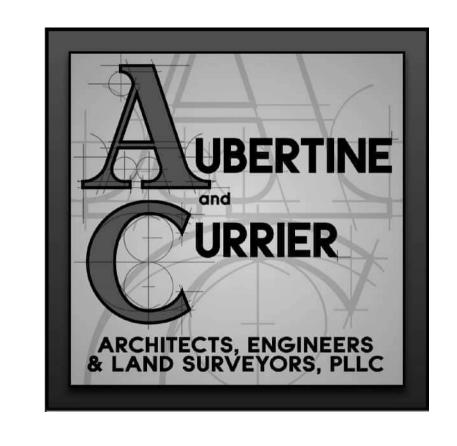
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CITY PURCHASING MANAGER: TINA BARTLETT-BEARUP




#### PROJECT ENGINEER

AUBERTINE and CURRIER, PLLC 522 BRADLEY STREET WATERTOWN, NEW YORK 13601 TELE: (315) 782-2005 FAX: (315) 782-1472 www.aubertinecurrier.com



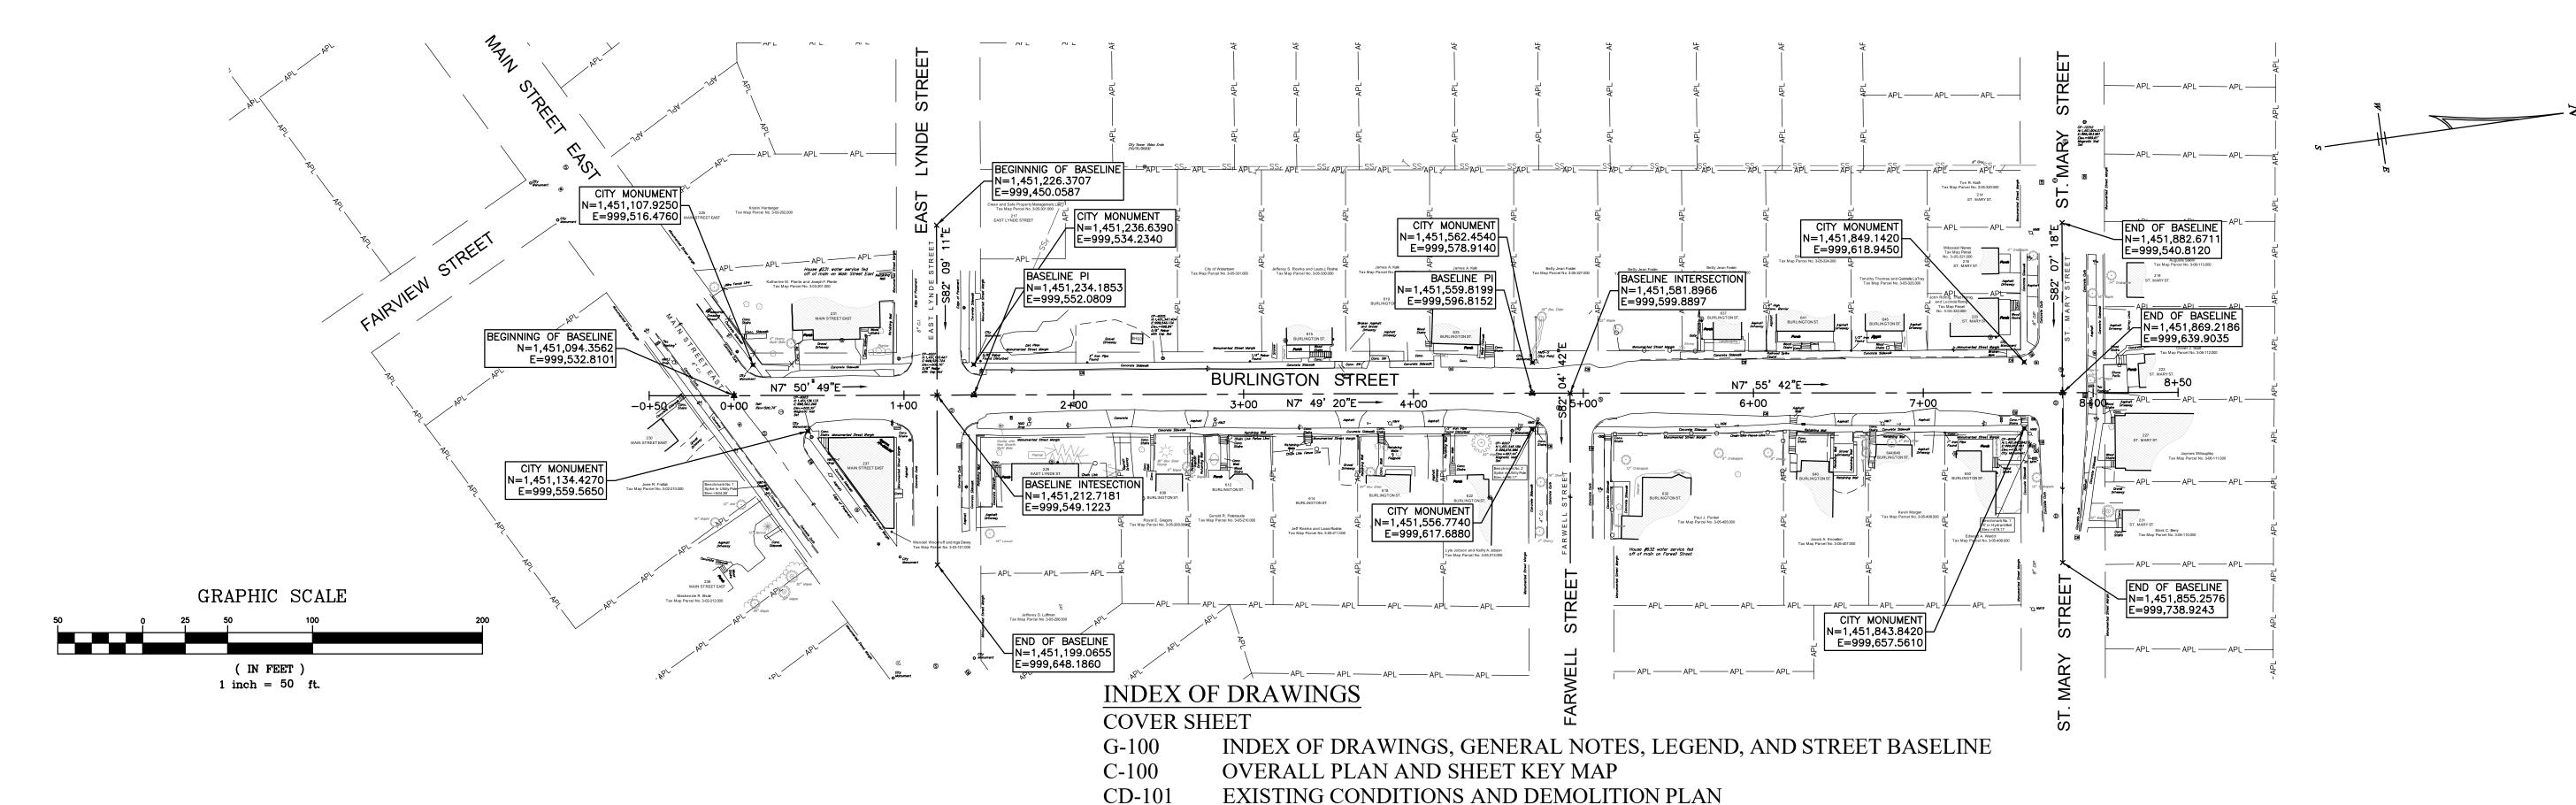12/13/2024 BID DOCUMENTS FOR CONSTRUCTION



- 1. UNDERGROUND FACILITIES, STRUCTURES AND UTILITIES HAVE BEEN PLOTTED FROM AVAILABLE SURVEYS AND RECORDS, AND THEREFORE THEIR LOCATIONS MUST BE CONSIDERED APPROXIMATE ONLY. THERE MAY BE OTHERS, THE EXISTENCE OF WHICH IS PRESENTLY NOT KNOWN. PRIOR TO CONSTRUCTION CONTACT UNDERGROUND UTILITIES CALL CENTER OF NEW YORK FOR EXACT LOCATION OF ALL UNDERGROUND UTILITIES, (1-800-962-7962), CONTRACTOR IS RESPONSIBLE FOR LOCATING AND WORKING WITH THE APPROPRIATE UTILITY COMPANIES PRIOR TO CONSTRUCTION
- 2. THE ONSITE TOPOGRAPHIC, UTILITY, AND PLANIMETRIC SURVEY FOR THE PROJECT AREA WAS CONDUCTED BY AUBERTINE AND CURRIER. PLLC IN APRIL AND MAY OF 2023. UTILITY LOCATIONS WERE PLOTTED FROM DRAWINGS OF MULTIPLE PROJECTS THAT ARE ON FILE IN THE CITY ENGINEERING DEPARTMENT, VERTICAL DATUM IS BASED ON NAVD88 DATUM AND THE HORIZONTAL DATUM IS BASED ON NAD83 (2011). 3 ALL OUT-OF-SCOPE AREAS DISTURBED BY THE CONTRACTOR'S OPERATIONS WILL BE
- RESTORED TO CONDITIONS EQUAL TO OR BETTER THAN THAT PRIOR TO CONSTRUCTION. OUTSIDE OF PROPERTY BOUNDARIES AND EASEMENT AREAS THE CONTRACTOR IS REMINDED THAT HE MUST OBTAIN WRITTEN AUTHORIZATION TO USE PRIVATE PROPERTY AND ASSUMES ALL LIABILITY HIMSELF THE CONTRACTOR IS RESPONSIBLE FOR VERIFYING THE CHARACTERISTICS AND EXTENT OF
- SUBSURFACE SOILS, ROCK, WATER TABLE LEVELS, ETC., PRIOR TO BIDDING. THE CONTRACTOR SHALL BE RESPONSIBLE FOR OBTAINING ALL NECESSARY PERMITS AND
- 6. SITE CONTRACTOR TO PROVIDE EROSION AND DUST CONTROL AS REQUIRED.
- A LICENSED LAND SURVEYOR SHALL BE RETAINED FOR ALL UTILITY AND FIELD STAKEOUT AT THE CONTRACTORS EXPENSE. 8. PAVED AREAS WILL BE SAWCUT PRIOR TO EXCAVATION AND PAVING OPERATIONS. SAW CUT
- AREAS WILL BE TACK COATED PRIOR TO PAVING. TACK COAT SHALL MEET THE REQUIREMENTS OF ASPHALT OF ASPHALT EMULSION FOR TACK COAT, NYSDOT TABLE 702-9. 9. CONTRACTOR SHALL MAINTAIN ALL EROSION CONTROL MEASURES THROUGHOUT CONSTRUCTION UNTIL ESTABLISHMENT OF VEGETATIVE COVER. RUN-OFF CONTAINING SEDIMENTS FROM DISTURBED AREAS OF THE SITE SHALL NOT BE ALLOWED DIRECTLY INTO
- NATURAL STREAM CHANNELS. 10. ALL TREES AND WETLANDS TO REMAIN SHALL BE PROTECTED BY THE CONTRACTOR. CONSTRUCTION ACTIVITIES ADJACENT TO TREES SHALL BE CONDUCTED TO REDUCE THE IMPACT TO TREES TO THE MAXIMUM EXTENT PRACTICAL. ANY DAMAGE TO EXISTING TREES SHALL BE REPAIRED OR THE TREE REPLACED, AS DIRECTED BY THE OWNER AT THE CONTRACTORS EXPENSE.
- 11. CONTRACTOR SHALL PERFORM ALL ROADWAY CONNECTION WORK IN ACCORDANCE WITH NYSDOT SPECIFICATIONS. ALL ROADWAY WORK SHALL BE IN ACCORDANCE WITH NYSDOT MAINTENANCE AND PROTECTION OF TRAFFIC REGULATIONS, INCLUDING FLAGMEN,
- BARRICADES, WARNING SIGNS/LIGHTS, ETC., WHERE WARRANTED. 12. CONTRACTOR SHALL BE RESPONSIBLE FOR REMOVAL AND PROPER DISPOSAL, AT A NYSDEC ACCEPTABLE LOCATION OF ALL MATERIALS NOT REUSED AS TRENCH BACKELL
- 13. EXCAVATIONS SHALL BE TO DEPTHS SHOWN ON DRAWINGS. ALL UNSTABLE OR UNSUITABLE MATERIAL SHALL BE EXCAVATED AND REMOVED TO SUCH DEPTH AS REQUIRED TO PROVIDE SUFFICIENT BEARING CAPACITY. OVEREXCAVATED AREAS SHALL BE BACKFILLED WITH SUITABLE MATERIAL.
- 14. COMPACTION OF PIPE BEDDING AND BACKFILL MATERIAL SHALL BE BY MEANS OF HAND-GUIDED POWER DRIVEN OR DRUM-TYPE OR PLATE TAMPERS. BACKFILLING SHOULD PROCEED IN ACCORDANCE WITH LIFT THICKNESS AND COMPACTION REQUIREMENTS AS SHOWN ON THE DRAWINGS, UNLESS OTHERWISE NOTED ON THE DRAWINGS, COMPACTION REQUIREMENTS REFER TO PERCENT OF MAXIMUM DRY DENSITY AS DETERMINED IN ACCORDANCE WITH ASTM STANDARD D1557 METHOD "C". CARE SHOULD BE TAKEN TO SHAPE PIPE BEDDING TO FIT THE LOWER PART OF THE PIPE. BACKFILLING AND COMPACTION SHOULD PROGRESS EVENLY ALONG THE PIPE SIDEWALLS AND TO THE TOP OF PIPE
- 15. THE CONTRACTOR SHALL NOTIFY THE ENGINEER OF ANY DISCREPANCIES OF DIMENSIONS ELEVATIONS AND LOCATIONS DURING PRECONSTRUCTION FIELD VERIFICATION. SUCH INFORMATION SHALL BE BROUGHT TO THE ATTENTION OF THE ENGINEER FOR VERIFICATION OR MODIFICATION OF THE PLANS.

- 16. THE CONTRACTOR SHALL PROVIDE AS-BUILT RECORD DRAWINGS INCLUDING, AS A MINIMUM THE FOLLOWING INFORMATION AS WELL AS ALL REQUIREMENTS OF THE SPECIFICATION: RECORD OF ALL UTILITIES ENCOUNTERED IN TRENCH EXCAVATION. INFORMATION SHALL INCLUDE DIAMETER OF UTILITY, DEPTH OF BURIAL, ELEVATION AND LOCATION
- UTILITY REPAIRS, SIDEWALK, AND DRIVEWAY REPLACEMENTS CENTERLINE.
- STATIONS OF BENDS, CLEANOUTS, VALVES AND CORPORATION STOPS. DENOTE BENCH MARK REFERENCE USED.
- CHANGES OF DIMENSIONS AND DETAILS AND ANY CHANGES MADE BY CHANGE
- INFORMATION IS ACCEPTABLE
- FURNISH AS-BUILT DATA ON PLAN SHEETS. ALL WATER MAIN AND SERVICE WORK MUST BE COORDINATED WITH THE CITY OF

OTHER PLANS AND SPECIFICATIONS PROVIDED. ONLY THE CITY OF WATERTOWN WATER.

- DEPARTMENT SHALL OPERATE WATER VALVES AND HYDRANTS, UNLESS PRIOR AUTHORIZATION IS RECEIVED FROM THE CITY OF WATERTOWN. THE CONTRACTOR SHALL COORDINATE ANY REQUIRED VALVE OPERATION 48 HOURS PRIOR TO NEEDED OPERATIONS 18 PRIOR TO ANY PLANNED WATER SHUTDOWN, THE CONTRACTOR SHALL COORDINATE WITH THE WATER DEPARTMENT, A MINIMUM OF ONE WEEK PRIOR. CONSUMERS SHALL BE NOTIFIED 24 HOURS PRIOR TO ANY PLANNED SHUTDOWN. SERVICES TO CONSUMERS SHALL
- BE MAINTAINED WITH AS LITTLE INTERRUPTIONS AS POSSIBLE. CONSUMER WATER SERVICE SHALL NOT BE DISRUPTED LONGER THAN 4 HOURS, OR TEMPORARY WATER SERVICES MAY BE REQUIRED TO BE PROVIDED BY THE CONTRACTOR, AS ORDERED BY THE CITY ENGINEERING. 19. ALL SANITARY SEWER MAIN AND LATERAL WORK MUST BE COORDINATED WITH THE CITY OF
- WATERTOWN DPW. PRIOR TO ANY PLANNED SHUTDOWN, THE CONTRACTOR SHALL COORDINATE WITH THE CITY OF WATERTOWN DPW, A MINIMUM OF ONE WEEK PRIOR. CONSUMERS SHALL BE NOTIFIED 24 HOURS PRIOR TO ANY PLANNED SHUTDOWN. LATERALS TO CONSUMERS SHALL BE MAINTAINED WITH AS LITTLE INTERRUPTIONS AS POSSIBLE. CONSUMER SANITARY SEWER LATERALS SHALL NOT BE DISRUPTED LONGER THAN 4 HOURS OR TEMPORARY SERVICES MAY BE REQUIRED BY THE CONTRACTOR, AS ORDERED BY CITY ENGINEERING.
- 20. ALL WORK TO BE PERFORMED WITHIN THE CITY OF WATERTOWN MARGIN SHALL BE BUILT ACCORDING TO THE APPROVED SITE PLAN AND APPLICABLE CITY OF WATERTOWN STANDARDS. COMPACTION TESTING WILL BE REQUIRED FOR ALL WORK TO BE PERFORMED WITHIN THE CITY OF WATERTOWN MARGIN AND MUST BE SUBMITTED TO THE CITY OF WATERTOWN CODES DEPARTMENT.
- 21. CONTRACTOR SHALL SUBMIT TRAFFIC CONTROL PLANS TO CITY ENGINEERING PRIOR TO ANY CONSTRUCTION ACTIVITIES. CONTRACTOR MAY BE ABLE TO CLOSE STREETS TO "LOCAL TRAFFIC ONLY" DURING CONSTRUCTION ACTIVITIES. TRAVEL LANES AND ACCESS TO ALL PROPERTIES SHALL BE PROVIDED AT THE END OF EACH WORKING DAY.

#### WITH REFERENCE TO NEAREST STRUCTURE SHOWN ON DRAWINGS. THIS INFORMATION SHALL BE KEPT CURRENT ON A WEEKLY BASIS. FAILURE TO DO SO MAY RESULT IN WITHHOLDING OF PAYMENTS • DISTANCE TIES TO ALL MANHOLES, CLEANOUTS, BENDS AND CORPORATION STOPS. PERIODIC OFFSETS RECORD DETAILS NOT SHOWN ON THE ORIGINAL CONTRACT DOCUMENTS. ANY FIELD CERTIFICATE OF SUBSTANTIAL COMPLETION SHALL NOT BE ISSUED UNTIL AS-BUILT PROVIDE TWO (2) SETS OF FINAL COMPLETE RECORD DRAWINGS. CONTRACTOR SHAL

RETAINING WALL PLAN AND PROFILE EROSION AND SEDIMENT CONTROL PLAN CG-105 CG-106 EROSION AND SEDIMENT CONTROL PLAN CU-101

SITE PLAN

SITE PLAN

CD-102

CS-101

CS-102

CS-103

CS-104

CS-105

CG-10

CG-102

CG-103

UTILITY PLAN AND PROFILE - SANITARY AND STORM SEWER CU-102 UTILITY PLAN AND PROFILE - SANITARY AND STORM SEWER CU-103 UTILITY PLAN AND PROFILE - SANITARY AND STORM SEWER

EXISTING CONDITIONS AND DEMOLITION PLAN

EXISTING CONDITIONS AND DEMOLITION PLAN

PAVEMENT MARKING AND SIGNAGE PLAN

PAVEMENT MARKING AND SIGNAGE PLAN

GRADING PLAN AND CENTERLINE PROFILE

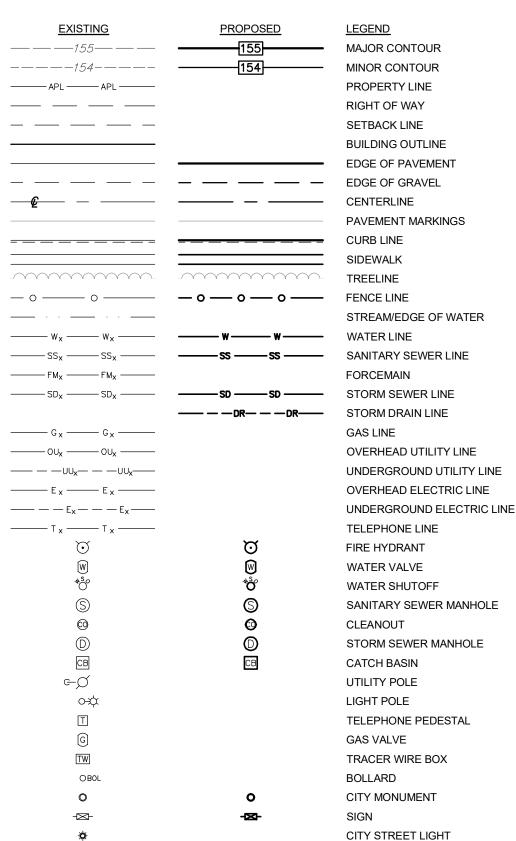
GRADING PLAN AND CENTERLINE PROFILE

TREE PROTECTION AND PLANTING PLAN

TREE PROTECTION AND PLANTING PLAN

RETAINING WALL PLAN AND PROFILE

- UTILITY PLAN AND PROFILE WATER MAIN CU-104 UTILITY PLAN AND PROFILE - WATER MAIN CU-105
- WORK ZONE TRAFFIC CONTROL PLAN CT-100
- CG-200 TYPICAL STREET CROSS SECTION BURLINGTON STREET CROSS SECTION CG-201
- CG-202 BURLINGTON STREET CROSS SECTION
- CG-203 BURLINGTON STREET CROSS SECTION
- CG-400 OVERALL ENLARGED GRADING PLAN KEY MAP CG-401 ENLARGED GRADING PLAN
- CG-402 ENLARGED GRADING PLAN
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- CG-405 ENLARGED GRADING PLAN
- CG-406 ENLARGED GRADING PLAN
- CS-500 SITE DETAILS
- SITE DETAILS CS-501
- CS-502 SITE DETAILS
- CS-503 SIGNAGE DETAILS
- CS-504 RETAINING WALL AND CONCRETE STEP DETAILS
- CS-505 CONCRETE STEP SIDEWALL DETAILS
- CS-506 CONCRETE STEP SIDEWALL CROSS SECTIONS
- CS-507 CONCRETE STEP SIDEWALL CROSS SECTIONS
- CS-508 CONCRETE STEP SIDEWALL CROSS SECTIONS
- CG-500 EROSION AND SEDIMENT CONTROL DETAILS
- CU-500 TYPICAL UTILITIES STREET CROSS SECTION
- CU-501 WATER DETAILS
- CU-502 SANITARY SEWER DETAILS
- CU-503 STORM SEWER DETAILS
- CT-500 WORK ZONE TRAFFIC CONTROL SHEETS
- CT-501 WORK ZONE TRAFFIC CONTROL SHEETS
- CT-502 WORK ZONE TRAFFIC CONTROL SHEETS CT-503 WORK ZONE TRAFFIC CONTROL SHEETS



NOTE: THE EXISTING UTILITIES INDICATED BY LINETYPES WITH THE SUBSCRIPT "r" ARE DERIVED FROM CITY OF WATERTOWN GIS RECORD FILES. THE EXISTING UTILITIES INDICATED BY LINETYPES WITH SUBSCRIPT "x" ARE DERIVED FROM CITY OF WATERTOWN PUBLIC WORKS PAINT MARKINGS/FLAGGING AND/OR VISUAL VERIFICATION

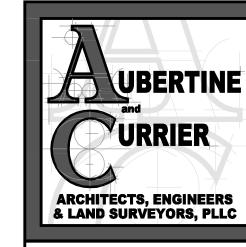
TREES

STUMP

BENCHMARK

SURVEY CONTROL POINT

12/13/2024 BID DOCUMENTS FOR CONSTRUCTION




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PROJECT NO: 2023-052
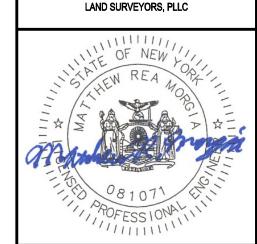
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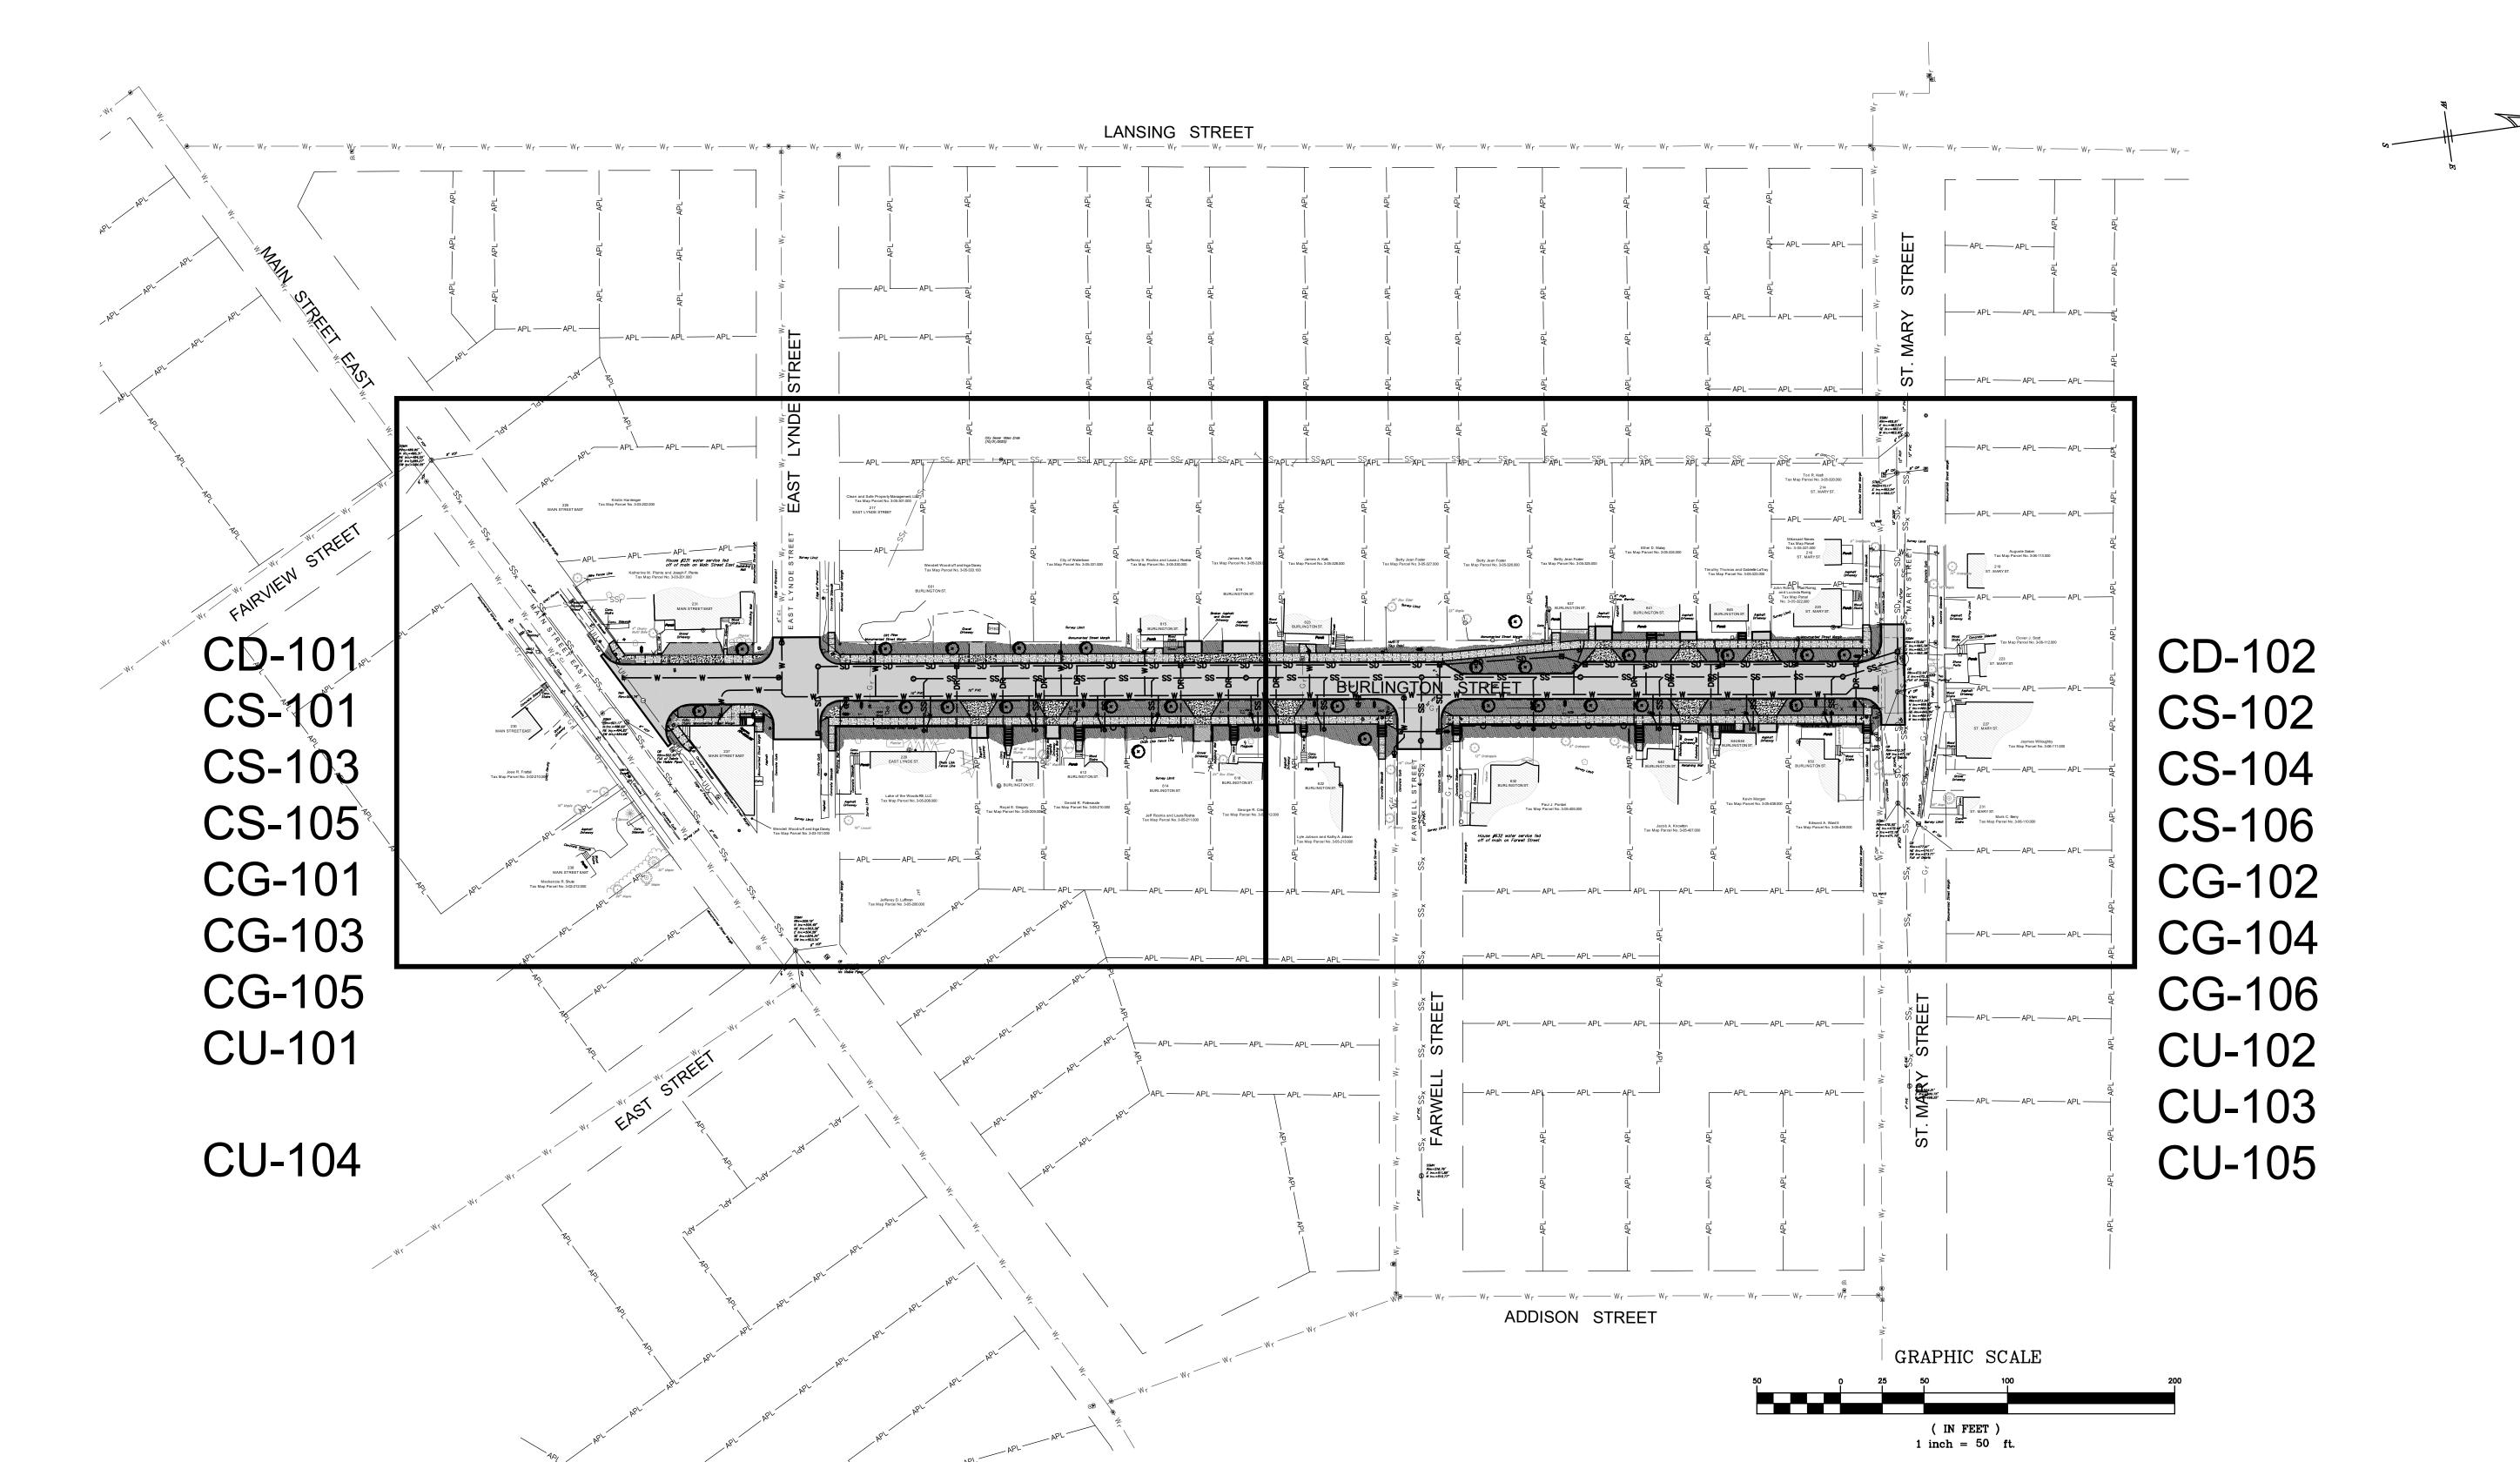
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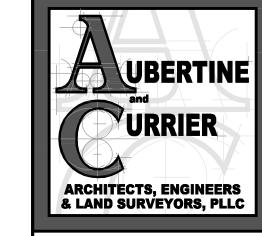
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> INDEX OF DRAWINGS, GENERAL NOTES, LEGEND

AND STREET BASELINE

G-100





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BURLINGTON STREET
RECONSTRUCTION PROJECT
CITY OF WATERTOWN
ENGINEERING DEPARTMENT
JEFFERSON COUNTY, STATE OF NEW YORK

PROJECT NO: 2023-052

SCALE: 1"=50'

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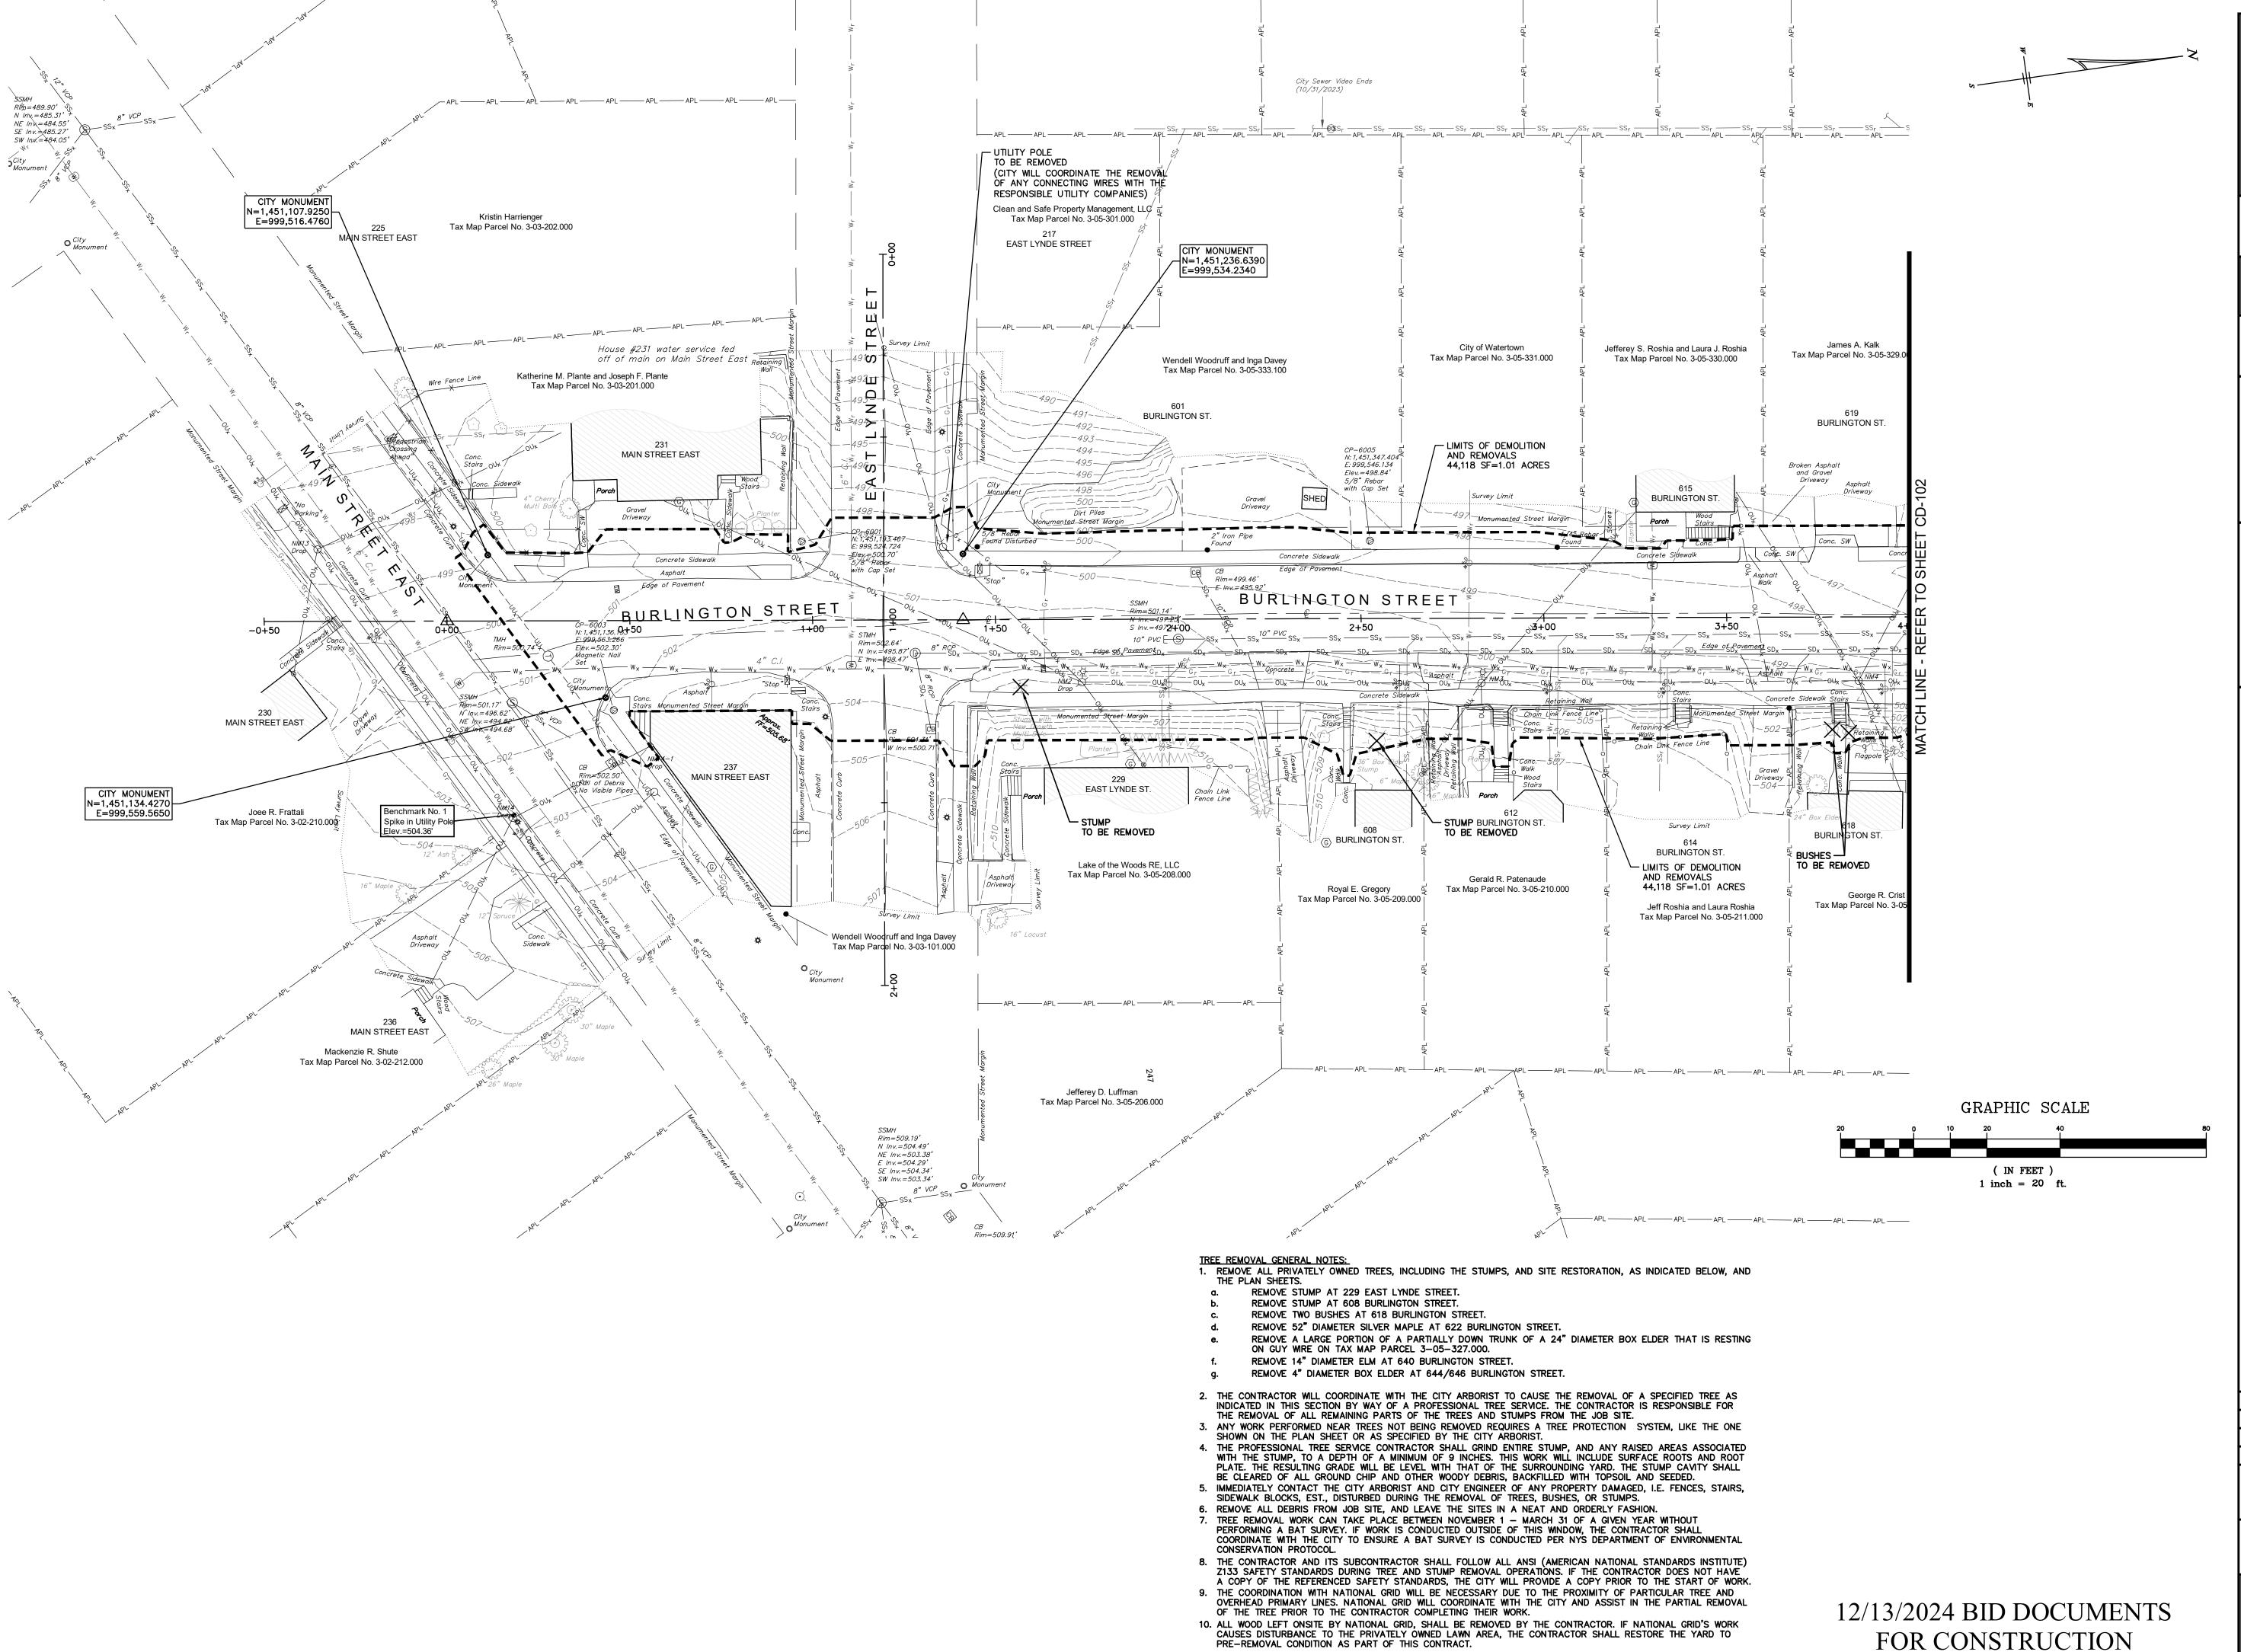
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ISSUE DATES:

ISSUE DATE: 02/23/2024 04/30/2024 12/13/2024

> OVERALL PLAN AND SHEET KEY MAP

**C-100** 



PRE-REMOVAL CONDITION AS PART OF THIS CONTRACT.

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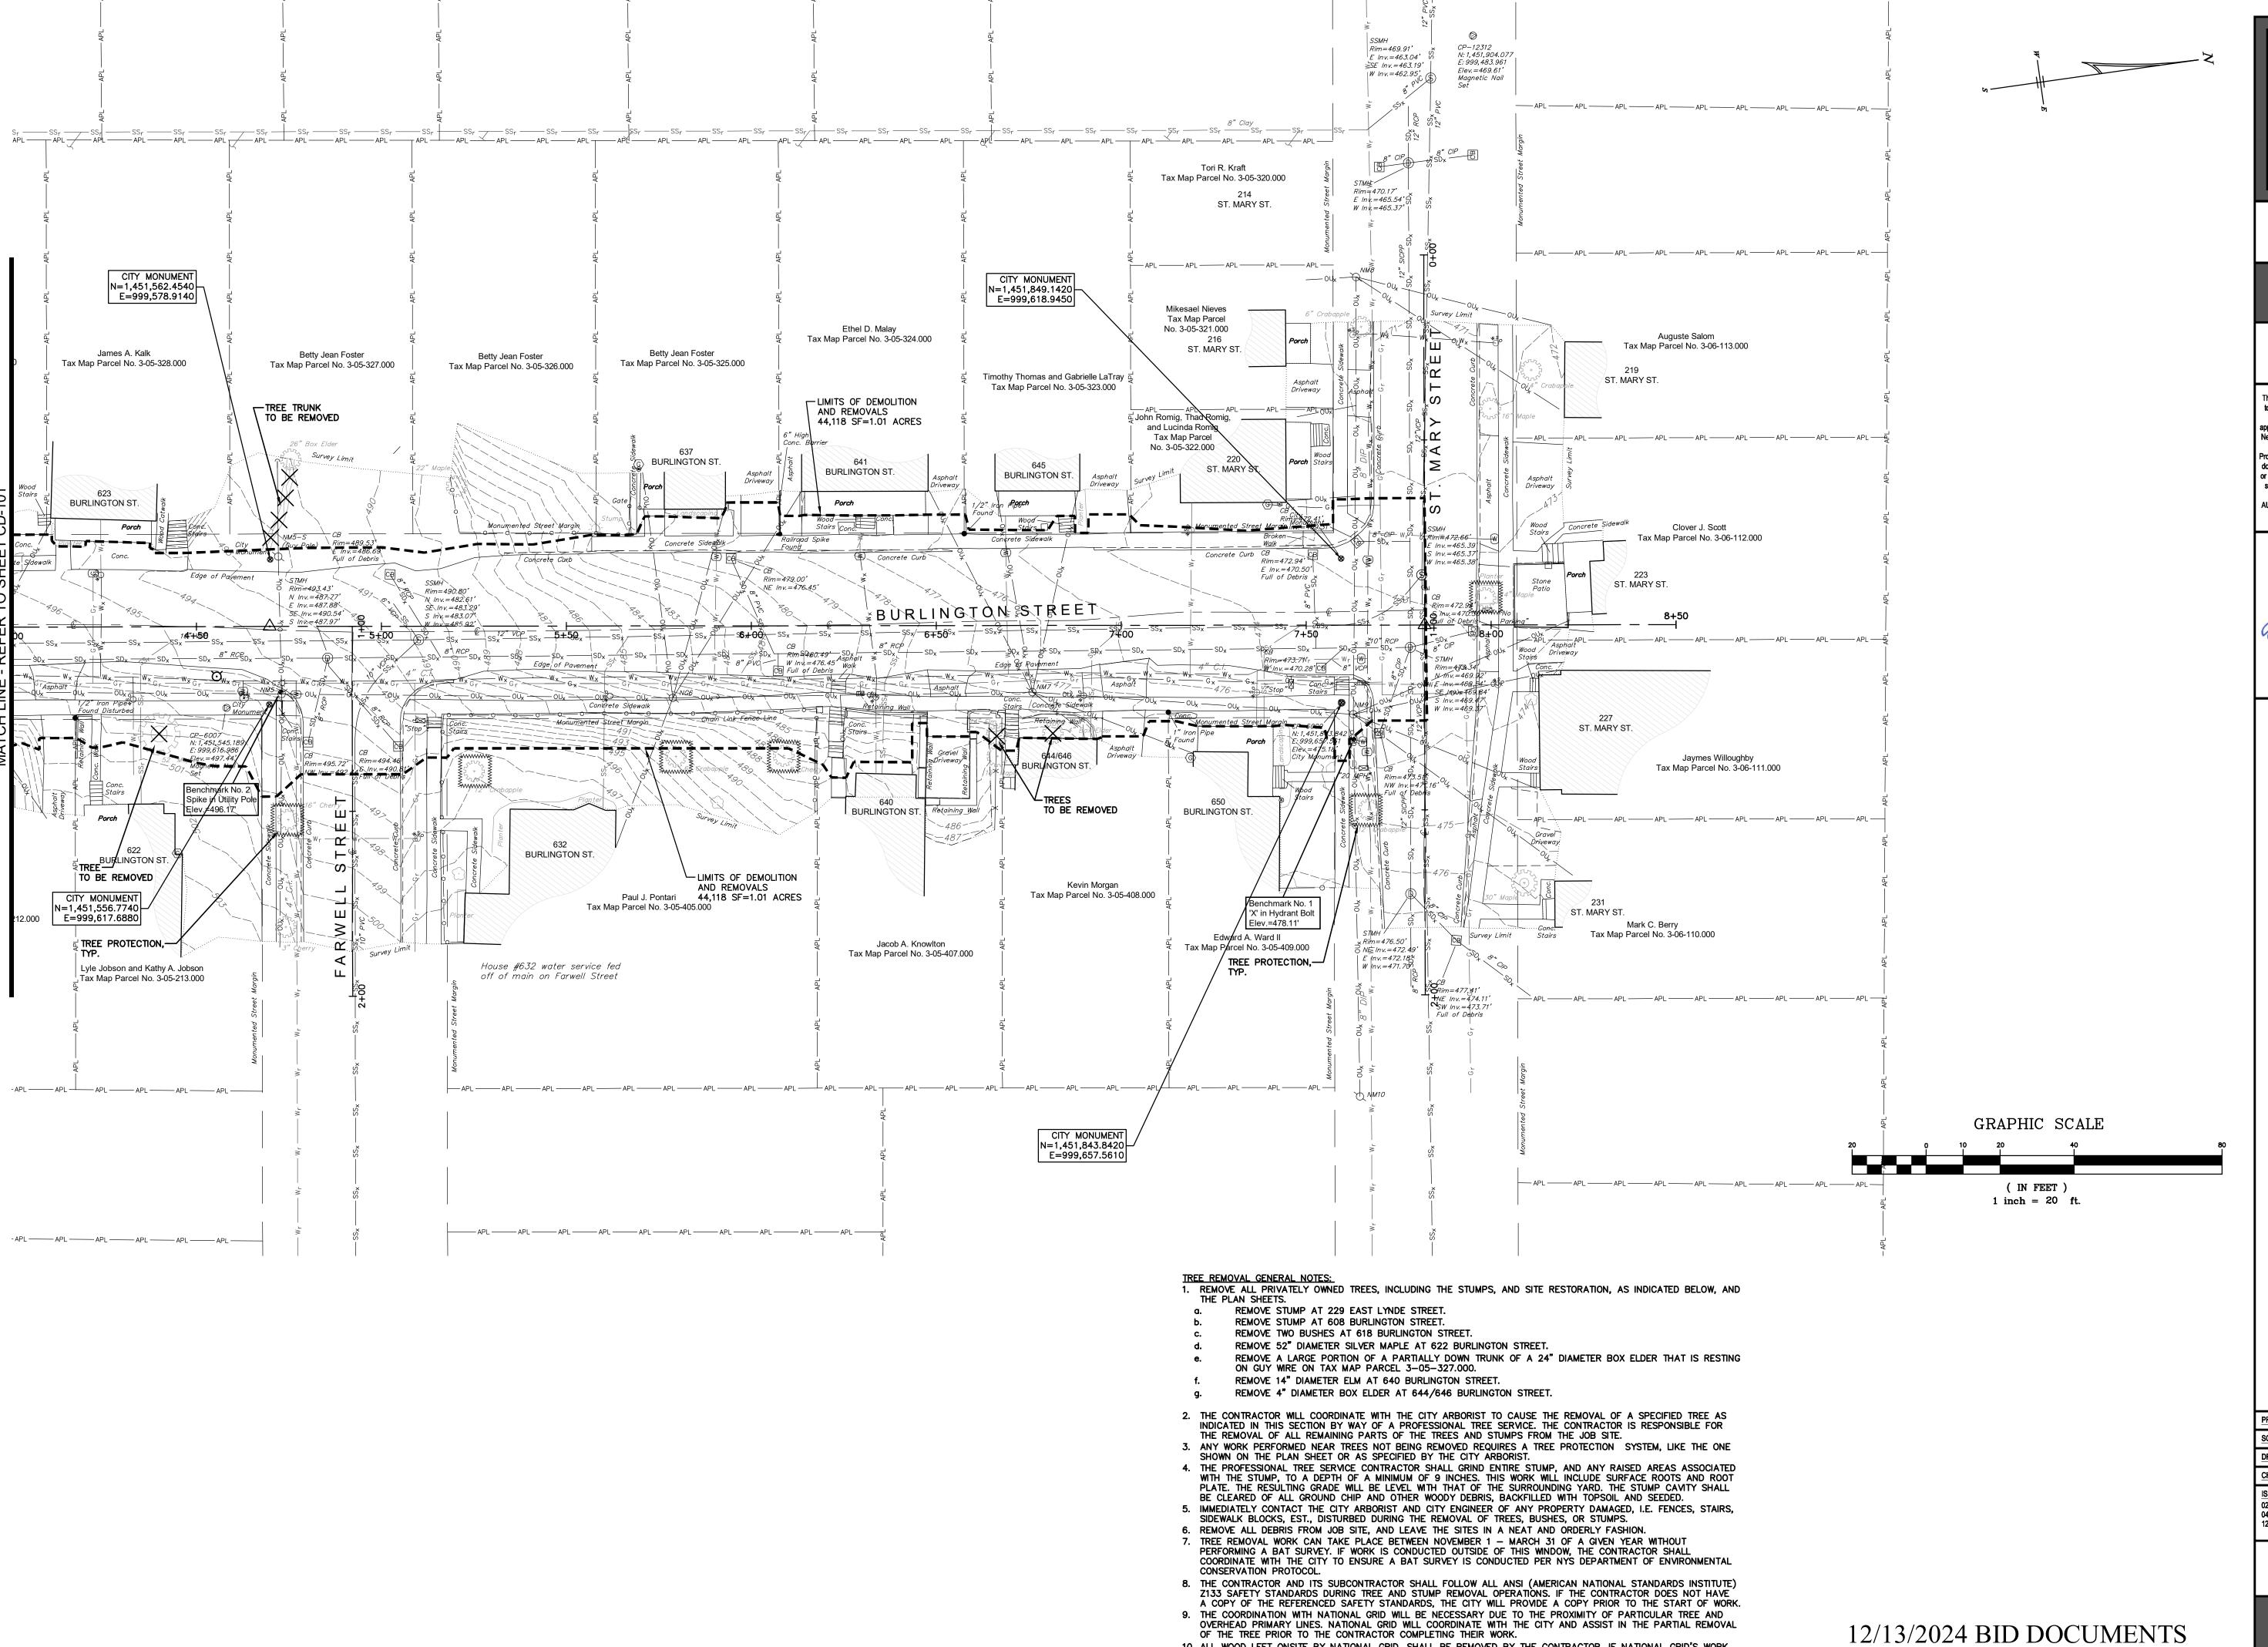
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ISSUE DATES: 04/30/2024 12/13/2024

> EXISTING CONDITIONS AND DEMOLITION PLAN



10. ALL WOOD LEFT ONSITE BY NATIONAL GRID, SHALL BE REMOVED BY THE CONTRACTOR. IF NATIONAL GRID'S WORK CAUSES DISTURBANCE TO THE PRIVATELY OWNED LAWN AREA, THE CONTRACTOR SHALL RESTORE THE YARD TO

PRE-REMOVAL CONDITION AS PART OF THIS CONTRACT.

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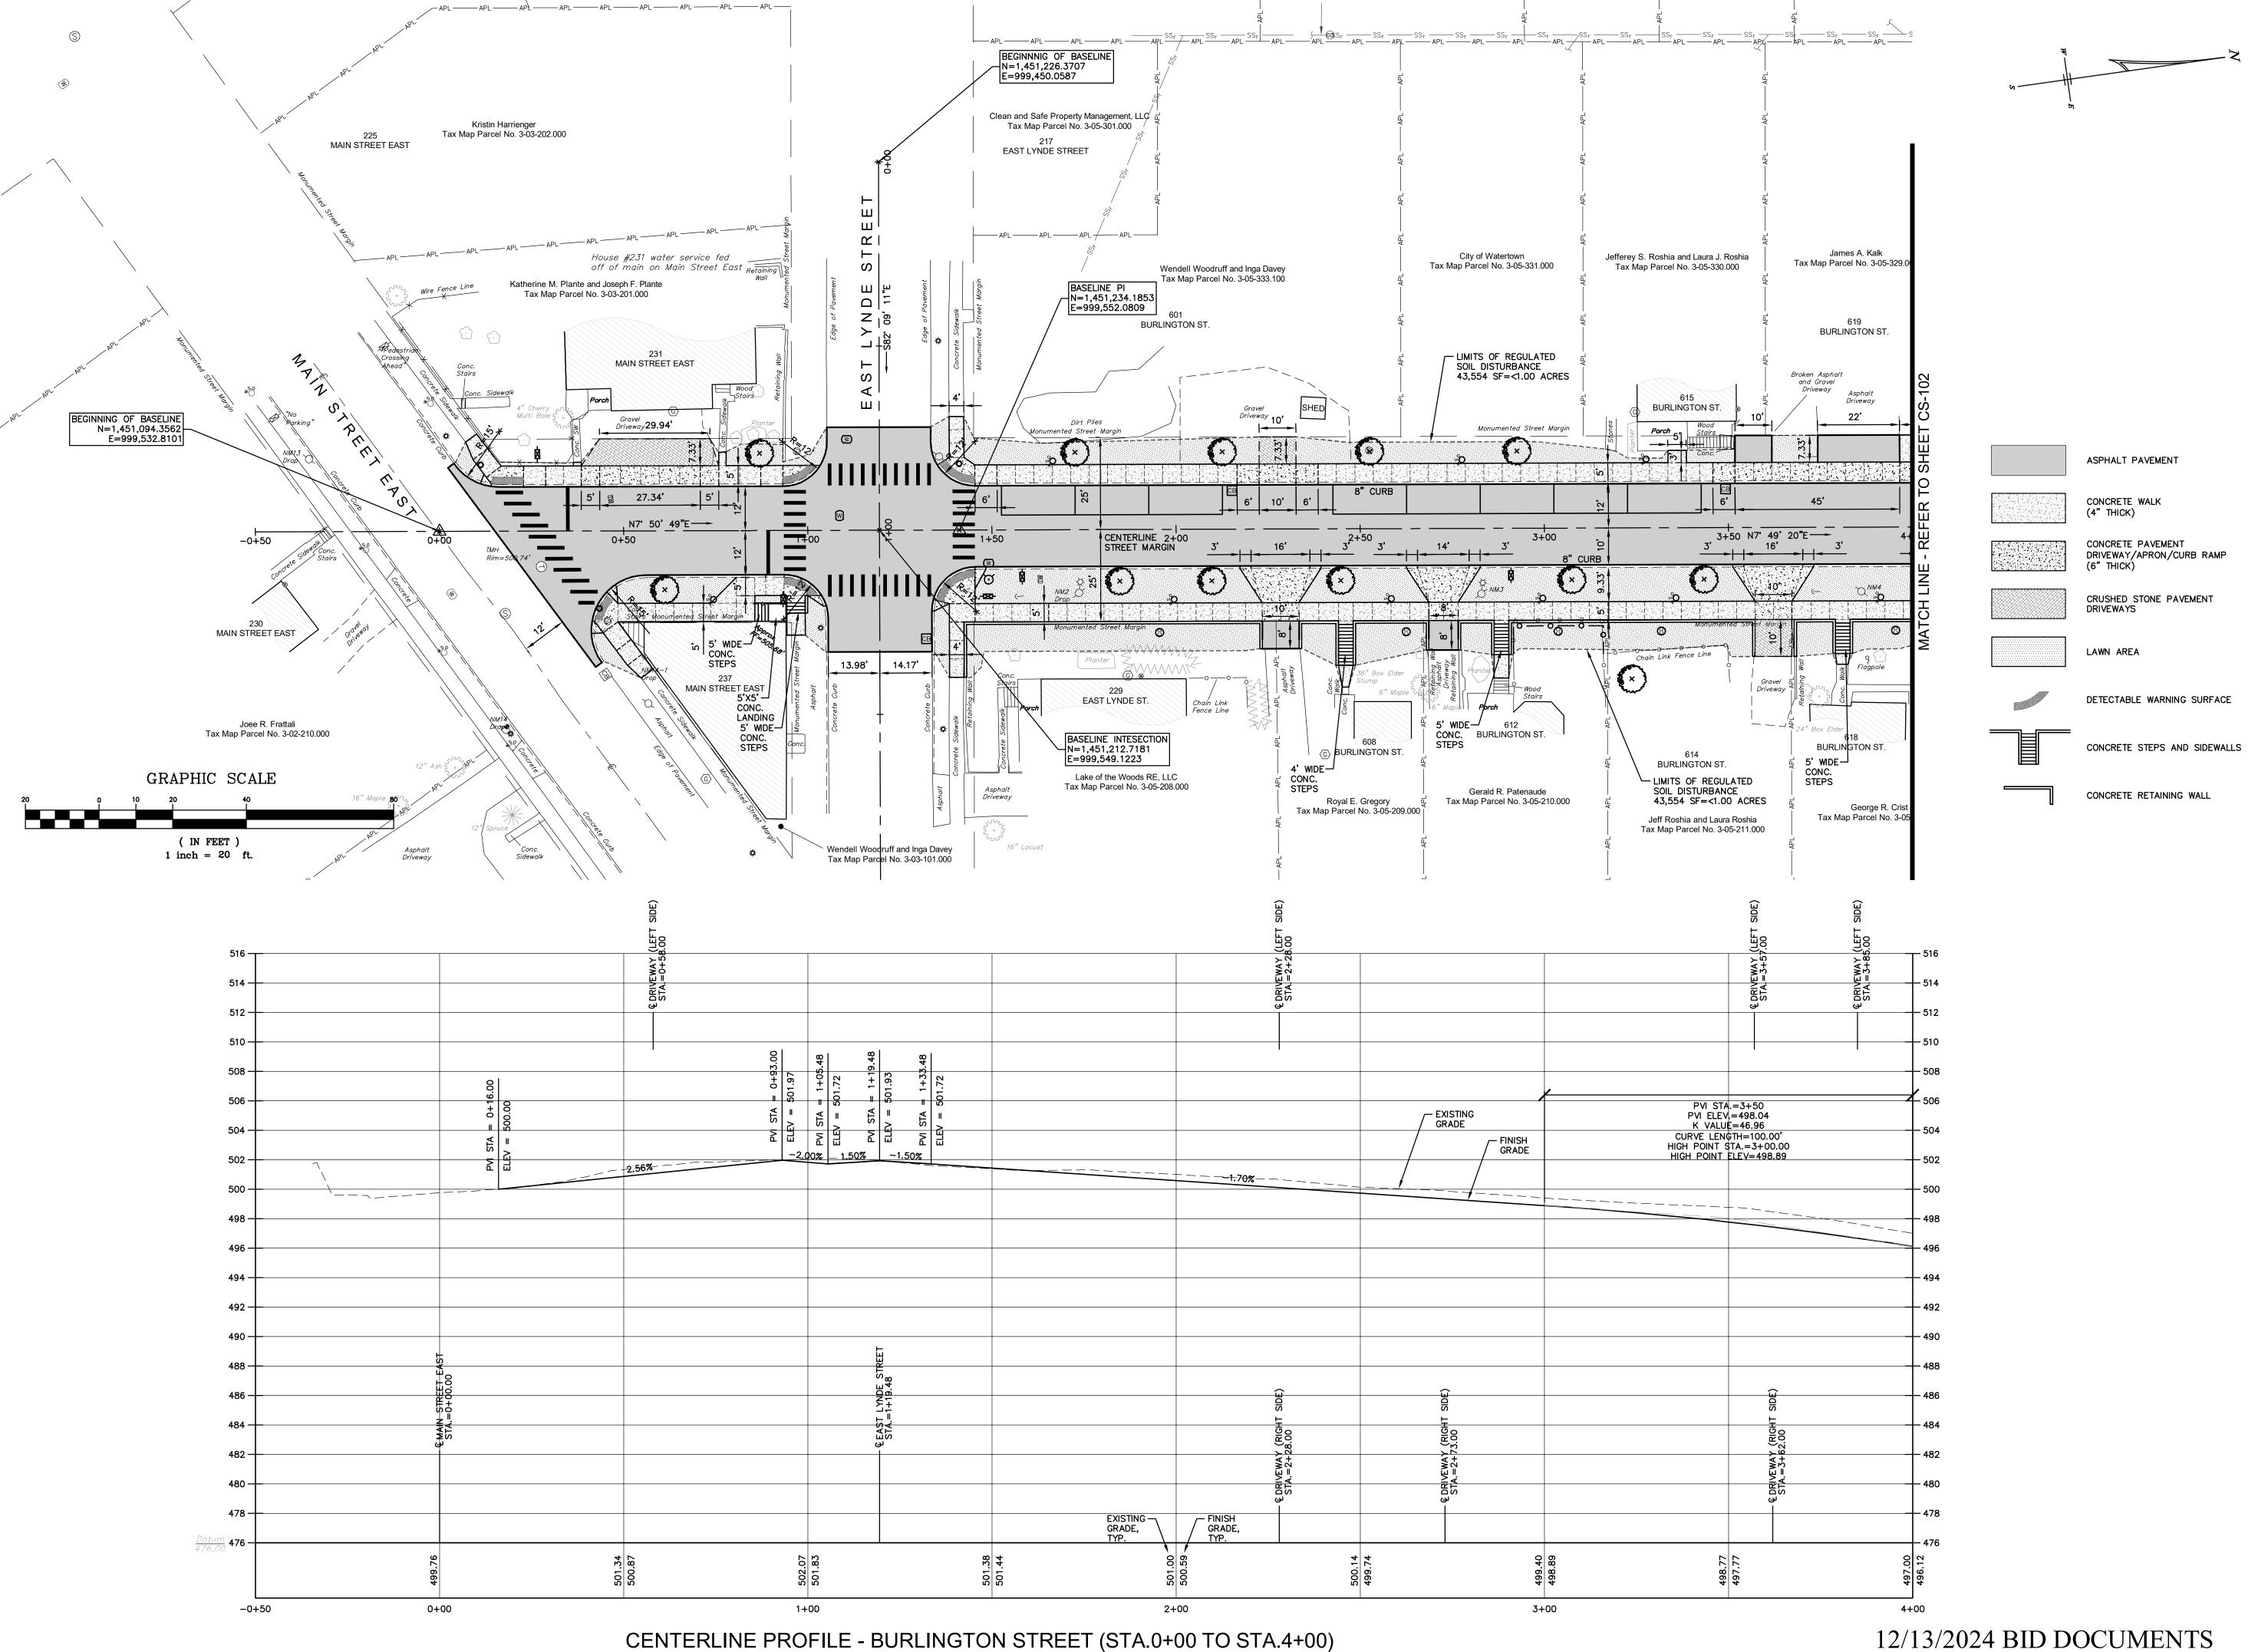
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FOR CONSTRUCTION

EXISTING CONDITIONS AND DEMOLITION PLAN



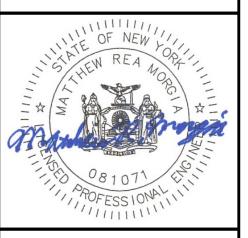
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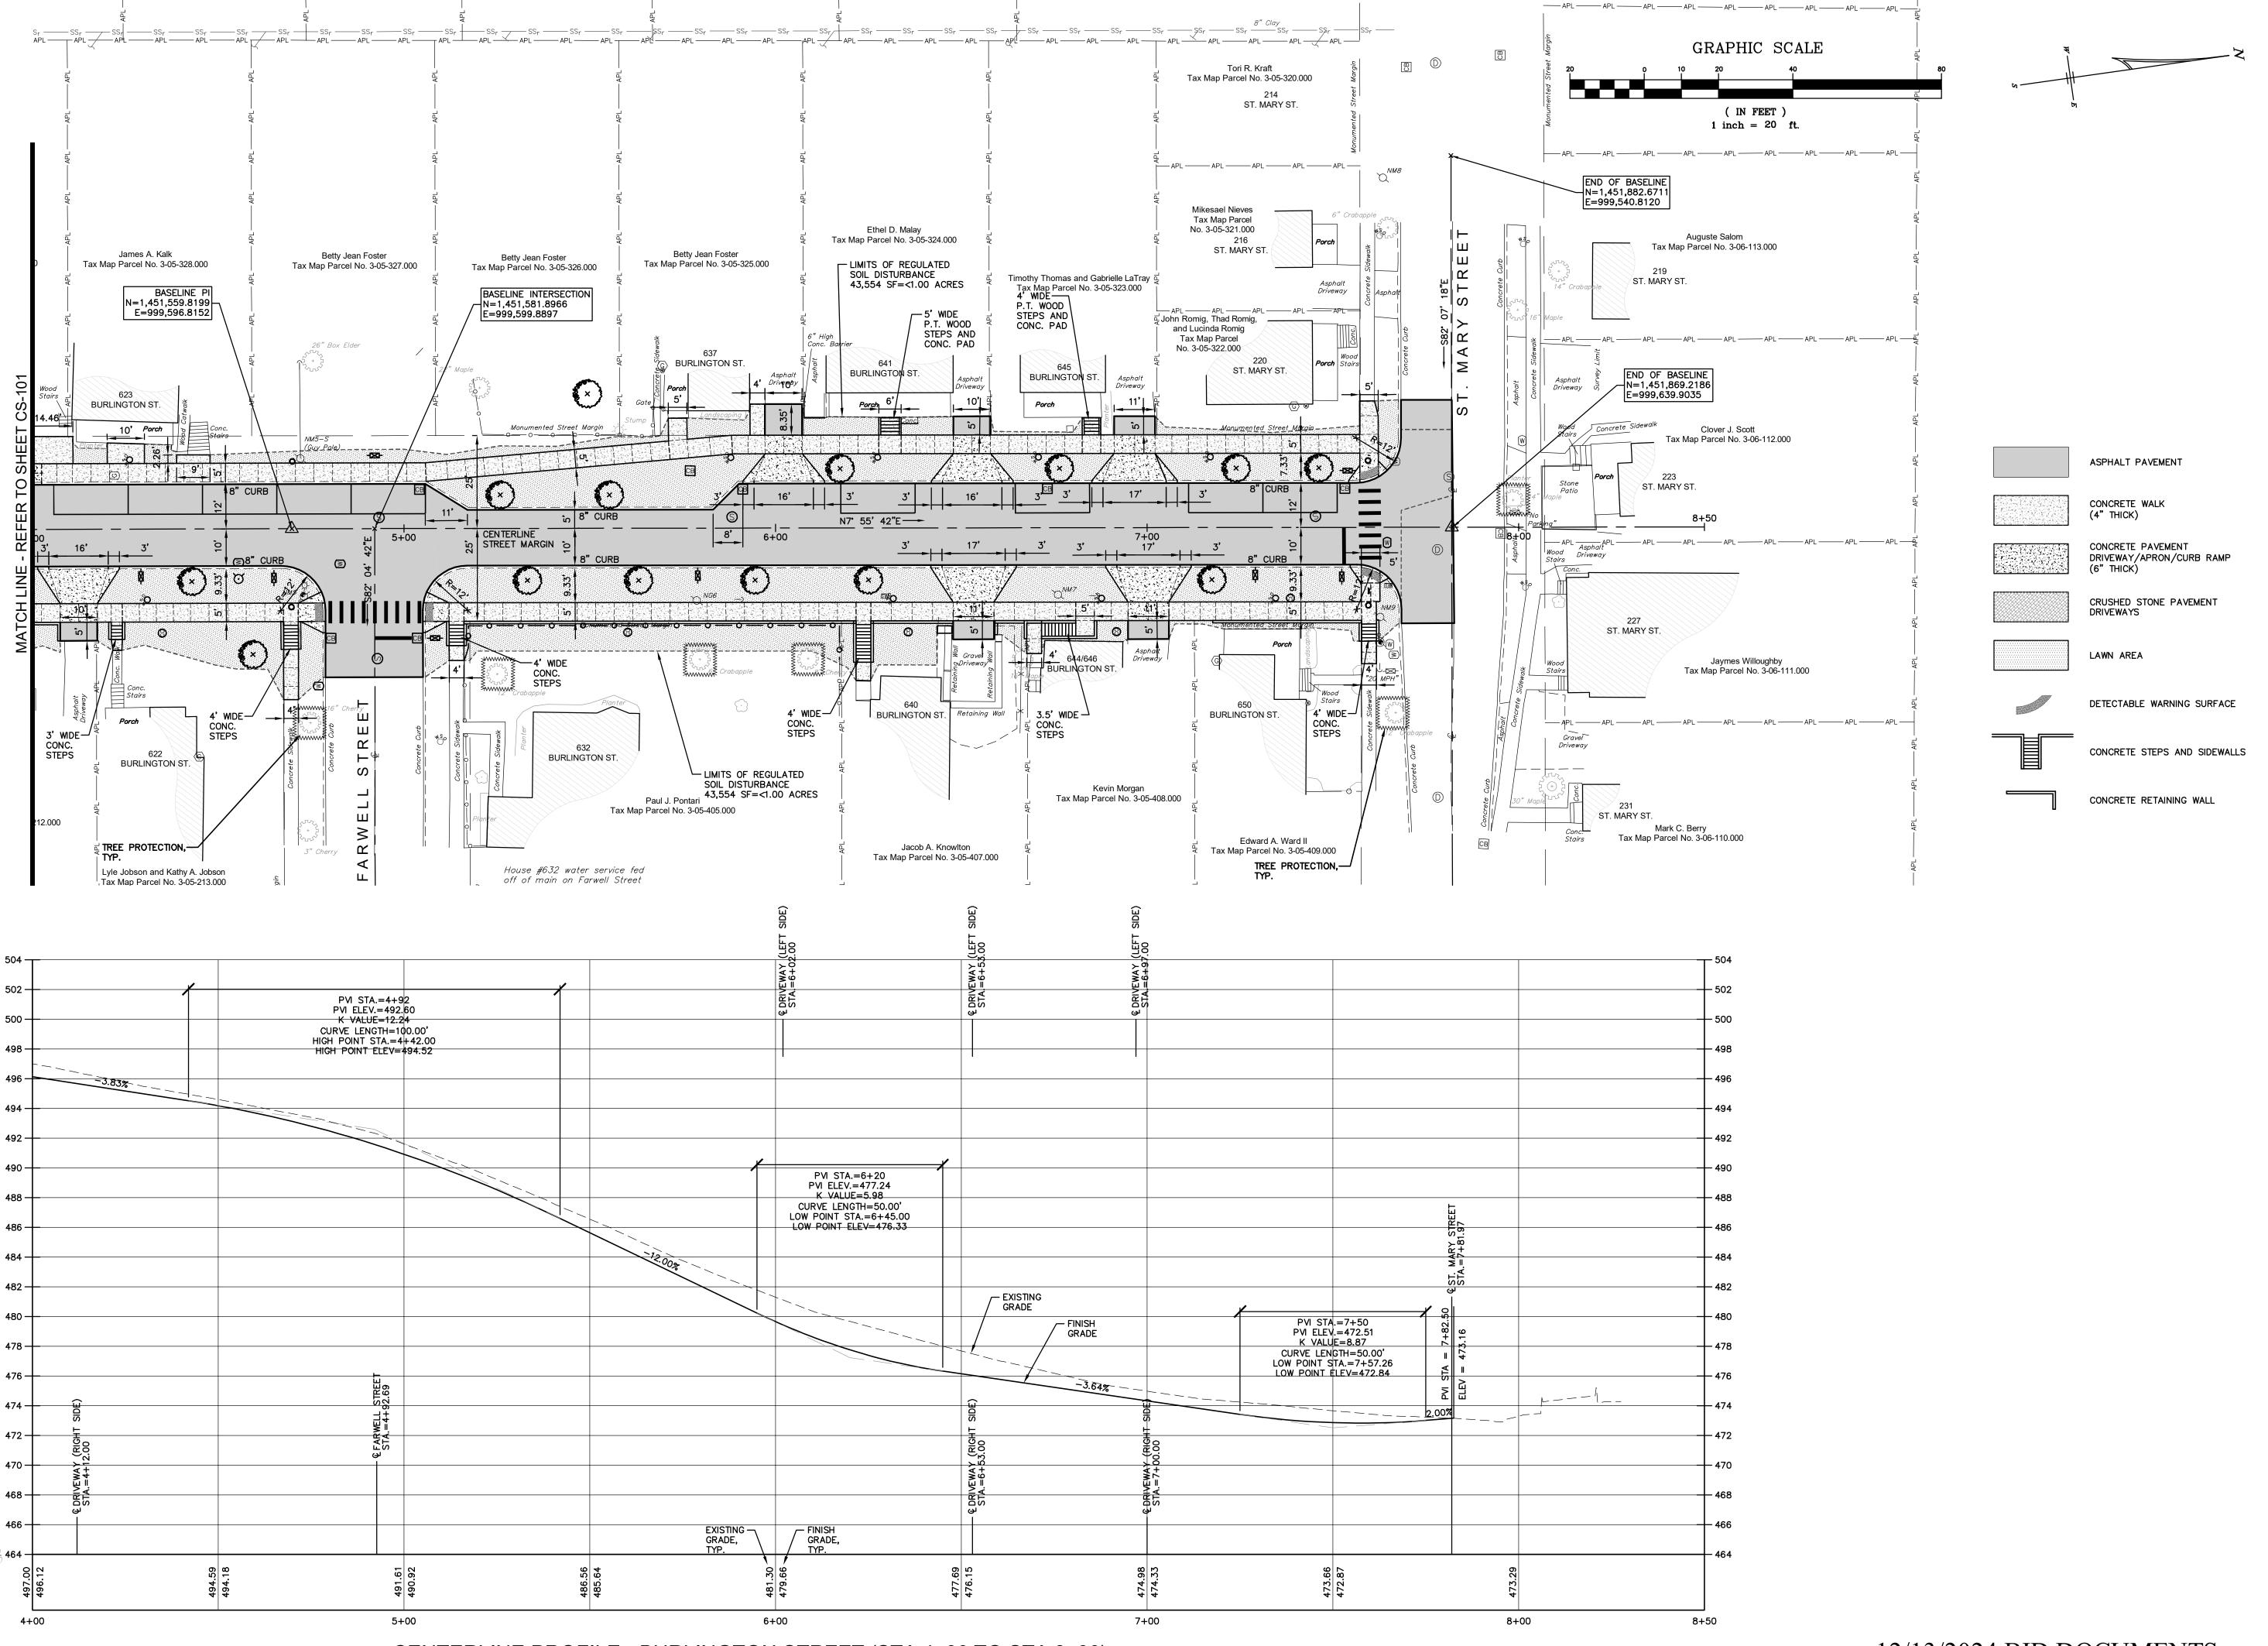
BURLINGTON STREET RECONSTRUCTION PROJE CITY OF WATERTOWN ENGINEERING DEPARTMENT JEFFERSON COUNTY, STATE OF NEW

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ISSUE DATES: 02/23/2024 04/30/2024 12/13/2024

SITE PLAN

**CS-101** 



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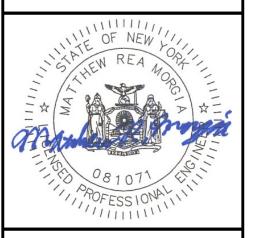
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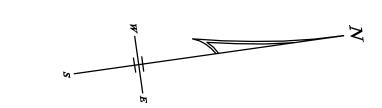
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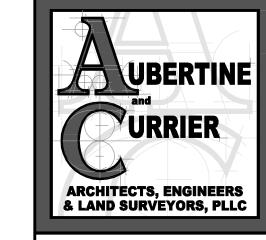
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PROJECT NO: 2023-052 DRAWN BY: TFT

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SITE PLAN

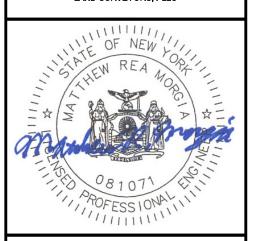




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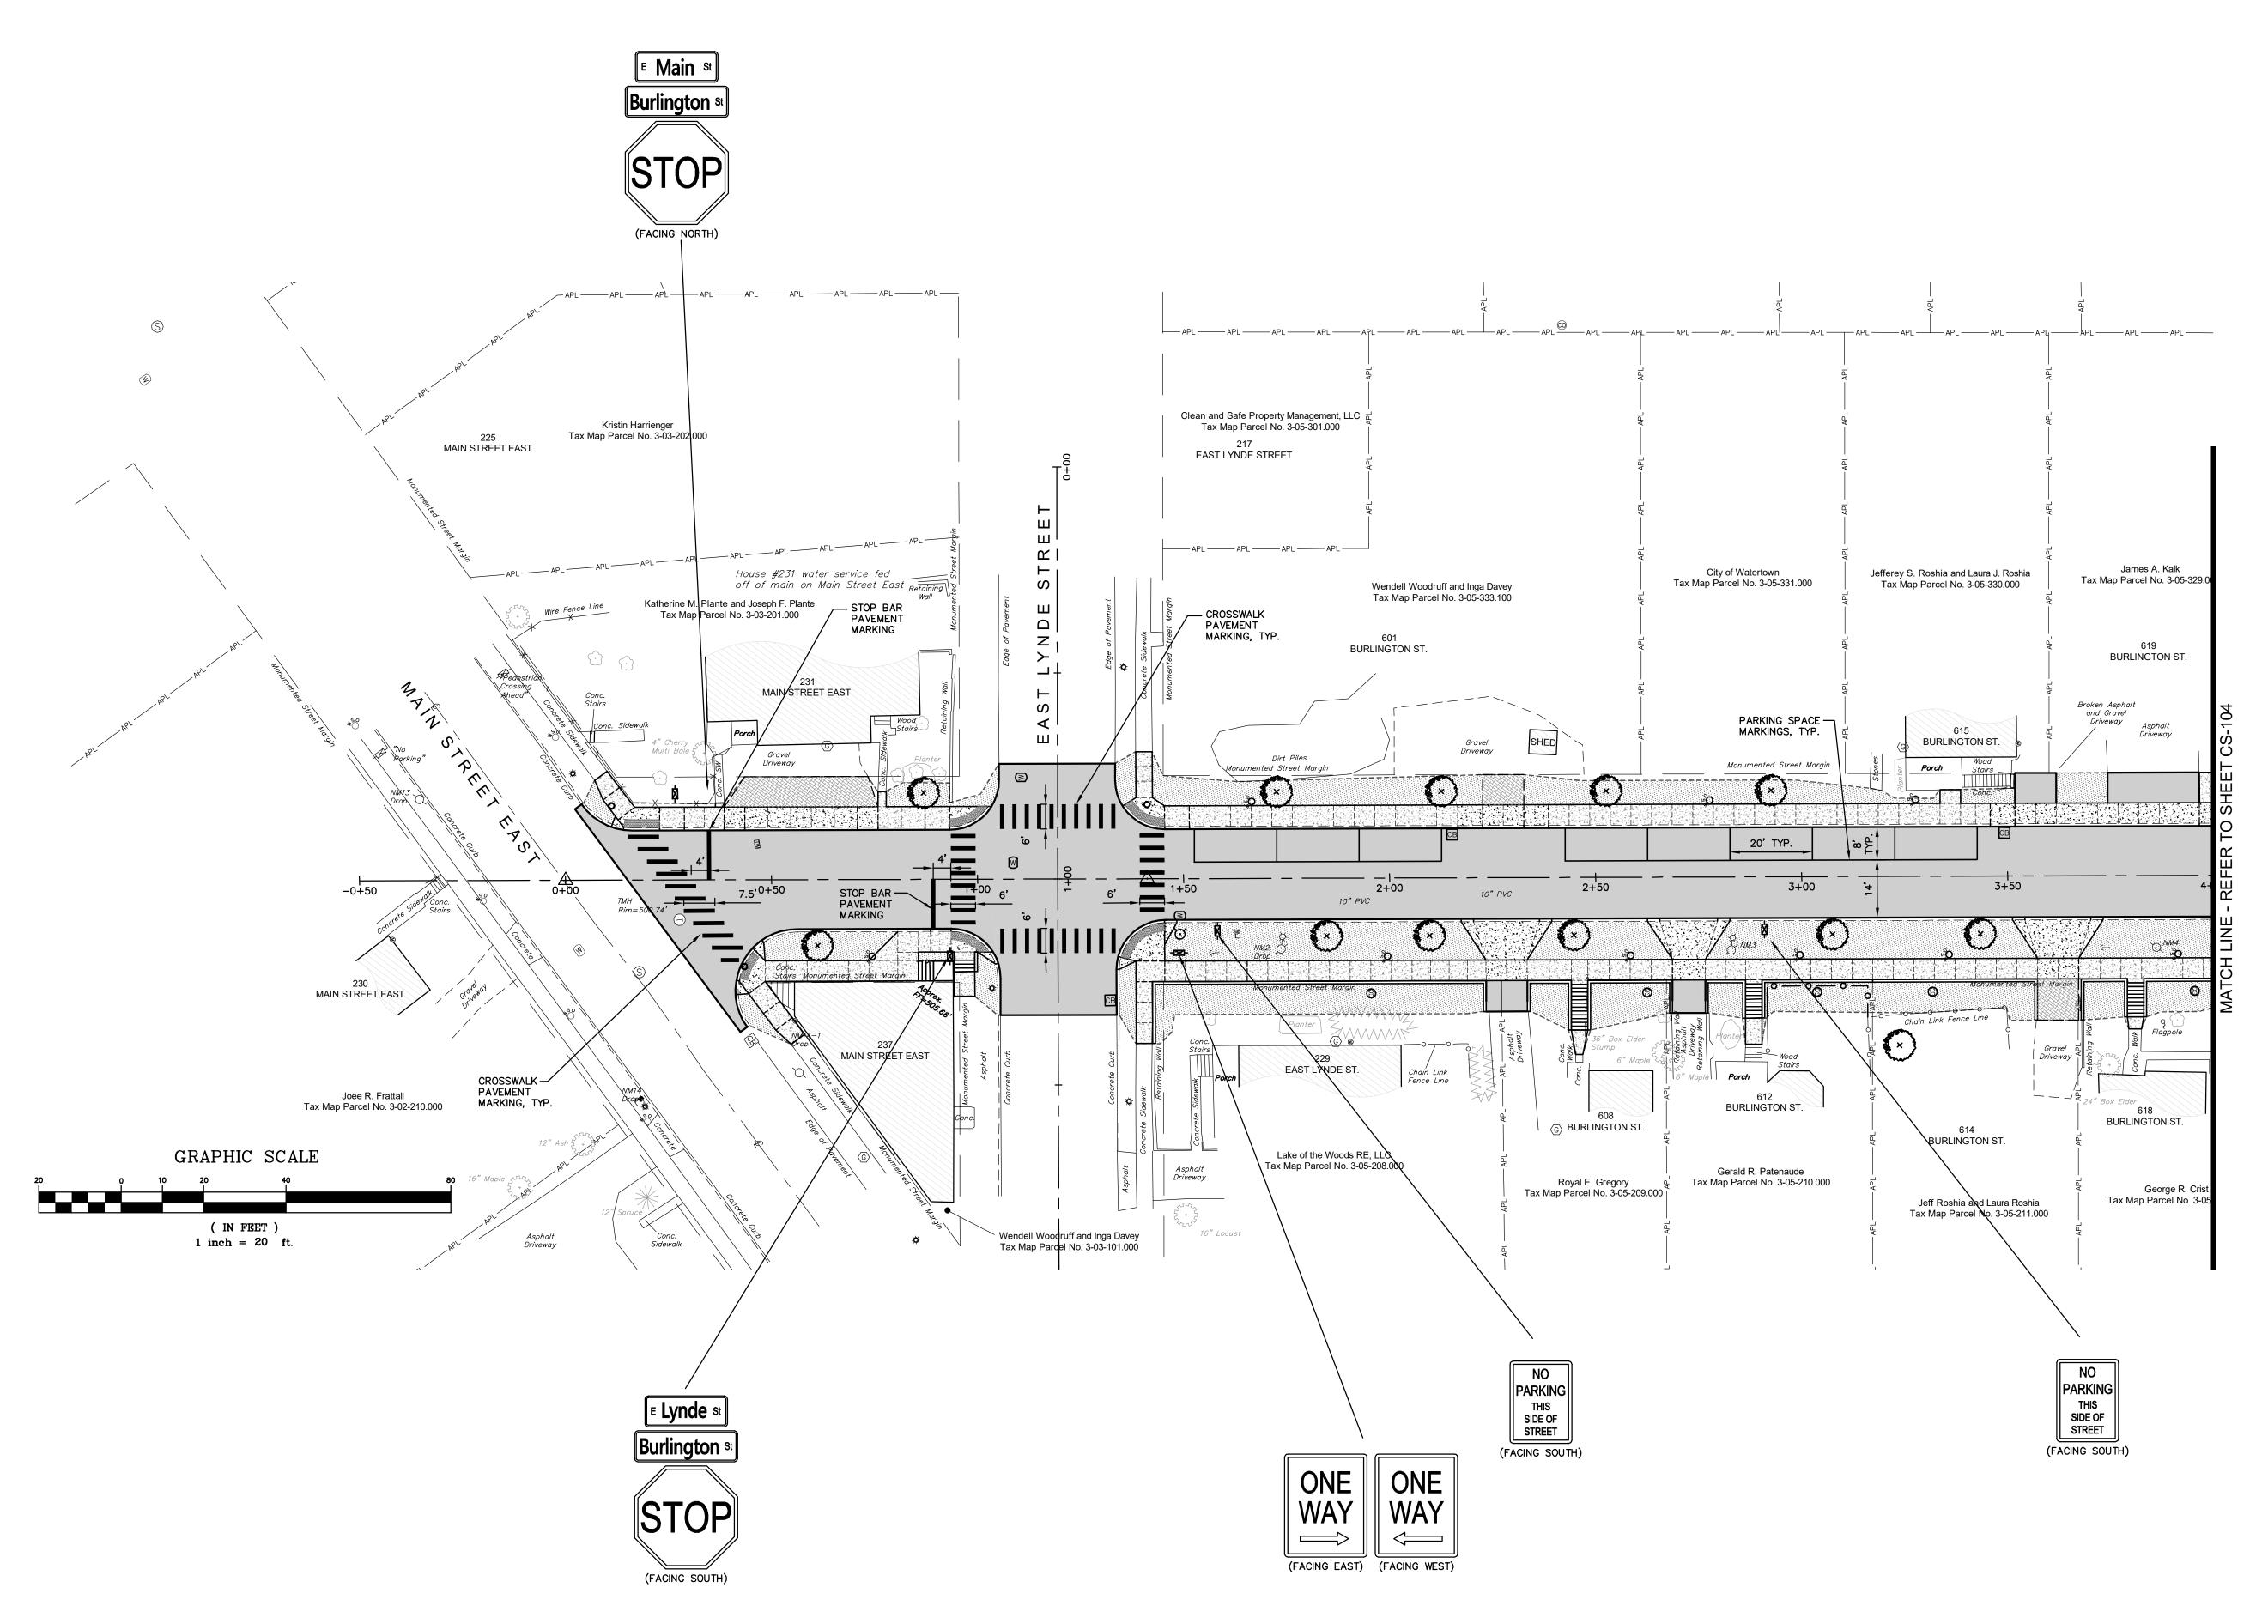
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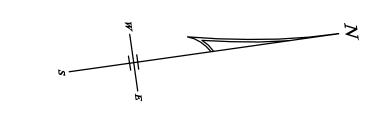
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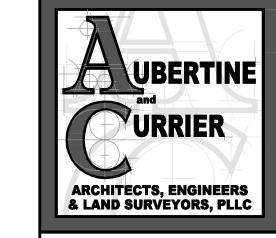
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PAVEMENT MARKINGS AND SIGNAGE PLAN







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BURLINGTON STREET RECONSTRUCTION PROJE CITY OF WA ENGINEERING JEFFERSON COUNTY, 8

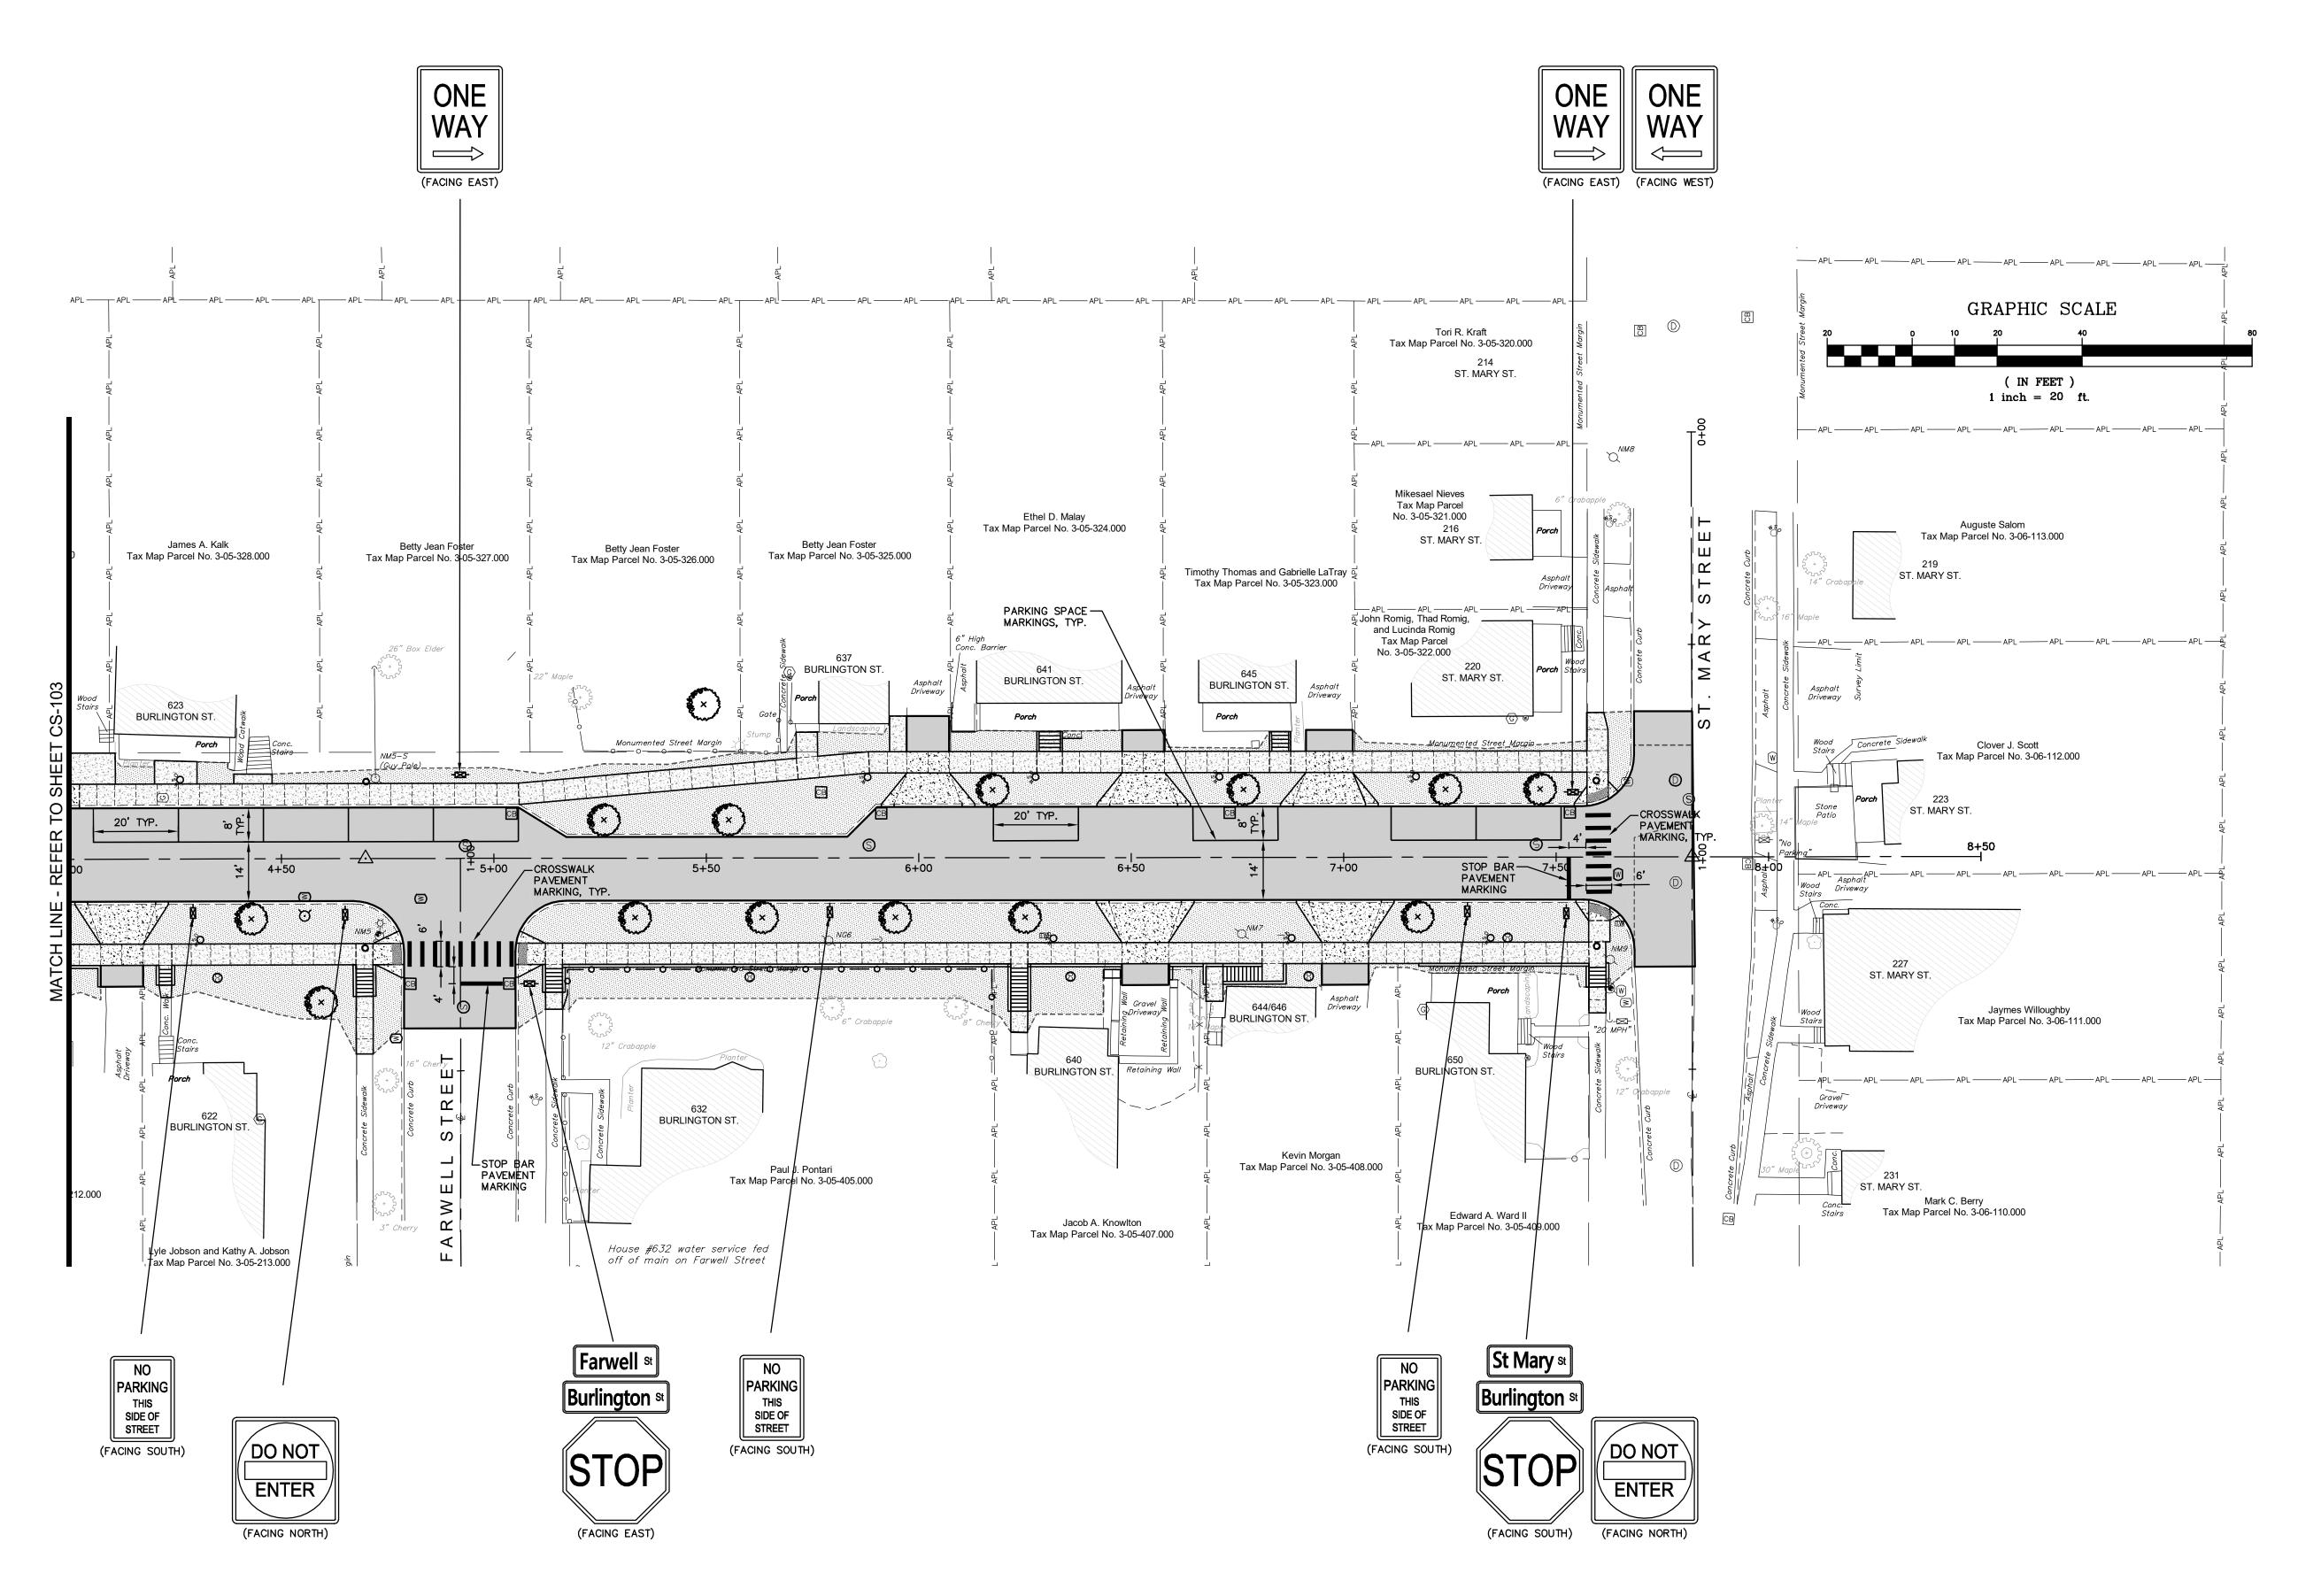
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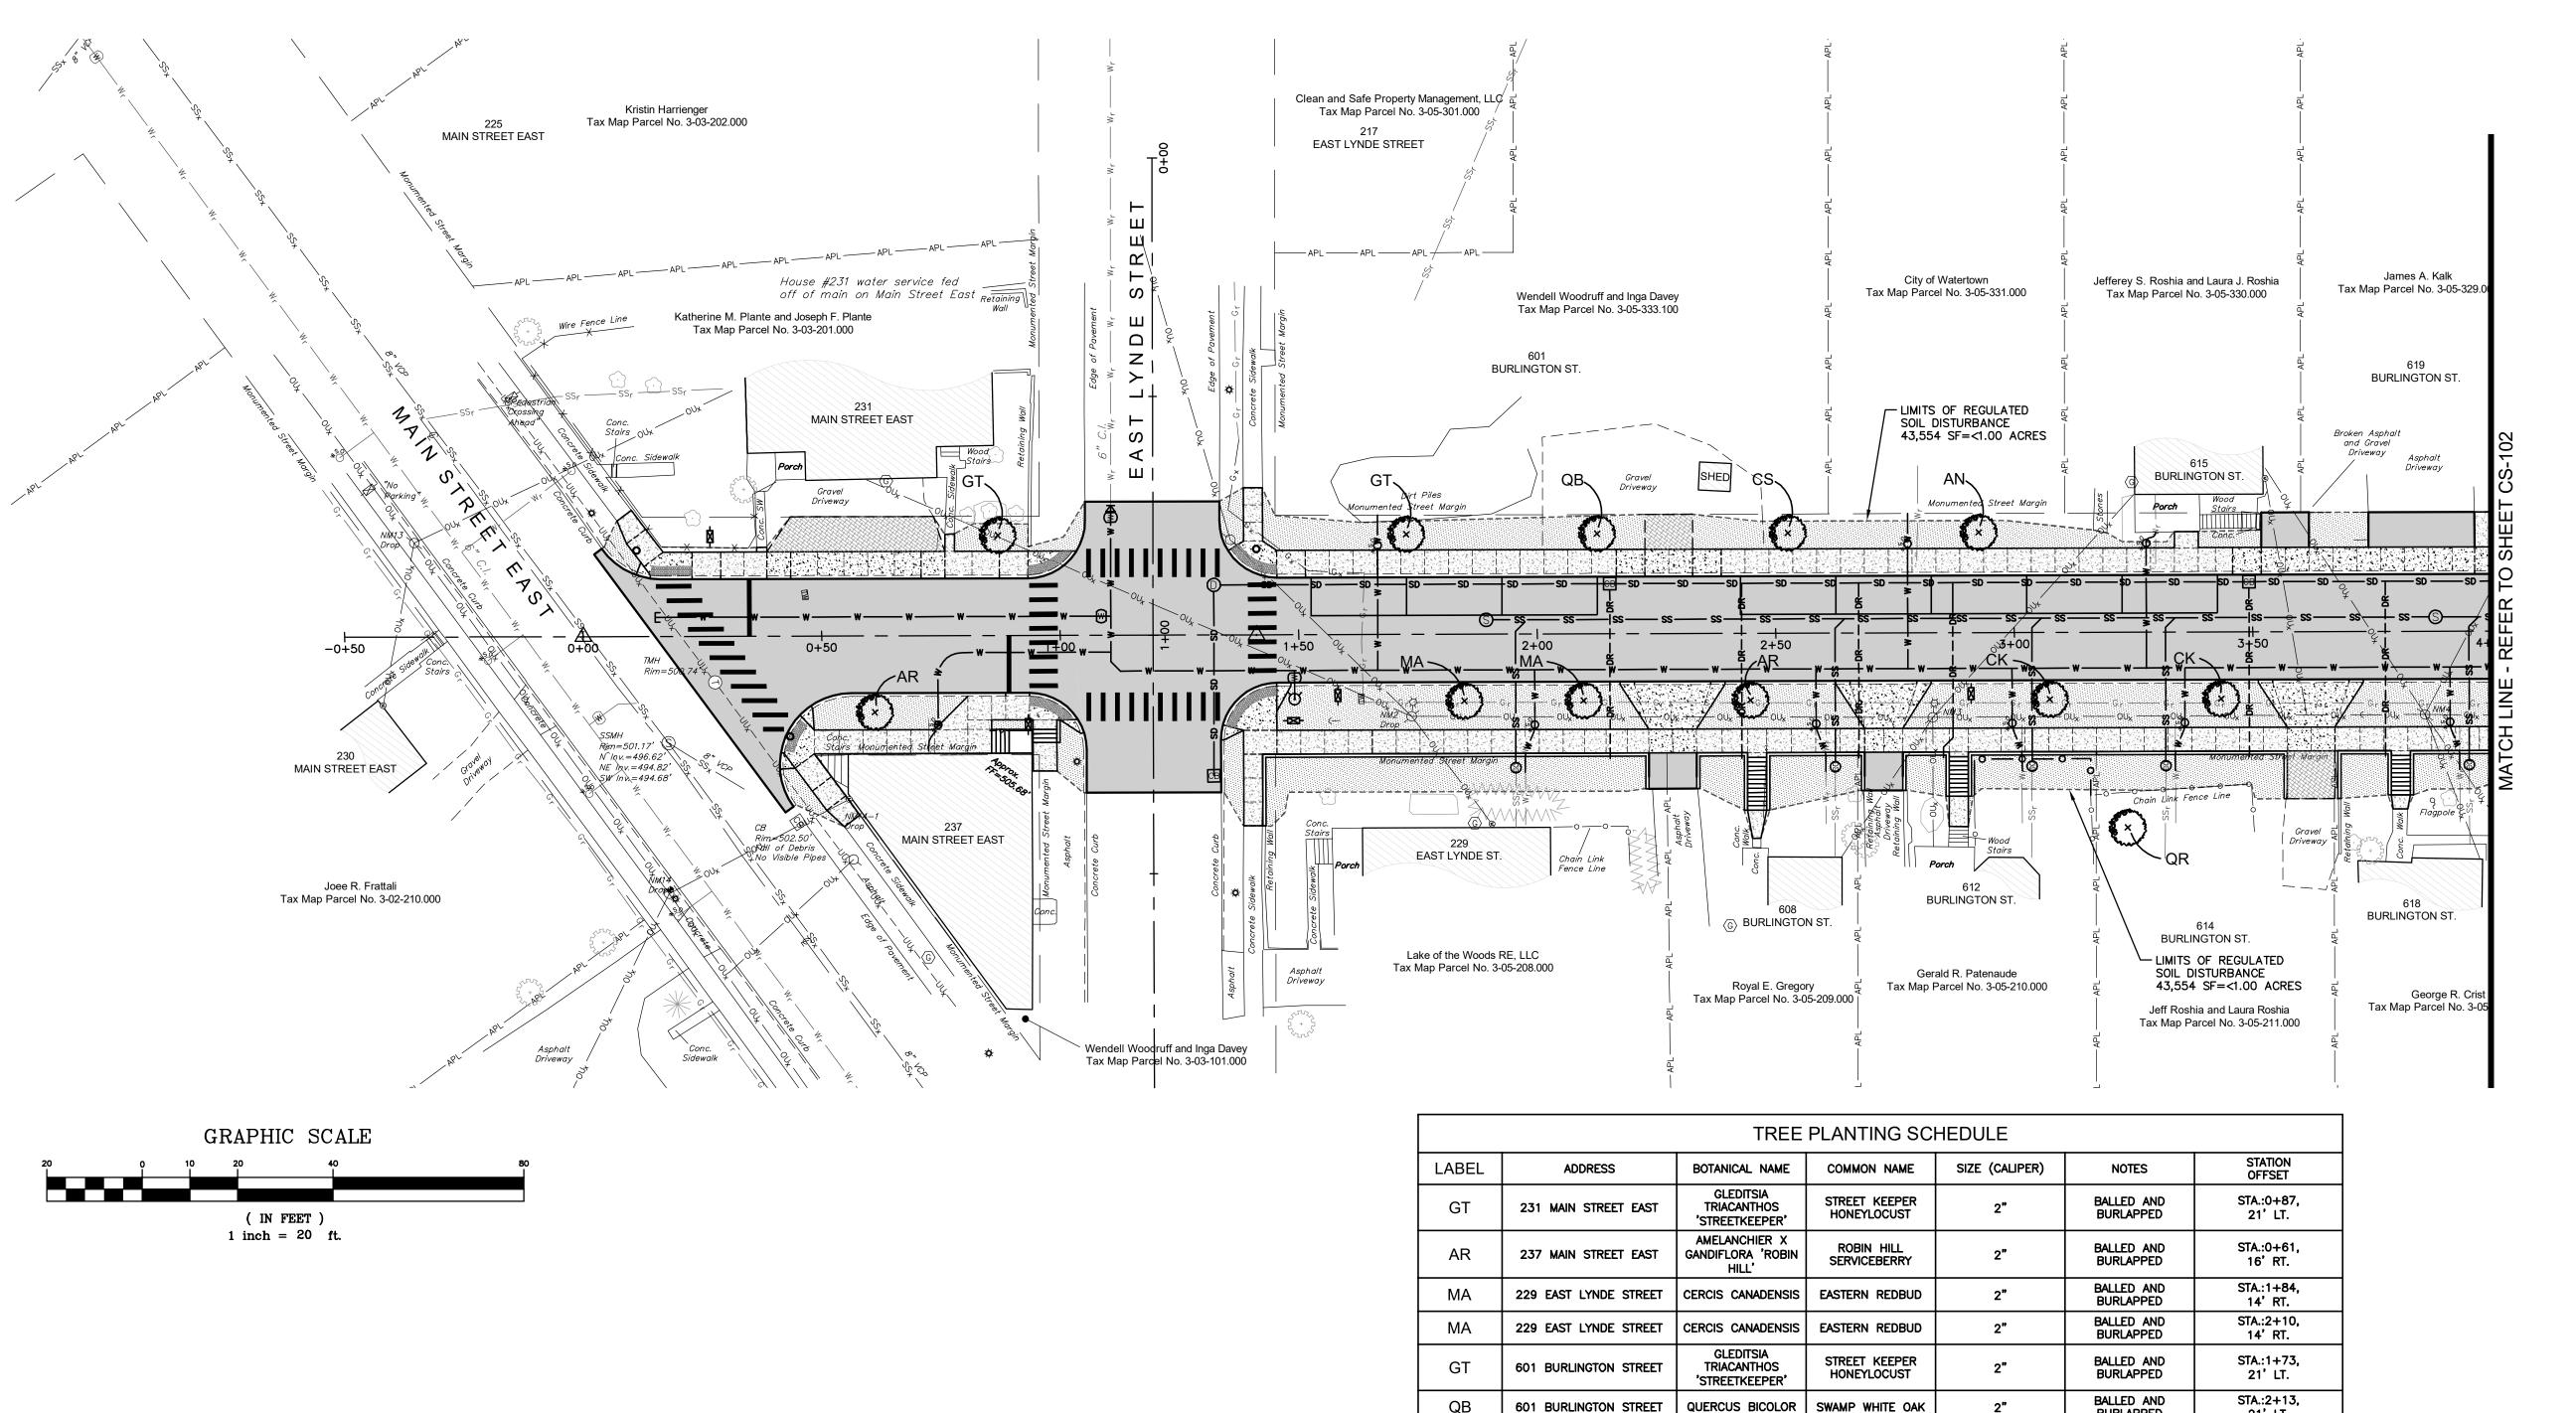
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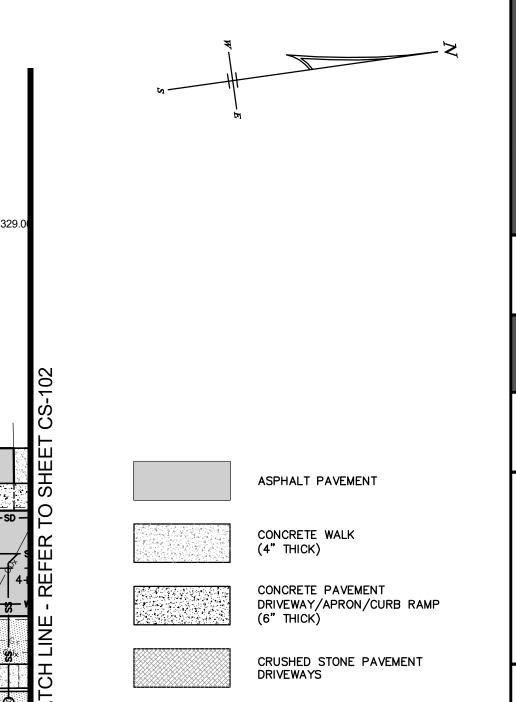
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PAVEMENT MARKINGS AND SIGNAGE PLAN







LAWN AREA

DETECTABLE WARNING SURFACE

CONCRETE STEPS AND SIDEWALLS

CONCRETE RETAINING WALL


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JEFFERSON COUNTY, STATE OF NEW YO


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> TREE PROTECTION AND PLANTING PLAN

BALLED AND BURLAPPED QUERCUS BICOLOR SWAMP WHITE OAK 21'LT. STA.:2+53, 601 BURLINGTON STREET CATALPA SPECIOSA NORTHERN CATALPA BURLAPPED 21' LT. AMELANCHIER X
GANDIFLORA 'ROBIN ROBIN HILL SERVICEBERRY BALLED AND BURLAPPED STA.:2+44, 608 BURLINGTON STREET 14' RT. BALLED AND BURLAPPED STA.:2+93, BURLINGTON STREET ACER NIGRUM BLACK MAPLE 21'LT. STA.:3+07, CADRASTIS KENTUKEA CK 612 BURLINGTON STREET YELLOWWOOD BURLAPPED STA.:3+43, 14' RT. CADRASTIS KENTUKEA BALLED AND BURLAPPED CK 614 BURLINGTON STREET YELLOWWOOD QUERCUS X MACDANIELII STA.:3+24, 614 BURLINGTON STREET HERITAGE OAK 41' RT. 'CLEMONS' ADRIONDACK CRABAPPLE BALLED AND BURLAPPED STA.:4+43, MA 622 BURLINGTON STREET 'ADRIONDACK' 214' RT. STA.:4+59, 34'RT. CITY SPRITE ZELKOVA BALLED AND BURLAPPED 622 BURLINGTON STREET ZELKOVA SERRATA PRUNUS SARGENTII
' PINK FLAIR' PINK FLAIR SARGENT CHERRY BALLED AND BURLAPPED STA.:5+33, 632 BURLINGTON STREET PINK FLAIR SARGENT CHERRY PRUNUS SARGENTII STA.:5+63, 632 BURLINGTON STREET ' PINK FLAIR' BURLAPPED 14' RT. BALLED AND BURLAPPED STA.:5+94, 632 BURLINGTON STREET CERCIS CANADENSIS EASTERN REDBUD BALLED AND BURLAPPED STA.:6+25, 640 BURLINGTON STREET CC CERCIS CANADENSIS EASTERN REDBUD 14'RT. BALLED AND BURLAPPED STA.:5+49, 637 BURLINGTON STREET ACER NIGRUM BLACK MAPLE 36' LT. PLATANUS X ACERIFOLIA EXCLAIMATION BALLED AND STA.:5+26, 637 BURLINGTON STREET BURLAPPED 9' LT. LONDON PLANE 'EXCLAIMATION' PLATANUS X ACERIFOLIA STA.:5+55, **EXCLAIMATION** BALLED AND 637 BURLINGTON STREET LONDON PLANE BURLAPPED 9'LT. 'EXCLAIMATION' ACER FREEMANII
'MARMO' STA.:6+17, 641 BURLINGTON STREET MAPLE BURLAPPED 16'LT. BALLED AND BURLAPPED STA.:6+76, TΑ 645 BURLINGTON STREET BOULEVARD LINDEN 'BOULEVARD' 16' LT. AMELANCHIER X ROBIN HILL SERVICEBERRY STA.:7+17, 14'RT. BALLED AND BURLAPPED 650 BURLINGTON STREET GANDIFLORA 'ROBIN HILL' STA.:7+24, 16'LT. QUERCUS IMBRICARIA BALLED AND BURLAPPED 220 ST. MARY STREET SHINGLE OAK GLEDITSIA TRIACANTHOS STA.:7+46, 16'LT. STREET KEEPER HONEYLOCUST BALLED AND BURLAPPED GT 220 ST. MARY STREET

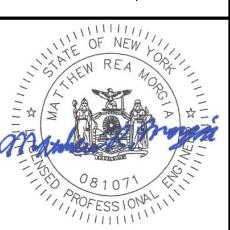
'STREETKEEPER'




GRAPHIC SCALE

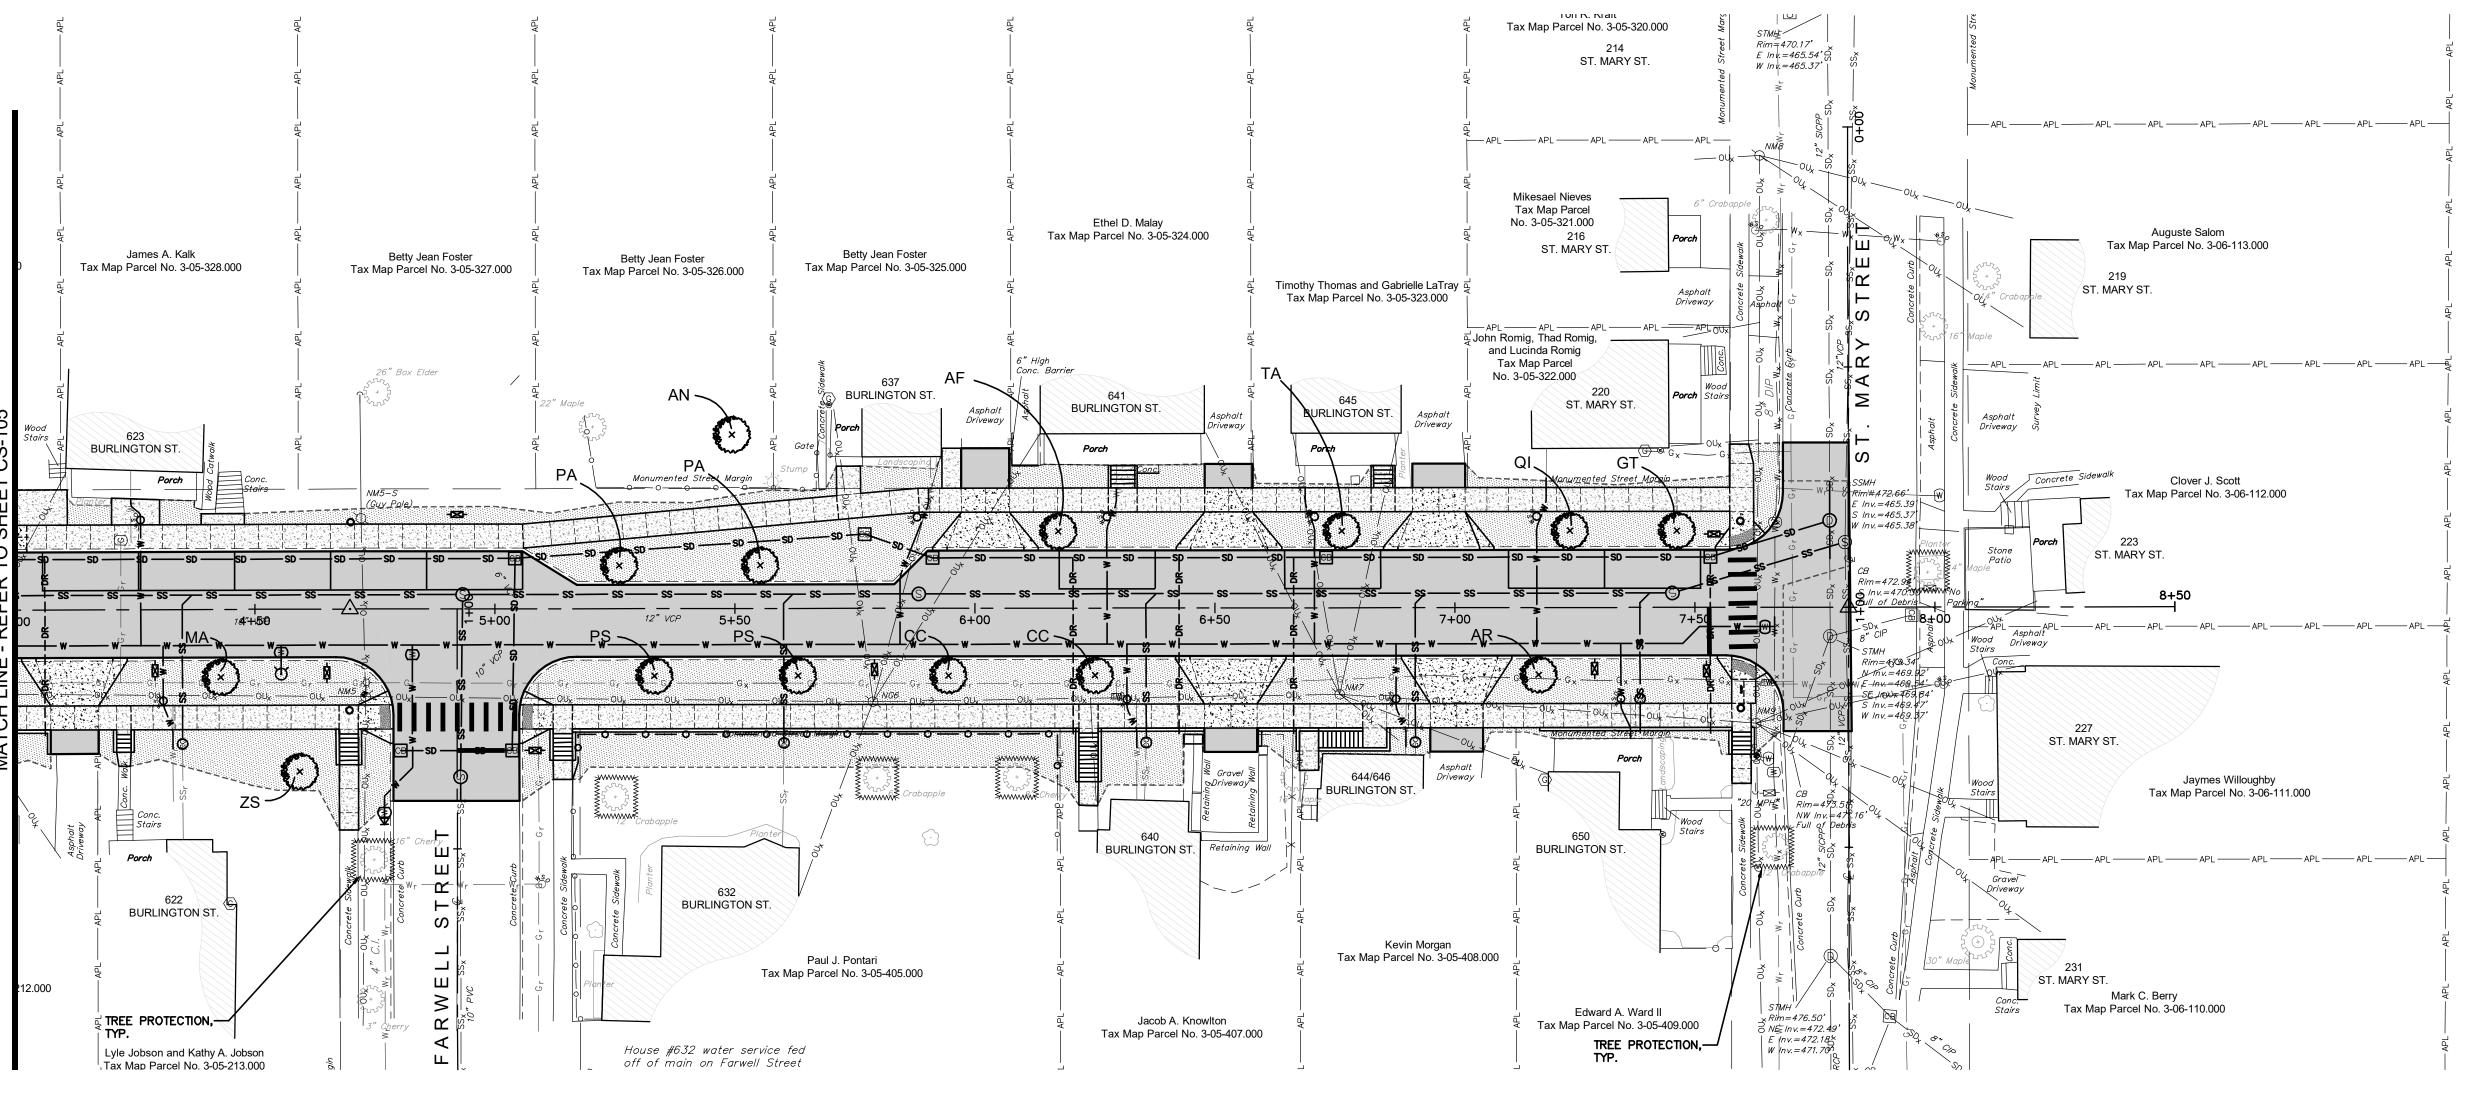( IN FEET )

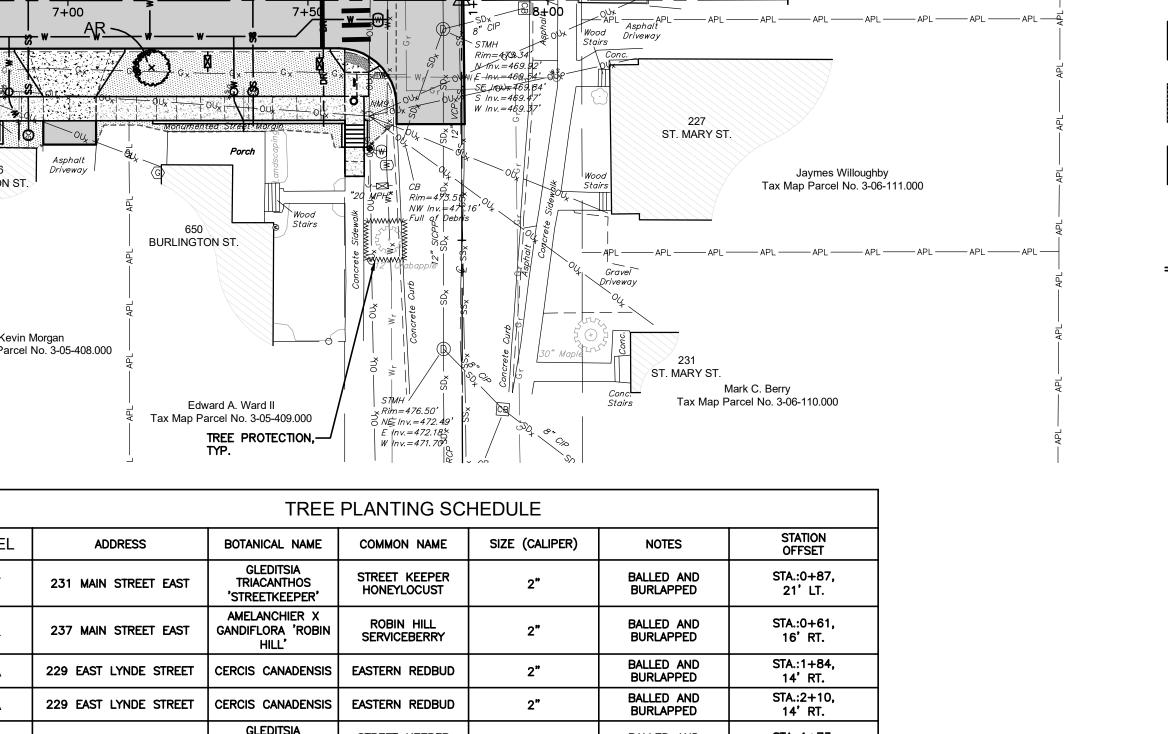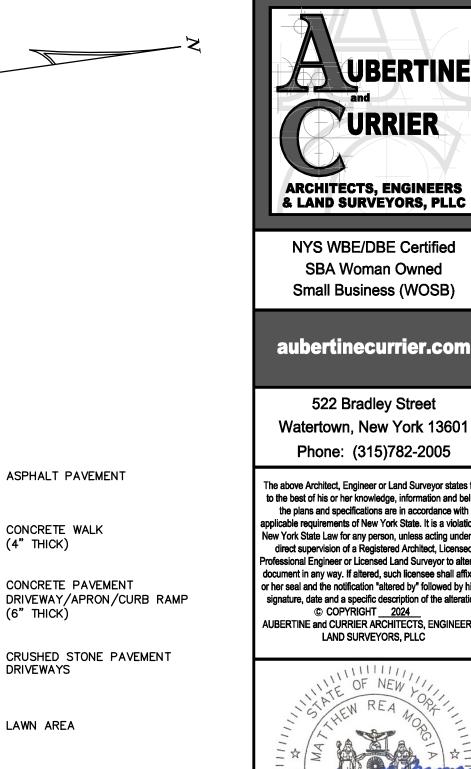1 inch = 20 ft.





DETECTABLE WARNING SURFACE

CONCRETE STEPS AND SIDEWALLS

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ENGINEERING DEPARTMENT
JEFFERSON COUNTY, STATE OF NEW YO


PROJECT NO: 2023-052

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ISSUE DATES: 02/23/2024 04/30/2024 12/13/2024 TREE PROTECTION AND

PLANTING PLAN

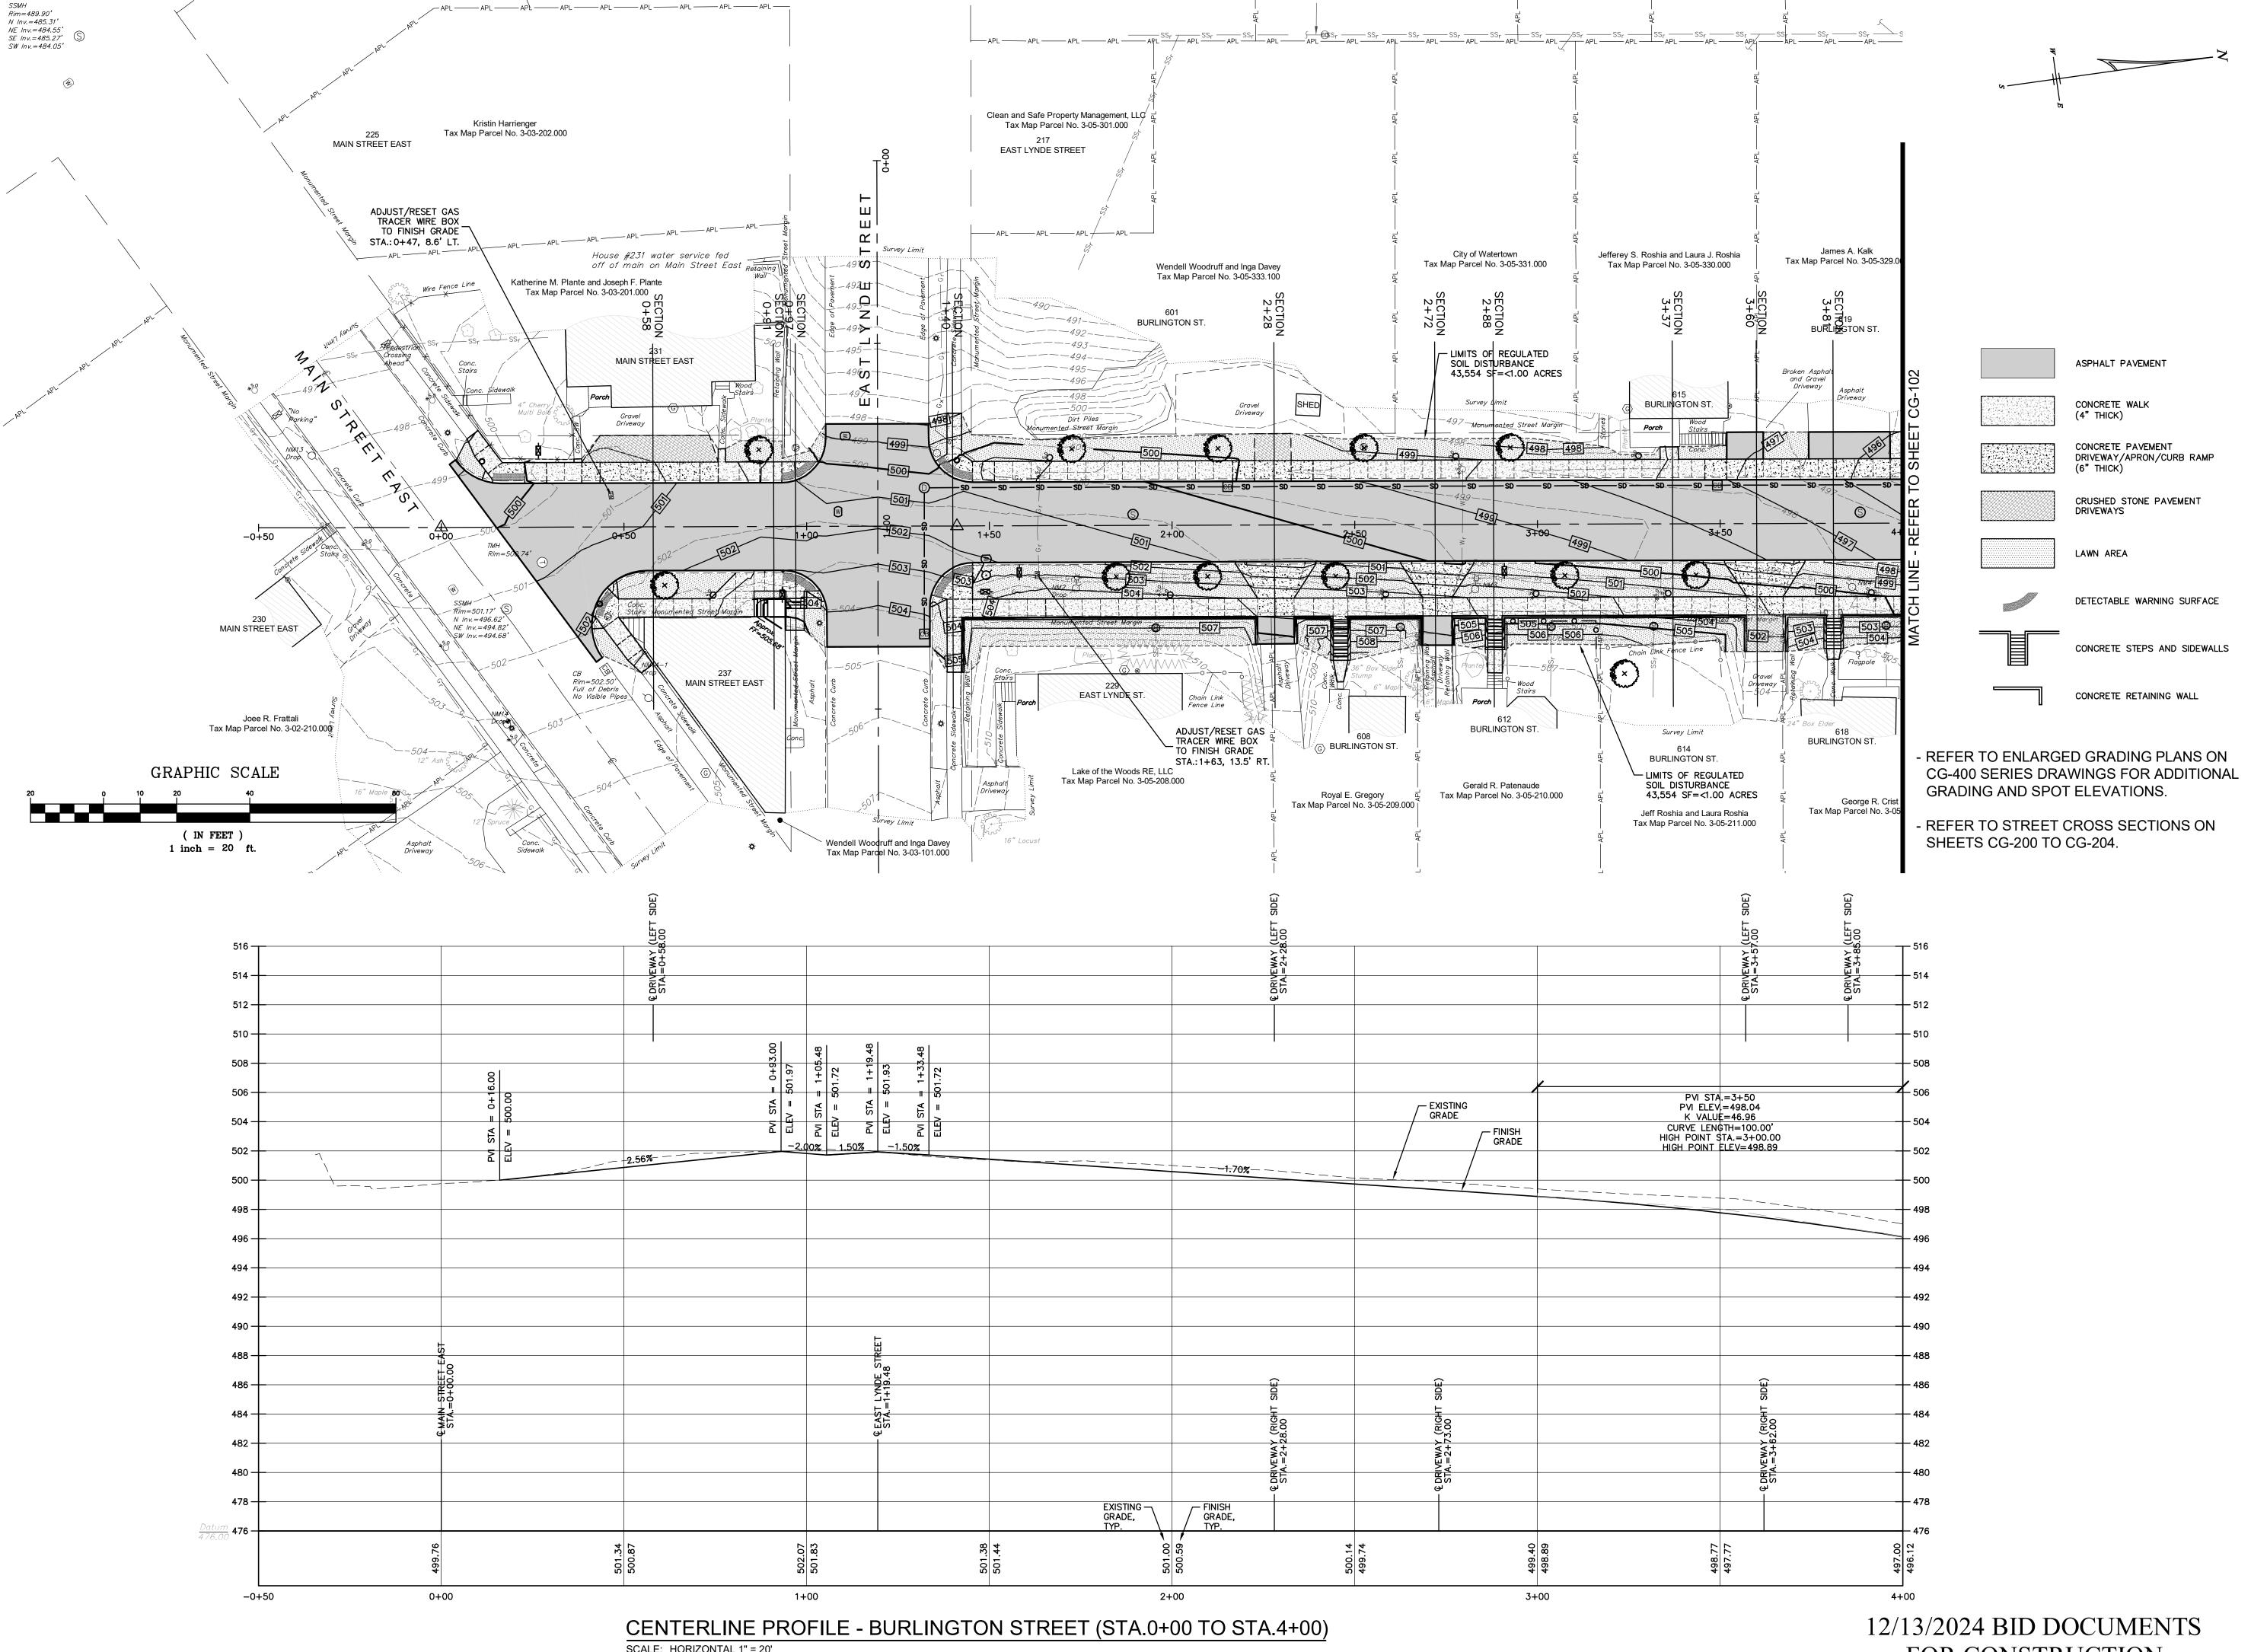'STREETKEEPER'



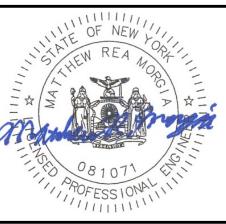
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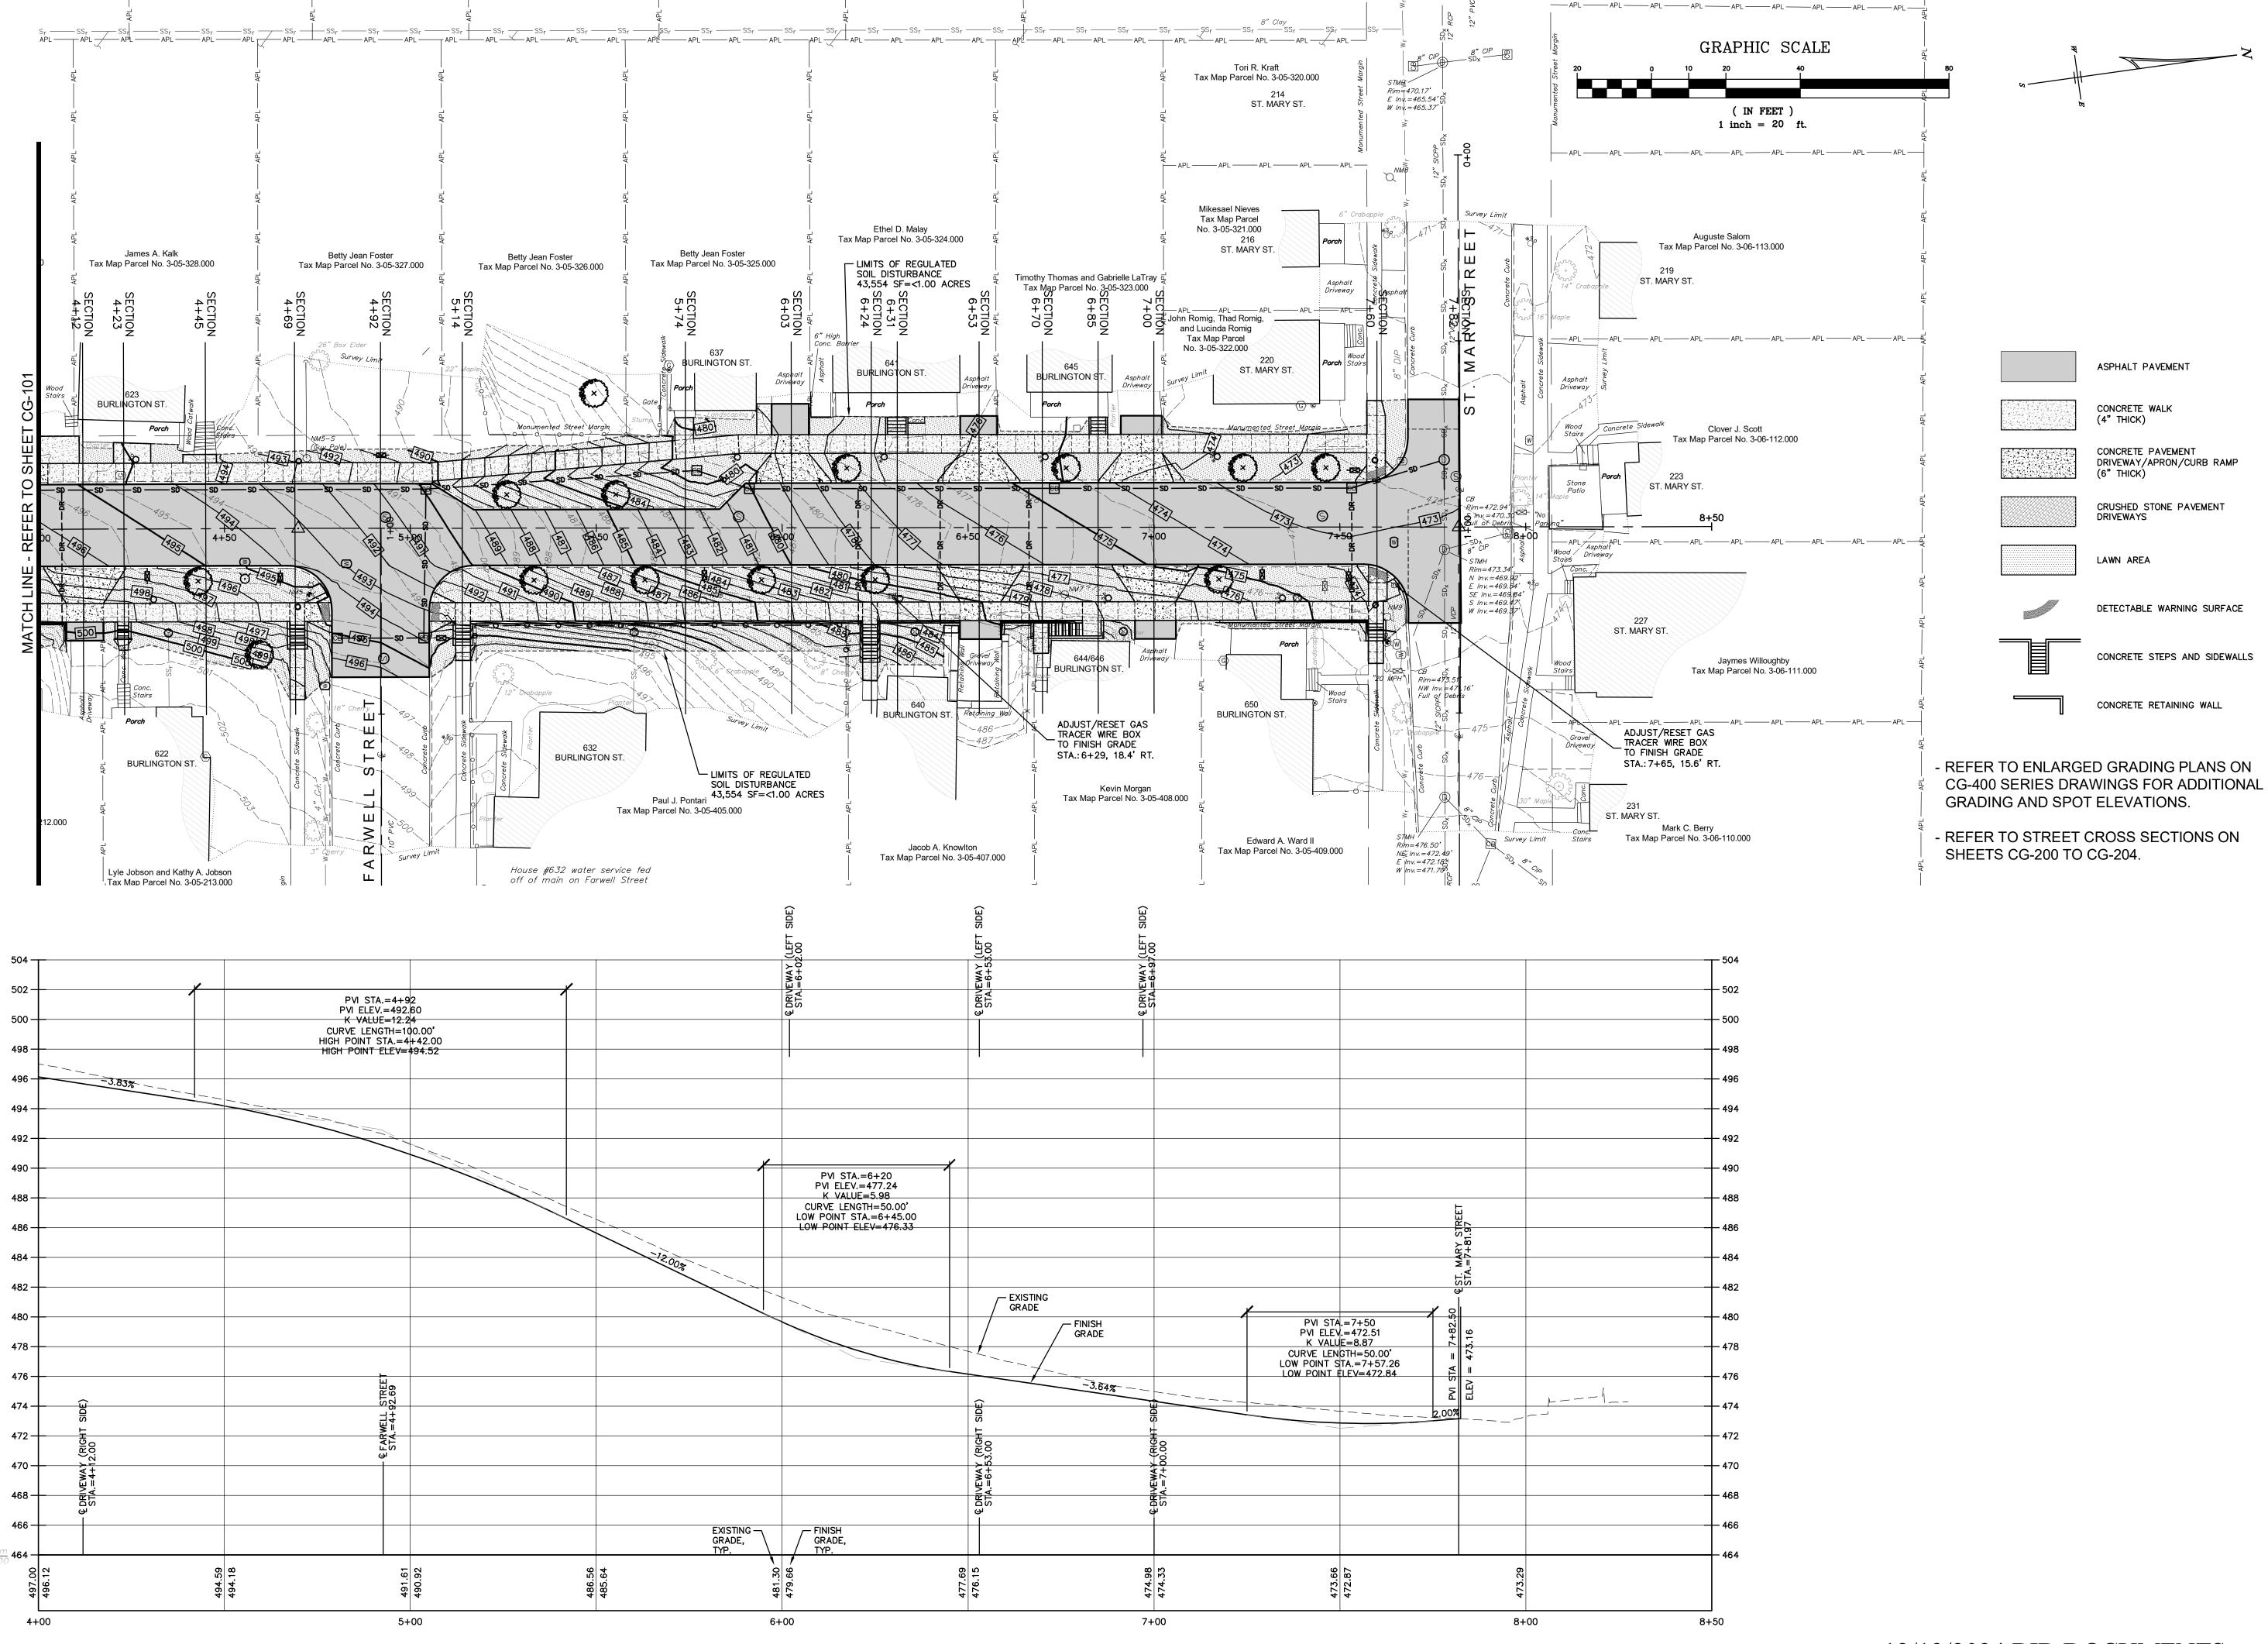
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BURLINGTON STREET
RECONSTRUCTION PROJE CITY OF WATERTOWN ENGINEERING DEPARTMENT JEFFERSON COUNTY, STATE OF NEW

PROJECT NO: 2023-052

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> **GRADING PLAN AND CENTERLINE PROFILE**



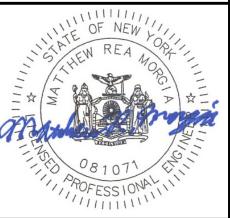
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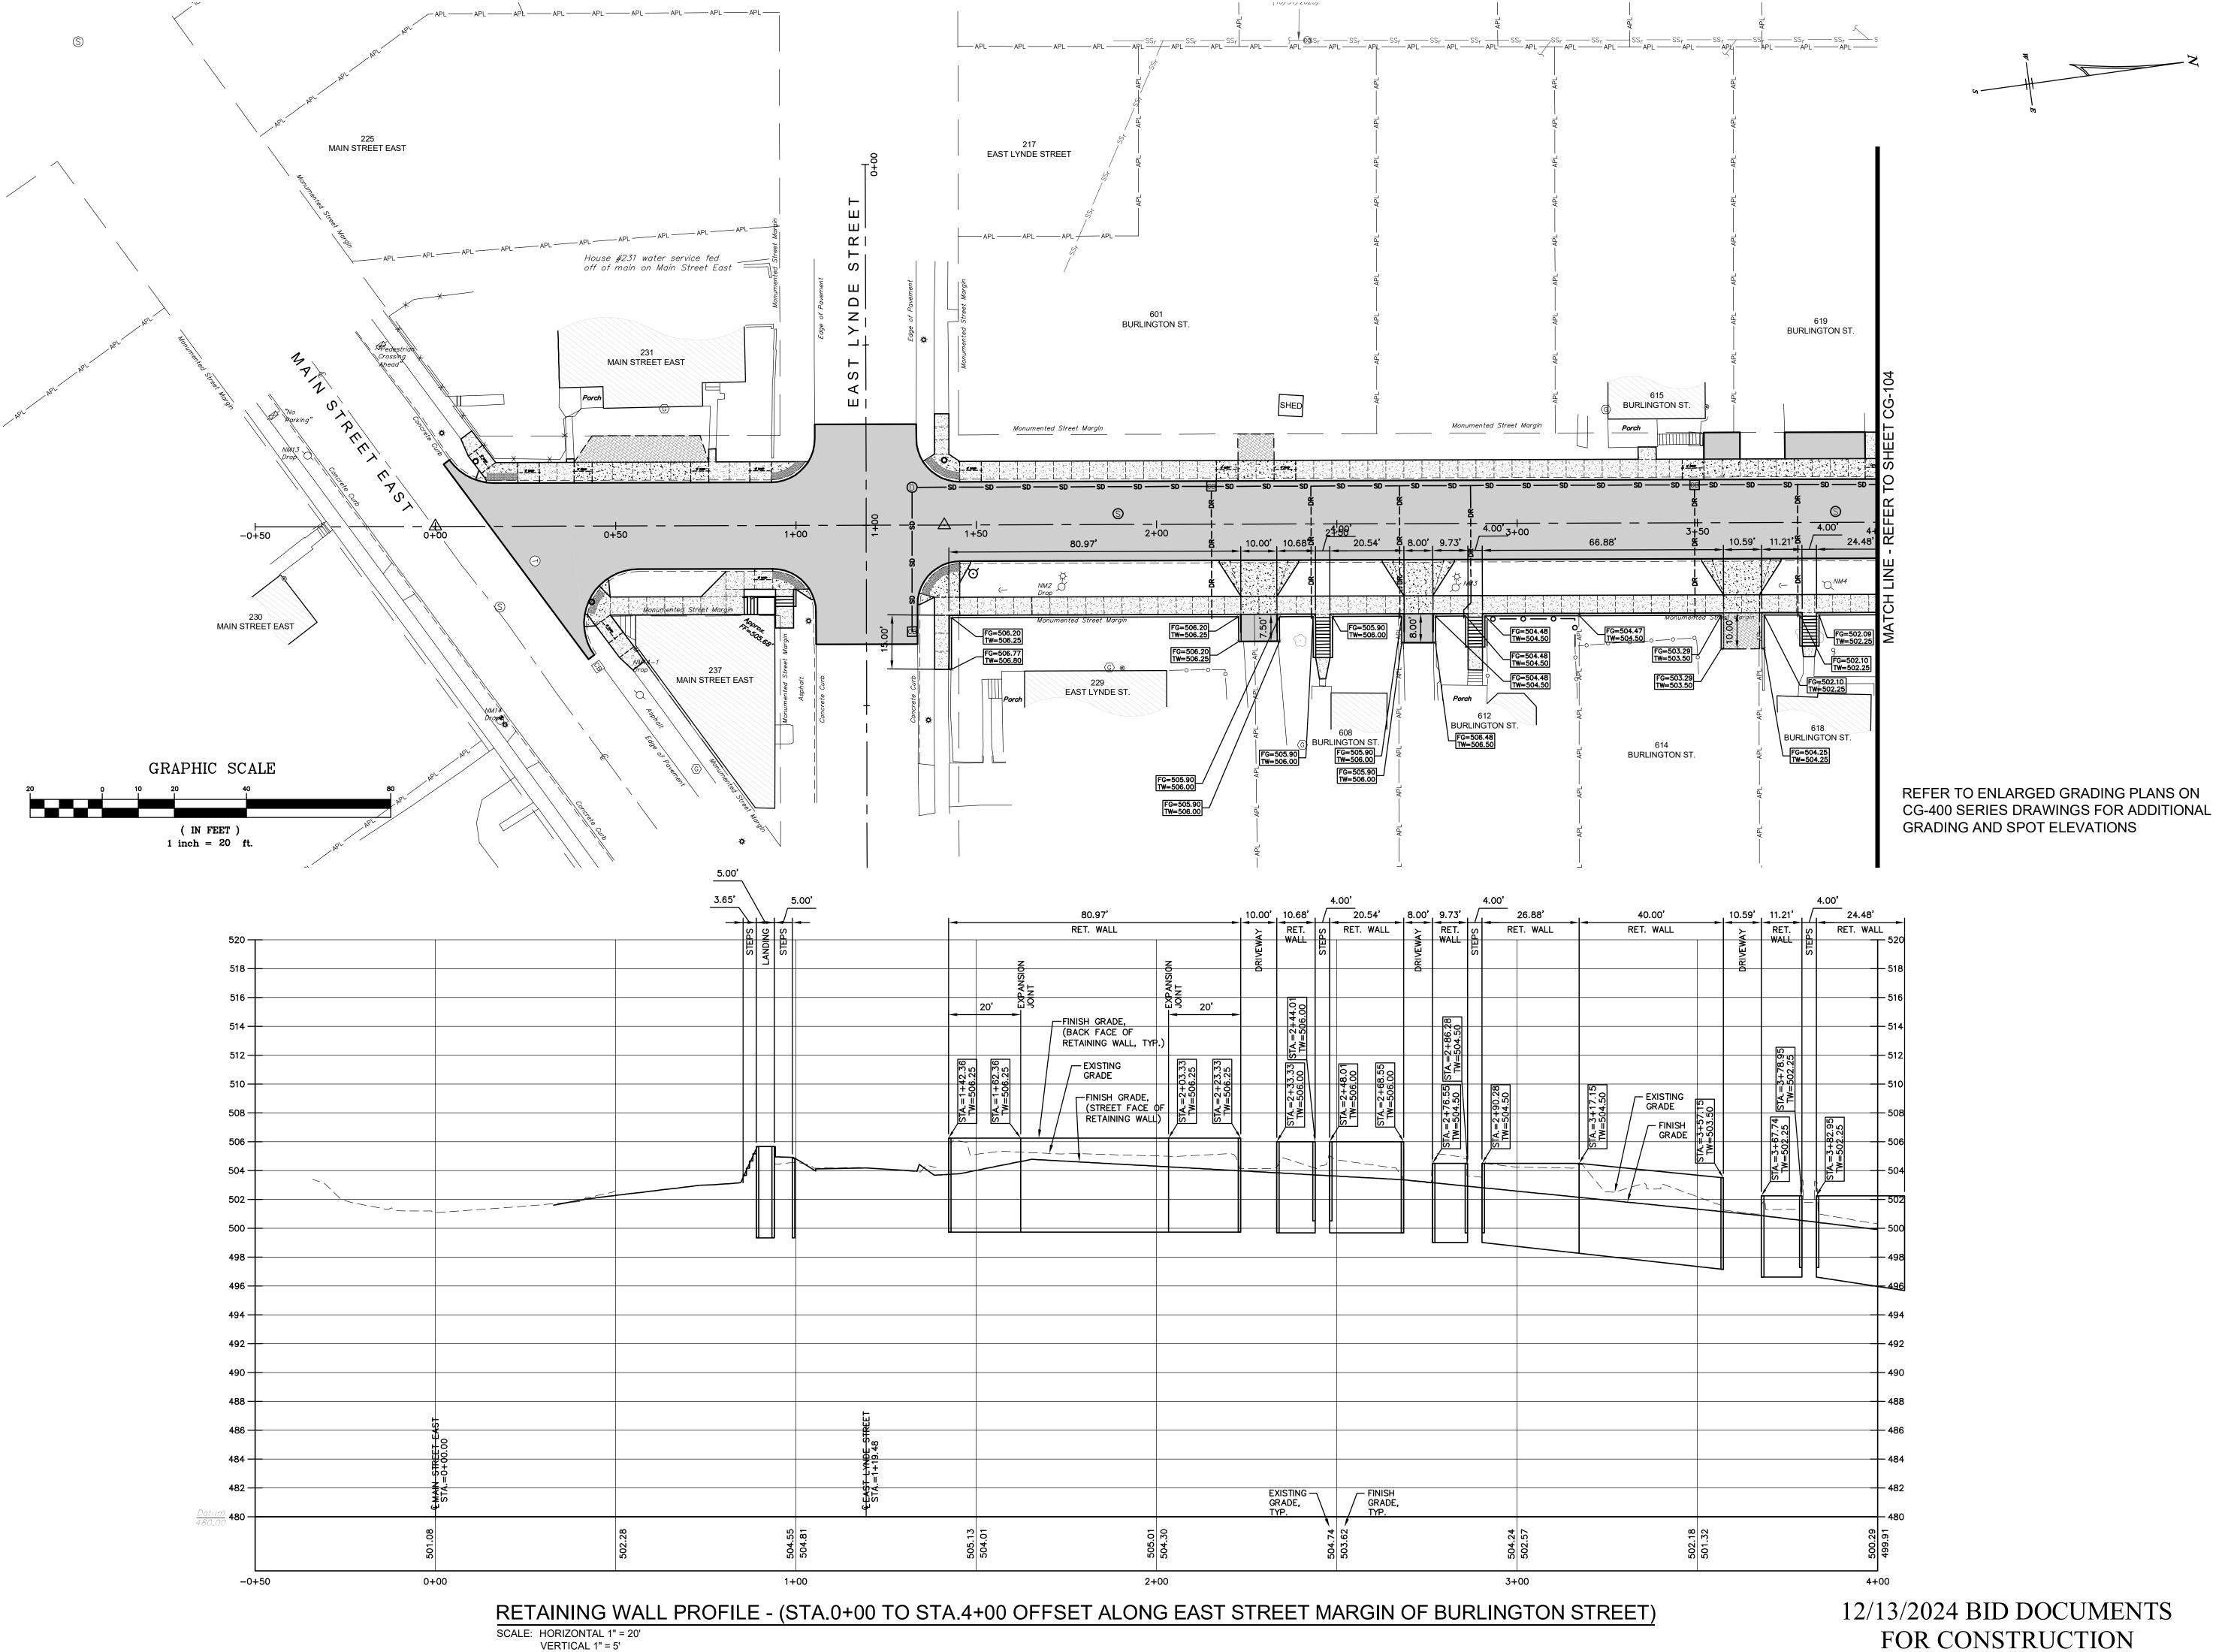
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PROJECT NO: 2023-052

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> GRADING PLAN AND **CENTERLINE PROFILE**



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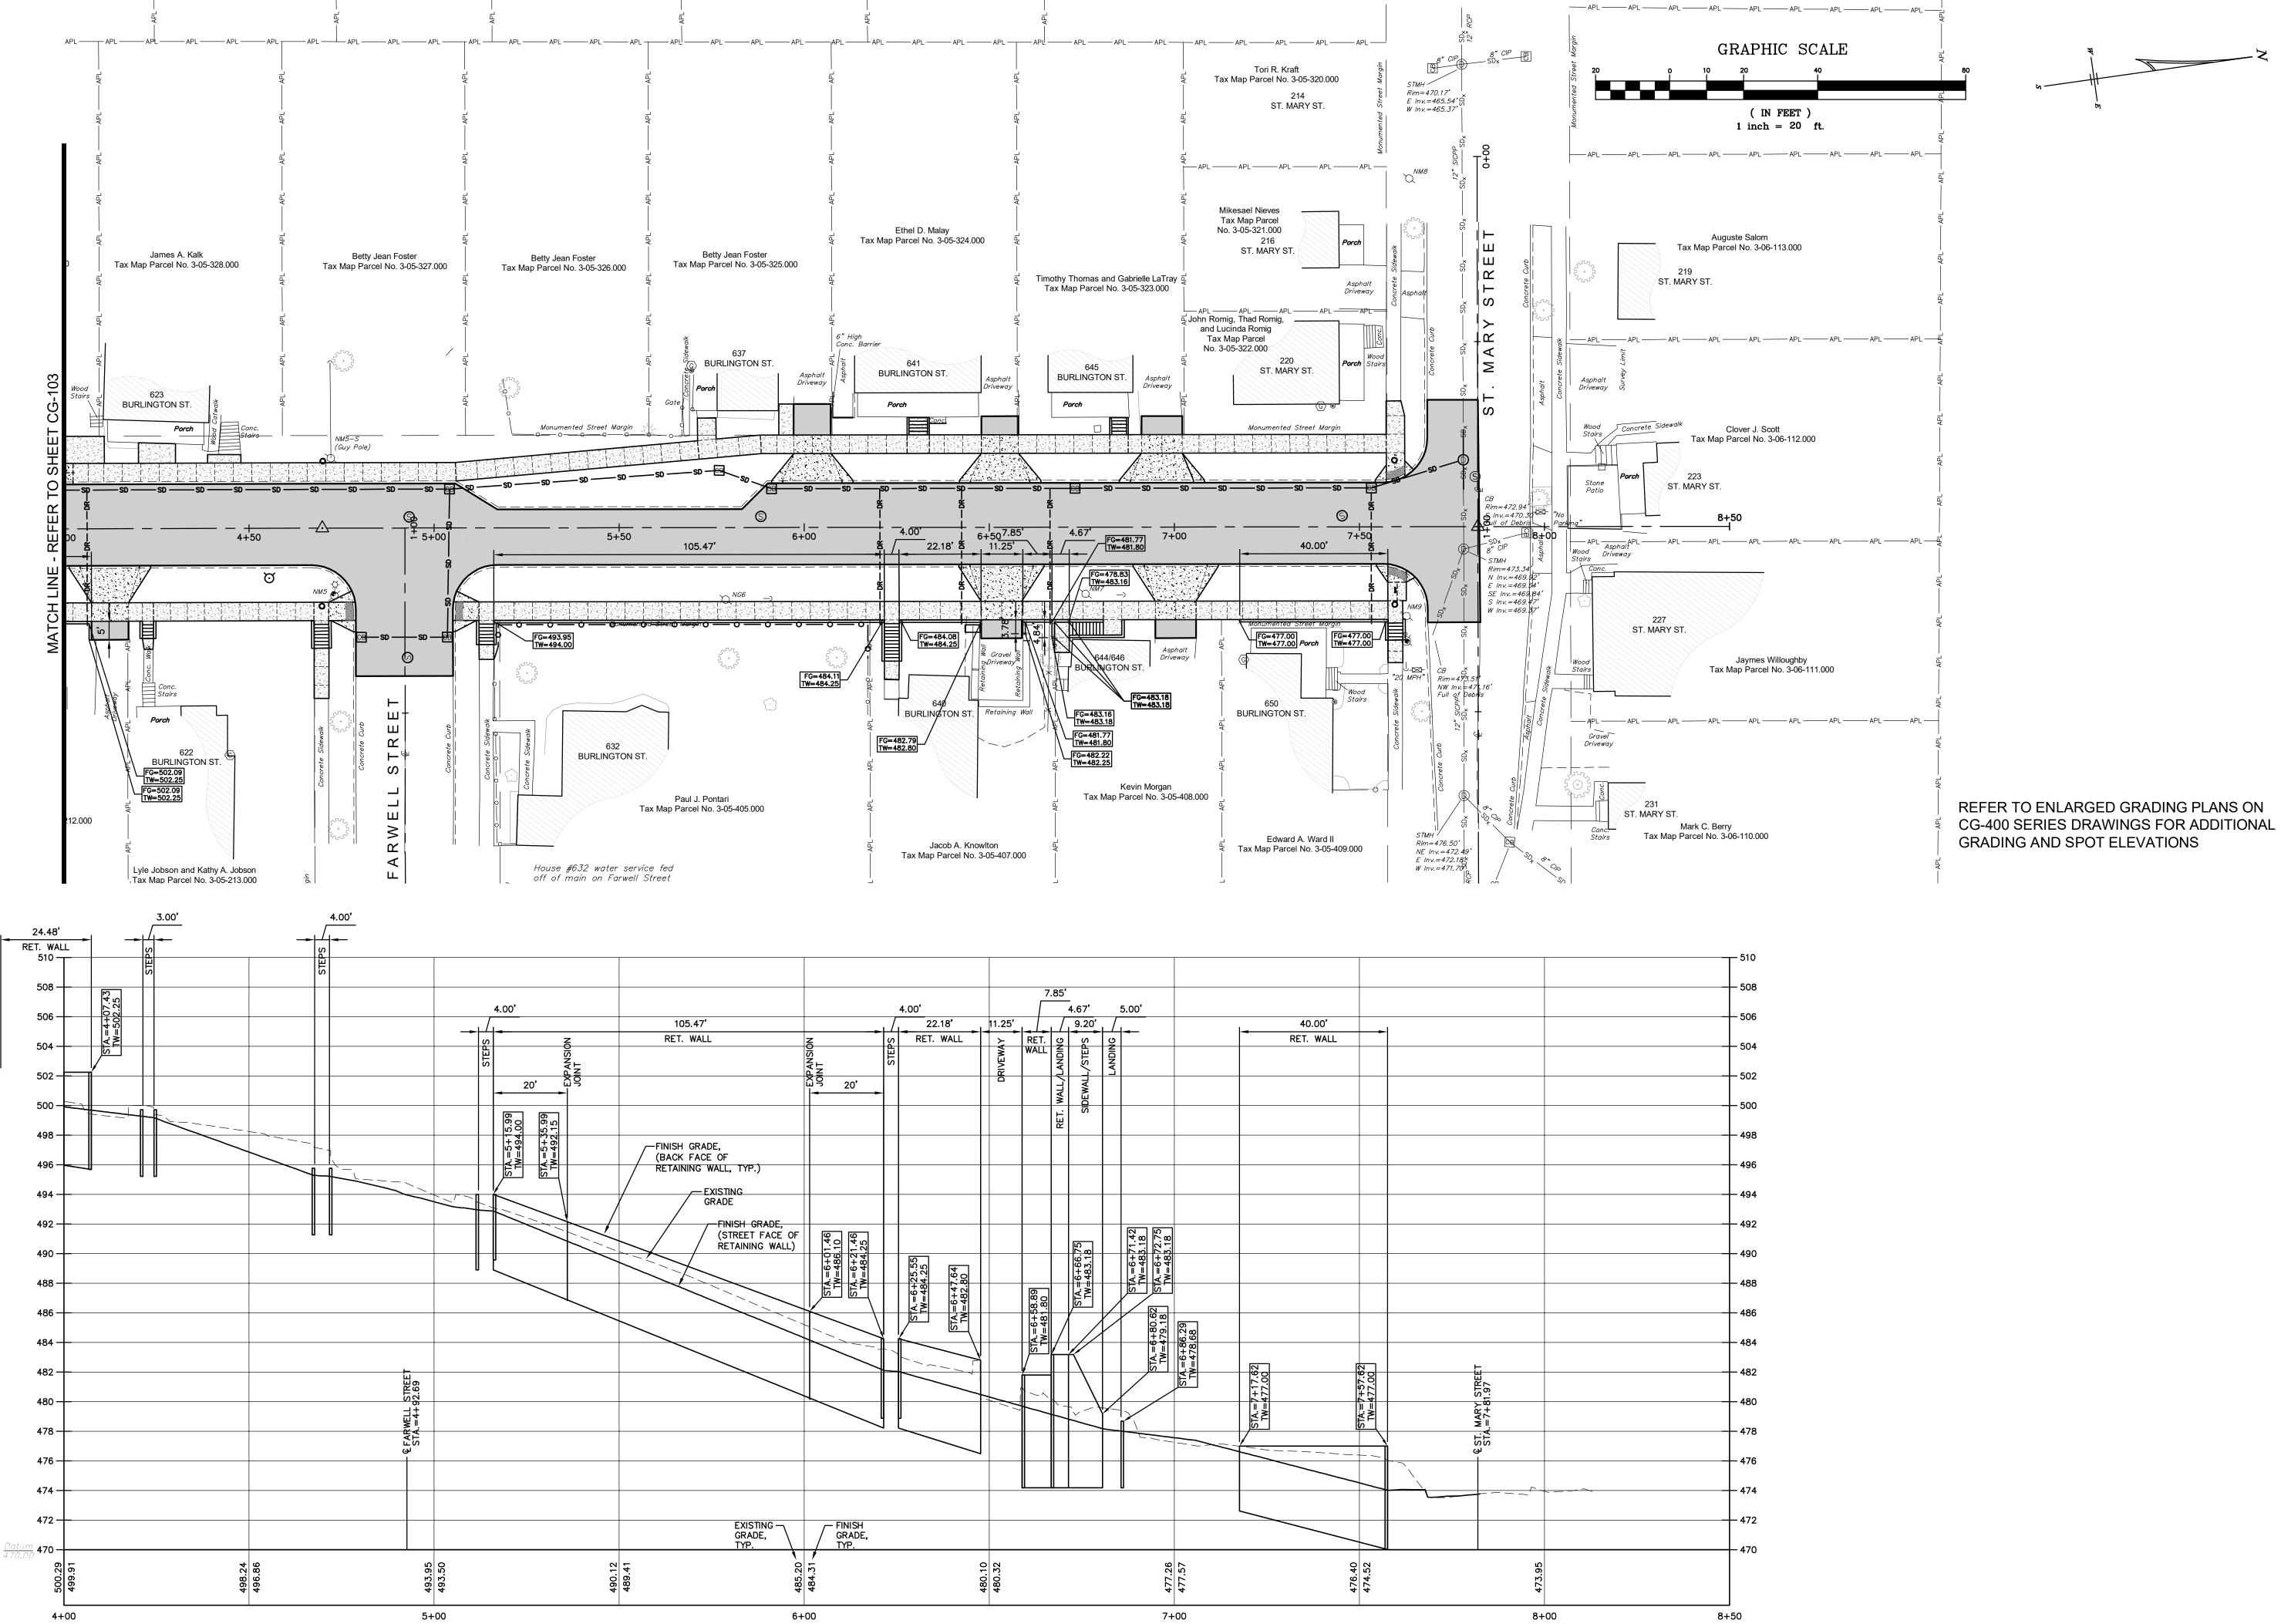


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JEFFERSON COUNTY, STATE OF NEW YO

PROJECT NO: 2023-052

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> **RETAINING WALL** PLAN AND PROFILE



12/13/2024 BID DOCUMENTS FOR CONSTRUCTION

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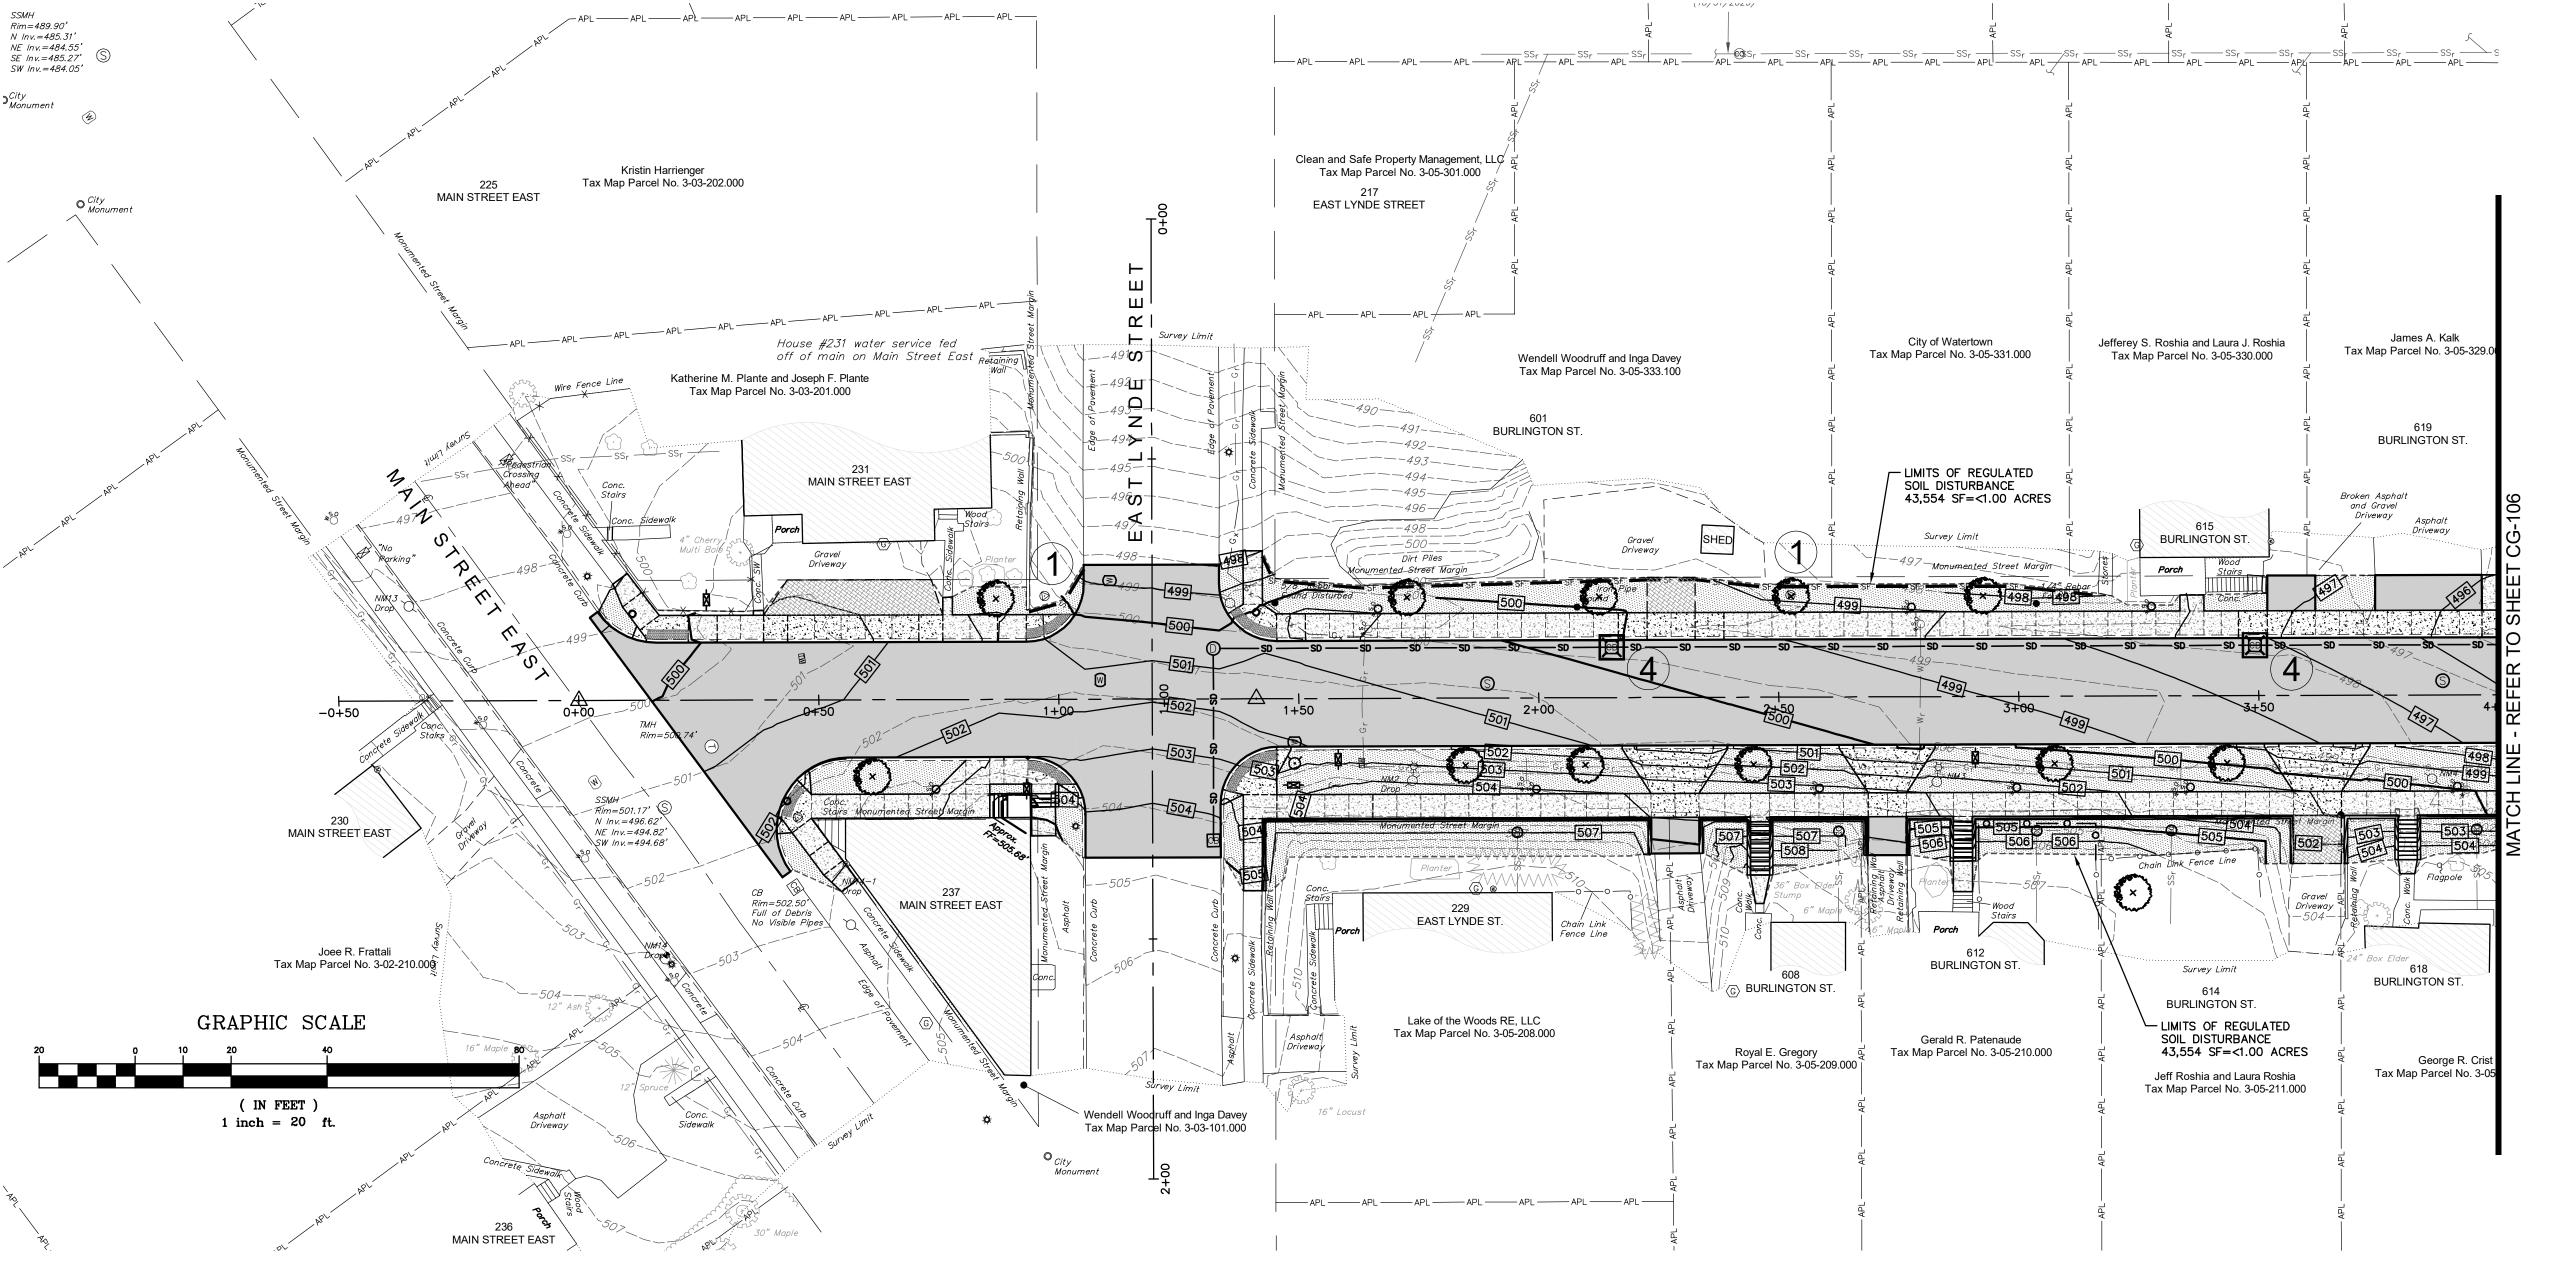


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RECONSTRUCTION PROJECTY OF WATERTOWN
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> **RETAINING WALL** PLAN AND PROFILE



TEMPORARY MEASURES:

- INSTALL SILT FENCE IN LOCATIONS INDICATED AND WHERE THERE IS THE POTENTIAL FOR OFFSITE RUNOFF TO OCCUR PRIOR TO ANY CONSTRUCTION WITHIN THOSE AREAS. FENCE MUST BE MAINTAINED AND MUST REMAIN IN PLACE UNTIL PROJECT HAS BEEN FINAL GRADED AND VEGETATION HAS BEEN ESTABLISHED.
- 2 CONSTRUCTION ENTRANCES SHALL BE MAINTAINED IN A CONDITION WHICH WILL PREVENT TRACKING OF SEDIMENT ONTO PUBLIC RIGHT OF WAY OR STREETS. ALL SEDIMENT SPILLED, DROPPED OR WASHED ONTO PUBLIC RIGHTS OF WAY MUST BE REMOVED IMMEDIATELY.
- CHECK DAMS SHALL BE INSTALLED IN DRAINAGE CHANNELS AS NECESSARY TO REDUCE EROSION WITHIN THE CHANNELS AND THE TRANSPORTATION OF SEDIMENT DOWNSTREAM.
- INLET PROTECTION SHALL BE INSTALLED AROUND CATCH BASINS FOLLOWING THEIR INSTALLATION.

SILT FENCE
STABILIZED
ENTRANCE

STABILIZED CONSTRUCTION ENTRANCE

STONE CHECK DAM

INLET PROTECTION

EROSION AND SEDIMENT CONTROL NOTES:

- 1. PRIOR TO COMMENCING ANY CLEARING GRUBBING, EARTHWORK ACTIVITIES, ETC. AT THE SITE, THE CONTRACTOR SHALL FLAG THE WORK LIMITS AND SHALL INSTALL ALL TEMPORARY EROSION AND SEDIMENT CONTROL MEASURES (I.E. SILT FENCES, TREE PROTECTION/BARRIER FENCES, STABILIZED CONSTRUCTION ENTRANCES, STORM DRAIN SEDIMENT FILTERS, DRAINAGE DITCH SEDIMENT FILTERS, ETC.) INDICATED ON THE PROJECT DRAWINGS. TEMPORARY EROSION AND SEDIMENT CONTROL MEASURES MUST BE CONSTRUCTED, STABILIZED, AND FUNCTIONAL BEFORE SITE DISTURBANCE BEGINS WITHIN THEIR TRIBUTARY AREAS, ONCE CONSTRUCTED, ALL MEASURES SHALL BE PROPERLY MAINTAINED AND/OR REPLACED AS NECESSARY AND THEN REMOVED FROM THE SITE ONCE VEGETATION AND PAVEMENT ARE IN PLACE.
- 2. EARTH DISTURBANCE SHALL BE LIMITED TO AREAS WHERE TEMPORARY EROSION AND SEDIMENT CONTROL MEASURES ARE TO BE INSTALLED. ONCE ALL MEASURES ARE INSTALLED TO THE SATISFACTION OF THE ENGINEER, THE REMAINDER OF THE CLEARING AND GRADING ACTIVITIES SHALL COMMENCE.
- 3. ALL EROSION AND SEDIMENT CONTROL MEASURES SHALL BE IN STRICT COMPLIANCE WITH THE "NEW YORK STATE STANDARDS AND SPECIFICATIONS FOR EROSION AND SEDIMENT CONTROL" CURRENT EDITION.
- 4. THE CONTRACTOR SHALL COMPLY WITH THE PROVISIONS OF ALL ENVIRONMENTAL PERMITS ISSUED FOR THIS PROJECT. THESE PLANS REFLECT THE PROVISIONS AND REQUIREMENTS OF SAID PERMIT(S). PERMIT(S) WILL BE AVAILABLE FROM THE ENGINEER—IN—CHARGE PRIOR TO THE START OF CONSTRUCTION.
- 5. CONSTRUCTION IS TO PROCEED IN ACCORDANCE WITH THE CONSTRUCTION PHASING SCHEDULED SUPPLIED BY THE CONTRACTOR OR SHOWN ON THE PLANS. ALL ELEMENTS OF THE SCHEDULE SHALL BE COMPLETED PRIOR TO BEGINNING THE NEXT CONSTRUCTION PHASE. THESE ELEMENTS INCLUDE ALL UTILITY CONSTRUCTION, THE BASE COURSE OF ASPHALT PAVING, AND ESTABLISHING GRASSES ON ALL DISTURBED AREAS. FOR TIME FRAMES OUTSIDE THE GROWING SEASON, OTHER METHODS OF SOIL STABILIZATION (SUCH AS THE USE OF JUTE MESH) SHALL BE USED UNTIL SUCH TIME AS GRASSES CAN BE ESTABLISHED.
- 6. THE CONTRACTOR SHALL INSPECT AND MAINTAIN THE INTEGRITY AND FUNCTION OF ALL TEMPORARY EROSION CONTROL MEASURES THROUGHOUT THE DURATION OF THE DEVELOPMENT PROCESS. TO ASSURE PROPER FUNCTION, SILTATION BARRIERS SHALL BE MAINTAINED IN GOOD CONDITION AND REINFORCED, EXTENDED, REPAIRED OR REPLACED AS NECESSARY. WASHOUTS SHALL BE IMMEDIATELY REPAIRED, RE-SEEDED AND PROTECTED FROM FURTHER EROSION. ALL ACCUMULATED SEDIMENT SHALL BE REMOVED AND CONTAINED IN APPROPRIATE SPOIL AREAS. WATER SHALL BE APPLIED TO NEWLY SEEDED AREAS AS NEEDED UNTIL GRASS COVER IS WELL ESTABLISHED TO EFFECTIVELY CONTROL WIND EROSION. WATER SHALL BE APPLIED TO ALL EXPOSED SOILS AS NECESSARY UNTIL GROUND COVER IS PERMANENTLY ESTABLISHED.
- 7. THE STABILIZED CONSTRUCTION ENTRANCE, UTILIZED DURING CONSTRUCTION, SHALL BE MAINTAINED IN A CONDITION THAT SHALL PREVENT TRACKING OR FLOWING OF SEDIMENT ONTO PUBLIC RIGHTS—OF—WAY. THIS MAY REQUIRE PERIODIC TOP DRESSING WITH ADDITIONAL STONE AS CONDITIONS DEMAND AND REPAIR AND/OR CLEANOUT OF ANY MEASURES USED TO TRAP SEDIMENT. ALL SEDIMENT SPILLED, DROPPED, WASHED, OR TRACKED ONTO PUBLIC RIGHTS—OF—WAY MUST BE REMOVED IMMEDIATELY. WHEELS SHALL BE CLEANED TO REMOVE SEDIMENT PRIOR TO ENTRANCE ONTO PUBLIC RIGHTS—OF—WAY. WHEN WASHING IS REQUIRED, IT SHALL BE DONE ON AN AREA STABILIZED WITH STONE AND WHICH DRAINS INTO AN APPROVED SEDIMENT TRAPPING DEVISE. PERIODIC INSPECTIONS AND NEEDED MAINTENANCE SHALL BE PROVIDED AFTER EACH RAIN EVENT.
- 8. IMMEDIATELY FOLLOWING COMPLETION OF ANY AND ALL STORM DRAIN INLETS, STORM DRAIN INLET PROTECTION SHALL BE CONSTRUCTED. THE INLET PROTECTION SHALL FUNCTION TO PREVENT SEDIMENT FROM ENTERING THE STORM DRAINS. THEY SHALL BE MAINTAINED IN GOOD CONDITION UNTIL FINAL VEGETATIVE COVER IS WELL ESTABLISHED.
   9. AS MUCH AS IS PRACTICAL, EXISTING VEGETATION SHALL BE PRESERVED. FOLLOWING THE COMPLETION OF CONSTRUCTION ACTIVITIES IN ANY
- PORTION OF THE SITE, PERMANENT VEGETATION SHALL BE ESTABLISHED ON ALL EXPOSED SOILS.

  10 IN SOME INSTANCES, ESTABLISHING VEGETATION WILL BE NECESSARILY DELAYED WHILE CONSTRUCTION IS IN PROGRESS. DURING THESE TIMES
- 10. IN SOME INSTANCES, ESTABLISHING VEGETATION WILL BE NECESSARILY DELAYED WHILE CONSTRUCTION IS IN PROGRESS. DURING THESE TIMES, SEDIMENT CONTROL MEASURES WILL BE EMPLOYED TO PREVENT SEDIMENT FROM LEAVING THE SITE. VEGETATION SHALL BE ESTABLISHED IN THESE AREAS AS SOON AS IT IS PRACTICAL.
- 11. SITE PREPARATION ACTIVITIES SHALL BE PLANNED TO MINIMIZE THE SCOPE AND DURATION OF SOIL DISRUPTION.

  12. PERMANENT TRAFFIC CORRIDORS SHALL BE ESTABLISHED AND "ROUTES OF CONVENIENCE" SHALL BE AVOIDED. STABILIZED CONSTRUCTION
- ENTRANCES SHALL BE INSTALLED AT ALL POINTS OF ENTRY ONTO THE PROJECT SITE.

  13. AREAS UNDERGOING CLEARING OR GRADING AND WHERE WORK IS DELAYED OR COMPLETED AND WILL NOT BE REDISTURBED FOR 21 DAYS OR
- MORE SHALL BE STABILIZED WITH TEMPORARY OR PERMANENT VEGETATIVE COVER WITHIN 14 DAYS.
- 14. TOPSOIL AND FILL THAT IS TO REMAIN STOCKPILED ON—SITE FOR PERIODS GREATER THAN 30 DAYS SHALL BE STABILIZED BY SEEDING. PRIOR TO THE SEEDING OPERATION, THE STOCKPILED MATERIAL SHALL BE GRADED AS NEEDED AND FEASIBLE TO PERMIT THE USE OF CONVENTIONAL EQUIPMENT FOR SEEDBED PREPARATION, FERTILIZATION, SEEDING, MULCH APPLICATIONS AND MULCH ANCHORING.
- 15. SILT FENCES SHALL BE CONSTRUCTED AROUND ALL STOCKPILES OF FILL, TOPSOIL, AND EXCAVATED OVERBURDEN. SILT FENCES SHALL BE ANCHORED AND MAINTAINED IN GOOD CONDITION UNTIL SUCH TIME AS SAID STOCKPILES ARE REMOVED AND STOCKPILING AREAS ARE BROUGHT TO FINAL GRADE AND PERMANENTLY STABILIZED.
- 16. IN NO CASE SHALL ERODIBLE MATERIALS BE STOCKPILED WITHIN 25 FEET OF ANY DITCH STREAM OR OTHER SURFACE WATER BODY.

  17. DAMAGE TO SURFACE WATERS RESULTING FROM EROSION AND SEDIMENTATION SHALL BE MINIMIZED BY STABILIZING DISTURBED AREAS AND BY
- REMOVING SEDIMENT FROM CONSTRUCTION SITE DISCHARGES.

  18. CONSTRUCTION TRAFFIC SHALL NOT CROSS STREAMS OR DITCHES EXCEPT AT SUITABLE CROSSING FACILITIES, AND SHALL NOT OPERATE
- CONSTRUCTION TRAFFIC SHALL NOT CROSS STREAMS OR DITCHES EXCEPT AT UNNECESSARILY WITHIN WATERWAYS OR DRAINAGE DITCHES.
- 19. NO SYNTHETIC EROSION CONTROL MATERIAL, FENCING OR MATTING SHALL BE PART OF THE PERMANENT INSTALLATION.

  20. WHERE CONCENTRATED FLOWS ARE CREATED AS A RESULT OF CONSTRUCTION OPERATIONS, CHECK DAMS SHALL BE INSTALLED DEEMED



ASPHALT PAVEMENT

C

CONCRETE WALK (4" THICK)

LAWN AREA

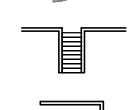
CONCRETE PAVEMENT
DRIVEWAY/APRON/CURB RAMP
(6" THICK)

CRUSHED STONE PAVEMENT DRIVEWAYS




DETECTABLE WARNING SURFACE

CONCRETE STEPS AND SIDEWALLS



CONCRETE RETAINING WALL

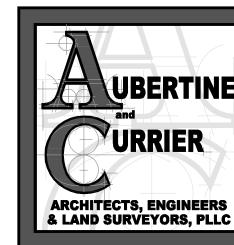

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CITY OF WATERTOWN
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JEFFERSON COUNTY, STATE OF

PROJECT NO: 2023-052

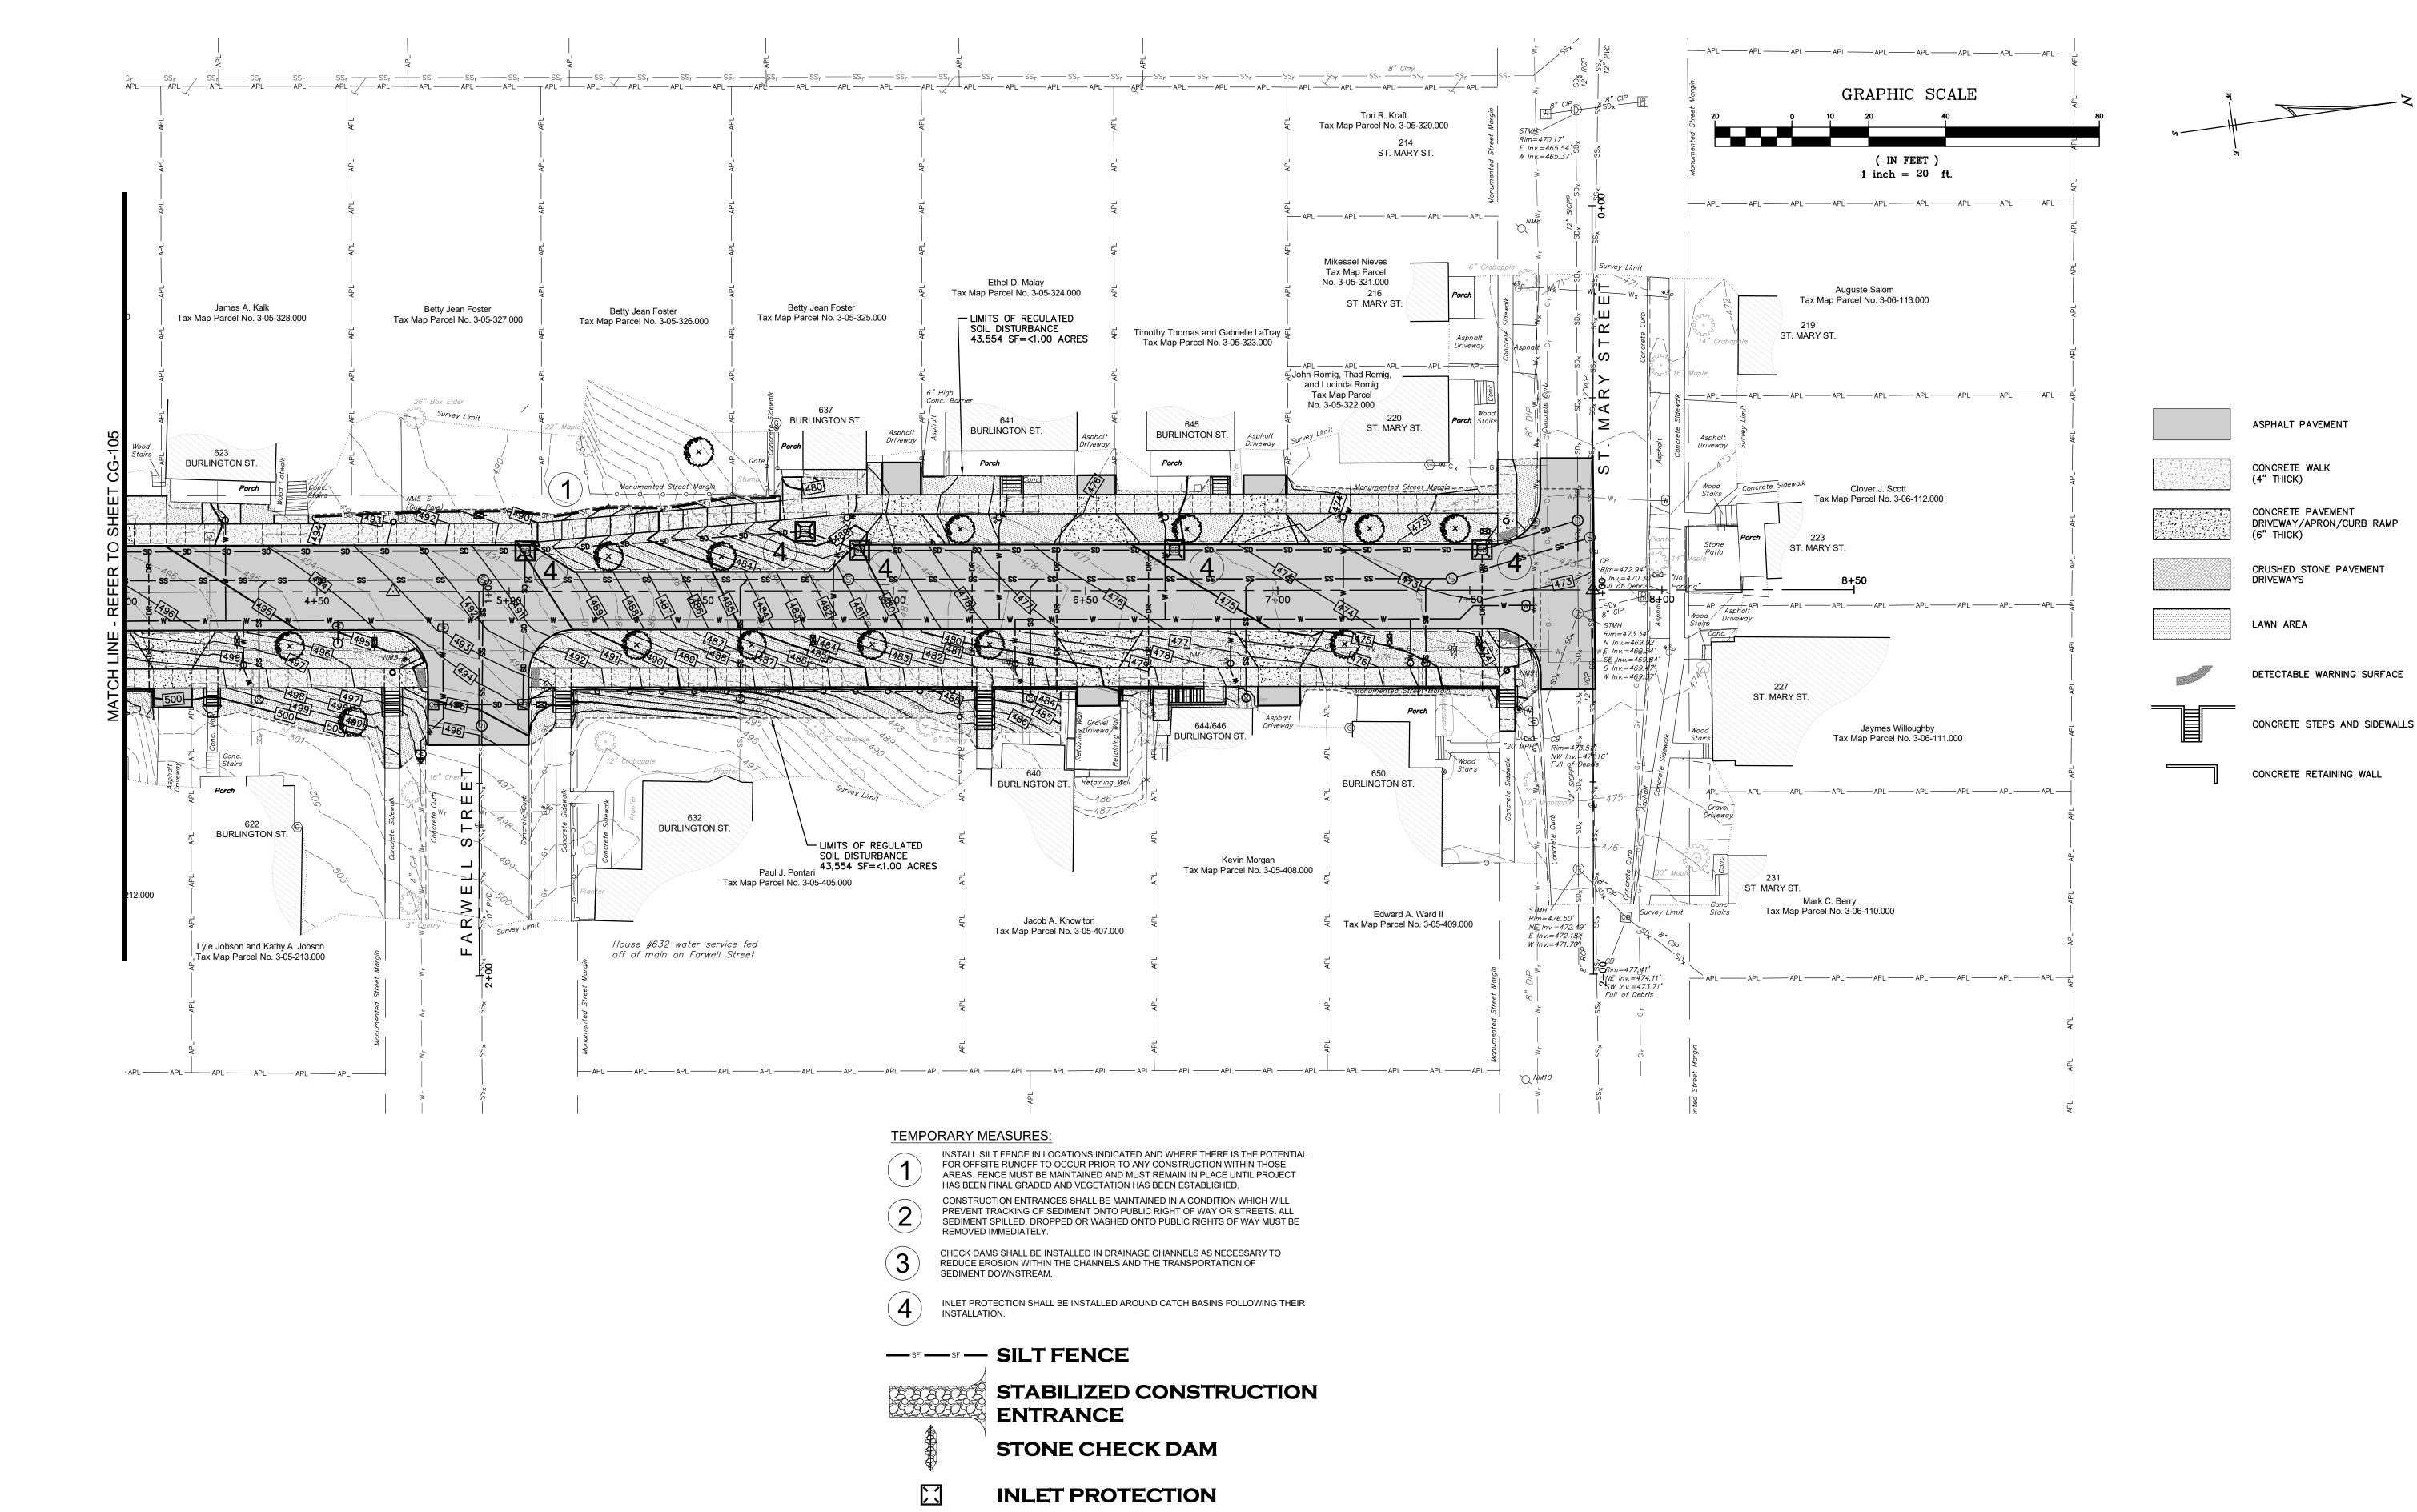
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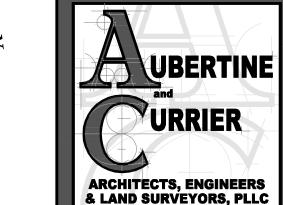
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EROSION AND SEDIMENT CONTROL PLAN



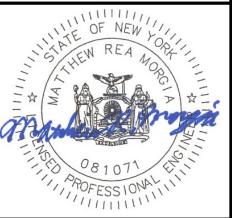


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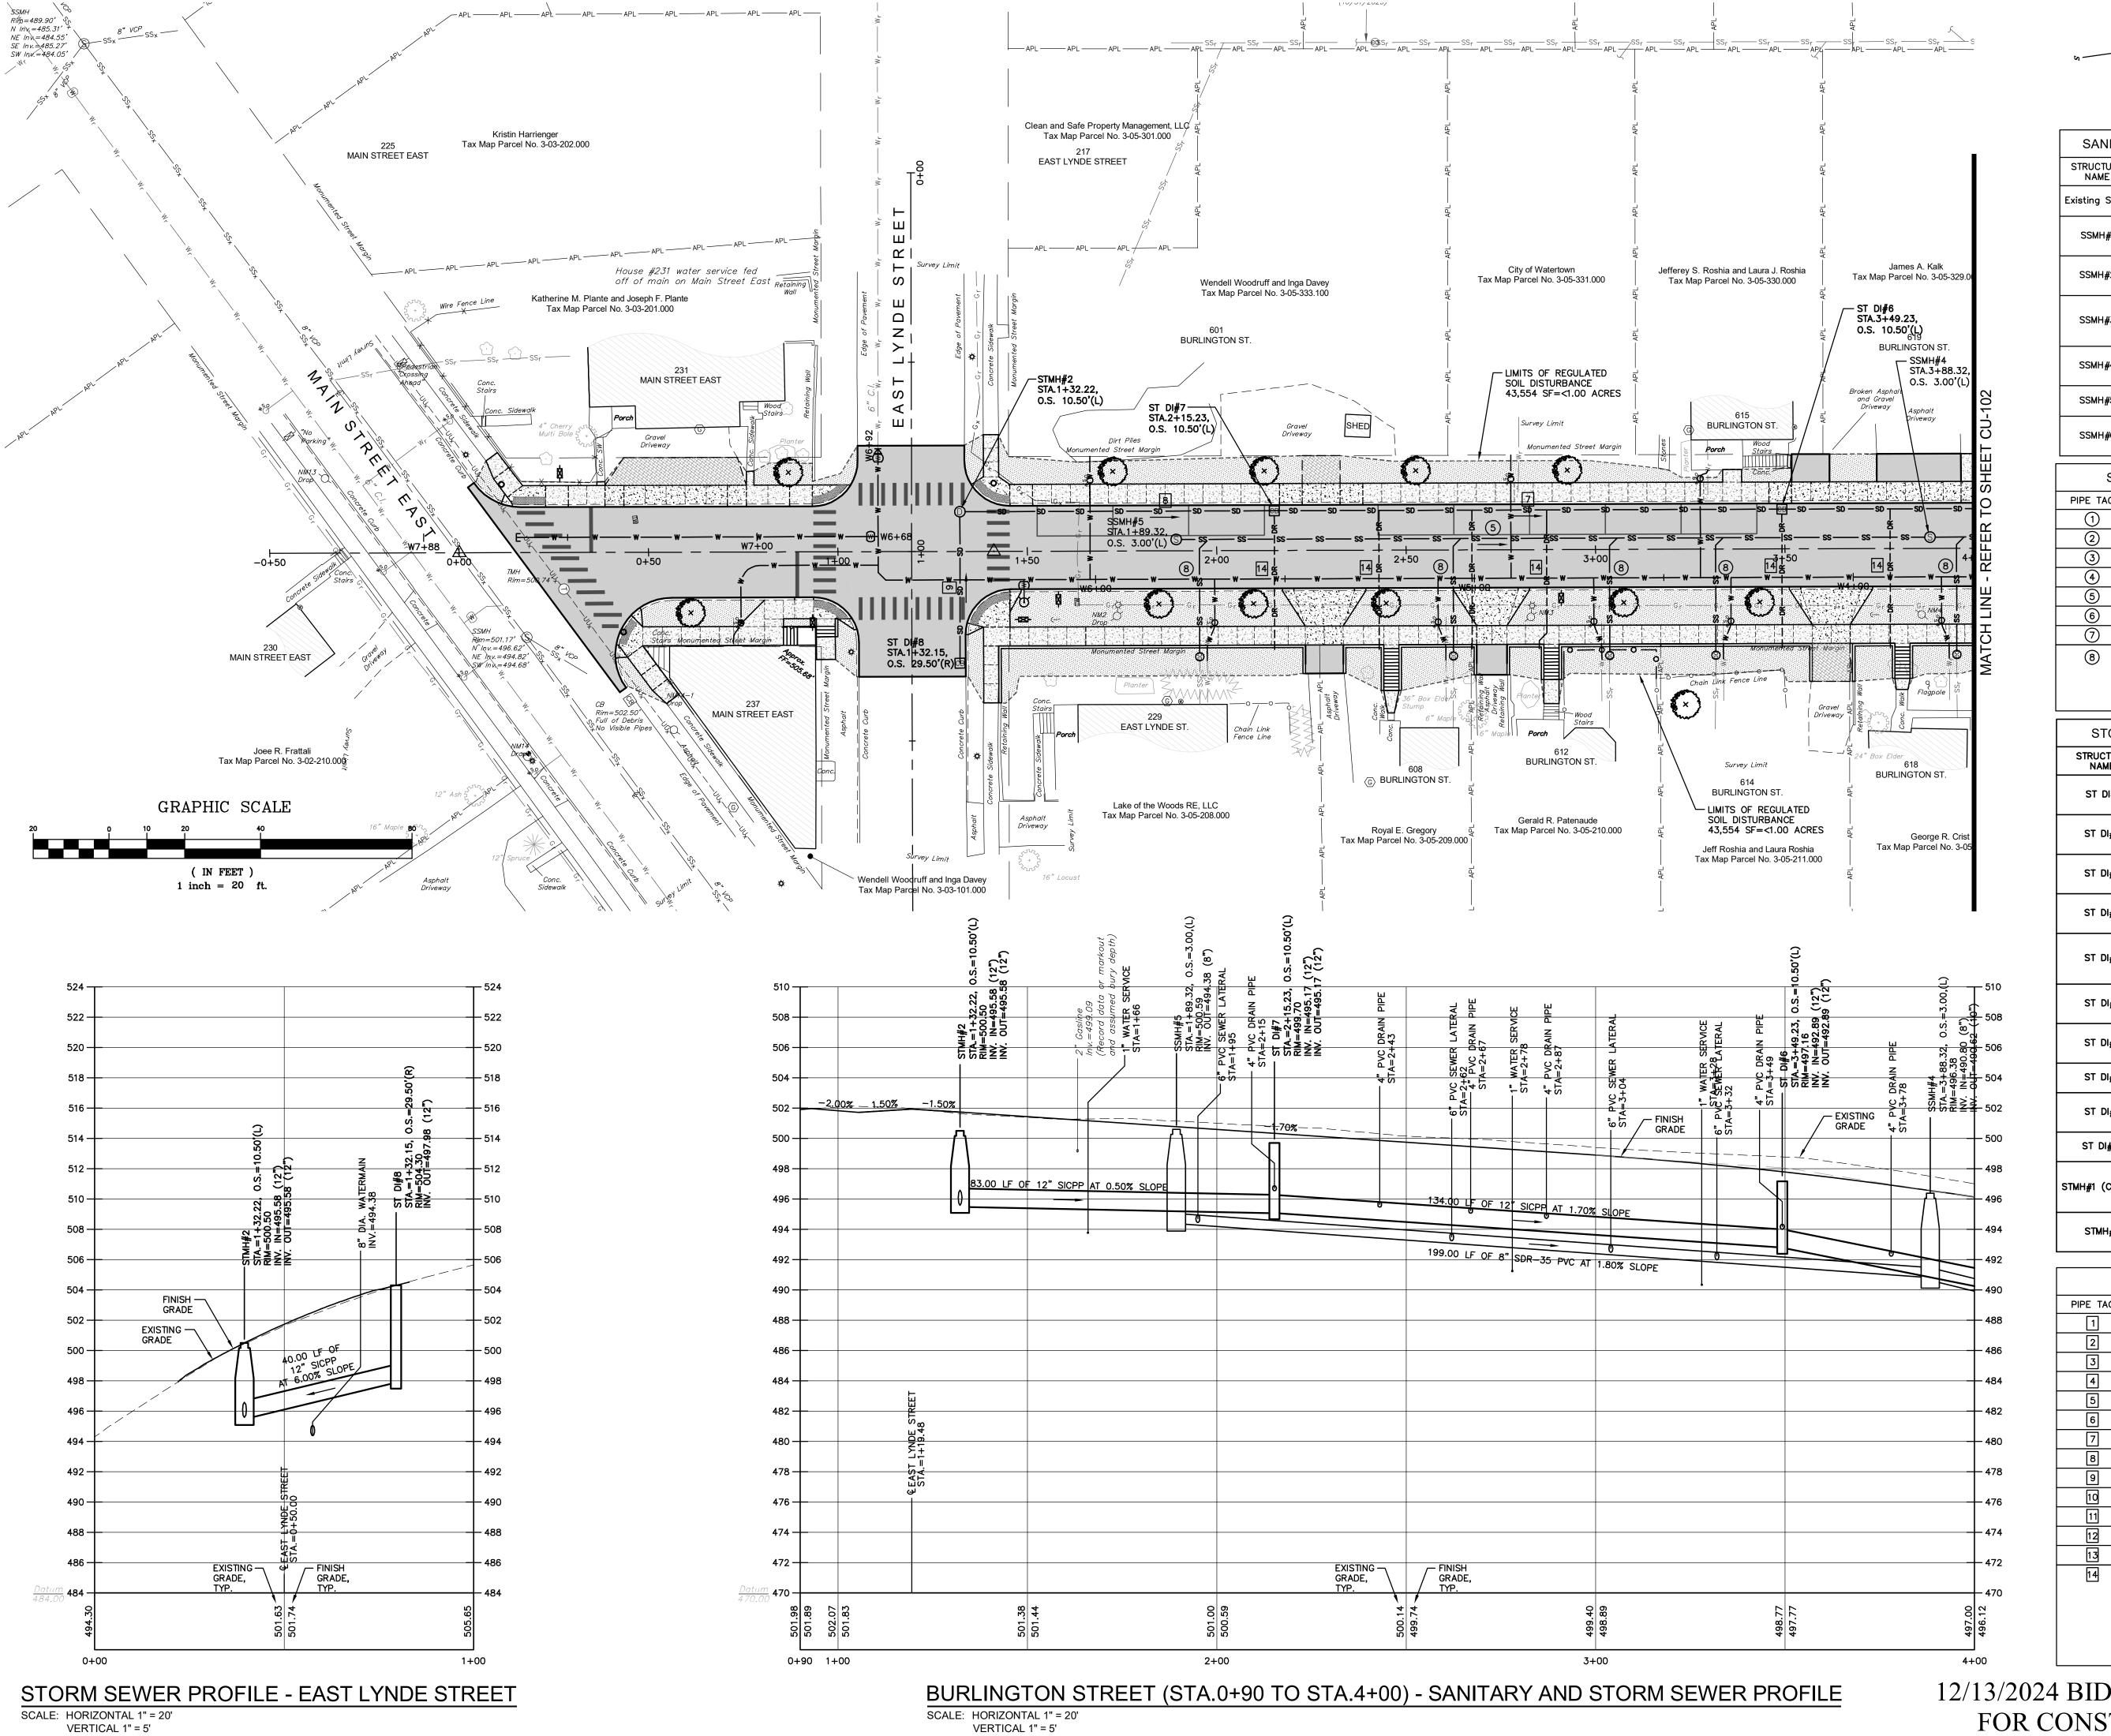
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PROJECT NO: 2023-052

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04/30/2024 12/13/2024

> **EROSION AND SEDIMENT** CONTROL PLAN





SANITARY SEWER STRUCTURE TABLE		
STRUCTURE NAME	STATION AND OFFSET	RIMS AND INVER
Existing SSMH	STA.=7+81.25, OFFESET 13.54', L	RIM=472.70 INV IN=465.3
SSMH#1	STA.=7+45.31, OFFESET 3.00', L	RIM=472.74 INV IN=465.6 INV OUT=465.
SSMH#2	STA.=5+88.31, OFFESET 3.00', L	RIM=480.86 INV IN=474.72 INV OUT=472.
SSMH#3	STA.=4+93.31, OFFESET 3.00', L	RIM=491.29 INV IN=484.3 INV IN=484.3 INV OUT=484.
SSMH#4	STA.=3+88.32, OFFESET 3.00', L	RIM=496.38 INV IN=490.80 INV OUT=490.0
SSMH#5	STA.=1+89.32, OFFESET 3.00', L	RIM=500.59 INV OUT=494.
SSMH#6	STA.=4+92.83, OFFESET 35.00', R	RIM=495.58 INV IN=486.5 INV OUT=486.

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PROJECT NO: 2023-052

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SANITARY SEWER PIPE TABLE			
PIPE TAG	SIZE	LENGTH	SLOPE
1	10"	37.45'	0.50%
2	10"	157.00'	4.50%
3	10"	95.00'	10.00%
4	10"	105.00'	6.00%
5	8"	199.00'	1.80%
6	10"	38.00'	5.50%
7	10"	5.00'	5.50%
(8) 6" SDR-35 PVC SANITARY SEWER			

LATERAL PIPE AT MIN. 2.00% SLOPE. (CONFIRM SIZE, TYPE, LOCATION AND ELEVATION OF EXISTING LATERAL. INSTALL CLEANOUT AND RECONNECT.)

STORM SEWER STRUCTURE TABLE				
STRUCTURE NAME	STATION AND OFFSET	FRAMES AND INVERTS		
ST DI#1	STA.=7+53.21, OFFSET -10.50, L	FRAME=472.25 INV IN=468.90' INV OUT=468.90		
ST DI#2	STA.=6+73.21, OFFSET -10.50, L	FRAME=474.68 INV IN=470.50' INV OUT=470.50		
ST DI#3	STA.=5+91.20, OFFSET -10.50, L	FRAME=480.07 INV IN=474.19' INV OUT=474.19		
ST DI#4	STA.=5+77.05, OFFSET -15.46, L	FRAME=479.25 INV IN=474.79' INV OUT=474.79		
ST DI#5	STA.=5+04.21, OFFSET -10.50, L	FRAME=489.92 INV IN=485.14' INV IN=485.14' INV OUT=485.14		
ST DI#6	STA.=3+49.23, OFFSET -10.50, L	FRAME=497.16 INV IN=492.89' INV OUT=492.89		
ST DI#7	STA.=2+15.23, OFFSET -10.50, L	FRAME=499.70 INV IN=495.17' INV OUT=495.17		
ST DI#8	STA.=1+32.15, OFFSET 29.50, R	FRAME=504.30 INV OUT=497.98		
ST DI#9	STA.=5+03.57, OFFSET 29.49, R	FRAME=493.90 INV IN=488.34' INV OUT=488.34		
ST DI#10	STA.=4+80.37, OFFSET 29.49, R	FRAME=495.16 INV OUT=489.04		
MH#1 (CUT-IN)	STA.=7+78.08, OFFSET -18.08, L	FRAME=472.55 INV IN=468.77' INV IN=468.66' INV OUT=468.66		
STMH#2	STA.=1+32.22, OFFSET -10.50, L	FRAME=500.50 INV IN=495.58' INV OUT=495.58		


STORM SEWER PIPE TABLE			
PIPE TAG	SIZE	LENGTH	SLOPE
1	12"	26.00'	0.50%
2	12"	80.00'	2.00%
3	12"	82.00'	4.50%
4	12"	15.00'	4.00%
5	12"	73.01'	14.18%
6	12"	155.00'	5.00%
7	12"	134.00'	1.70%
8	12"	83.00'	0.50%
9	12"	40.00'	6.00%
10	12"	40.00'	8.00%
11	12"	23.20'	3.00%
12	12"	8.00'	2.95%
13	12"	8.00'	2.95%
14 4" SDR-35 PVC SOLID STORM DRAIN PIPE AT MIN. 1.00% SLOPE. (PROVIDE BOOTED CONNECTION TO CITY SINGLE CATCH BASIN OR DIRECT			

THE BACK SIDE OF THE RETAINING WALL)

SINGLE CATCH BASIN OR DIRECT CONNECTION TO SICPP STORM SEWER PIPE WITH AN INSERT—A—TEE FITTING INTO THE STORM SEWER SYSTEM. CONNECT SOLID PIPE TO PERFORATED UNDERDRAIN PIPE ON UTILITY PLAN AND PROFILE SANITARY AND STORM SEWER

12/13/2024 BID DOCUMENTS

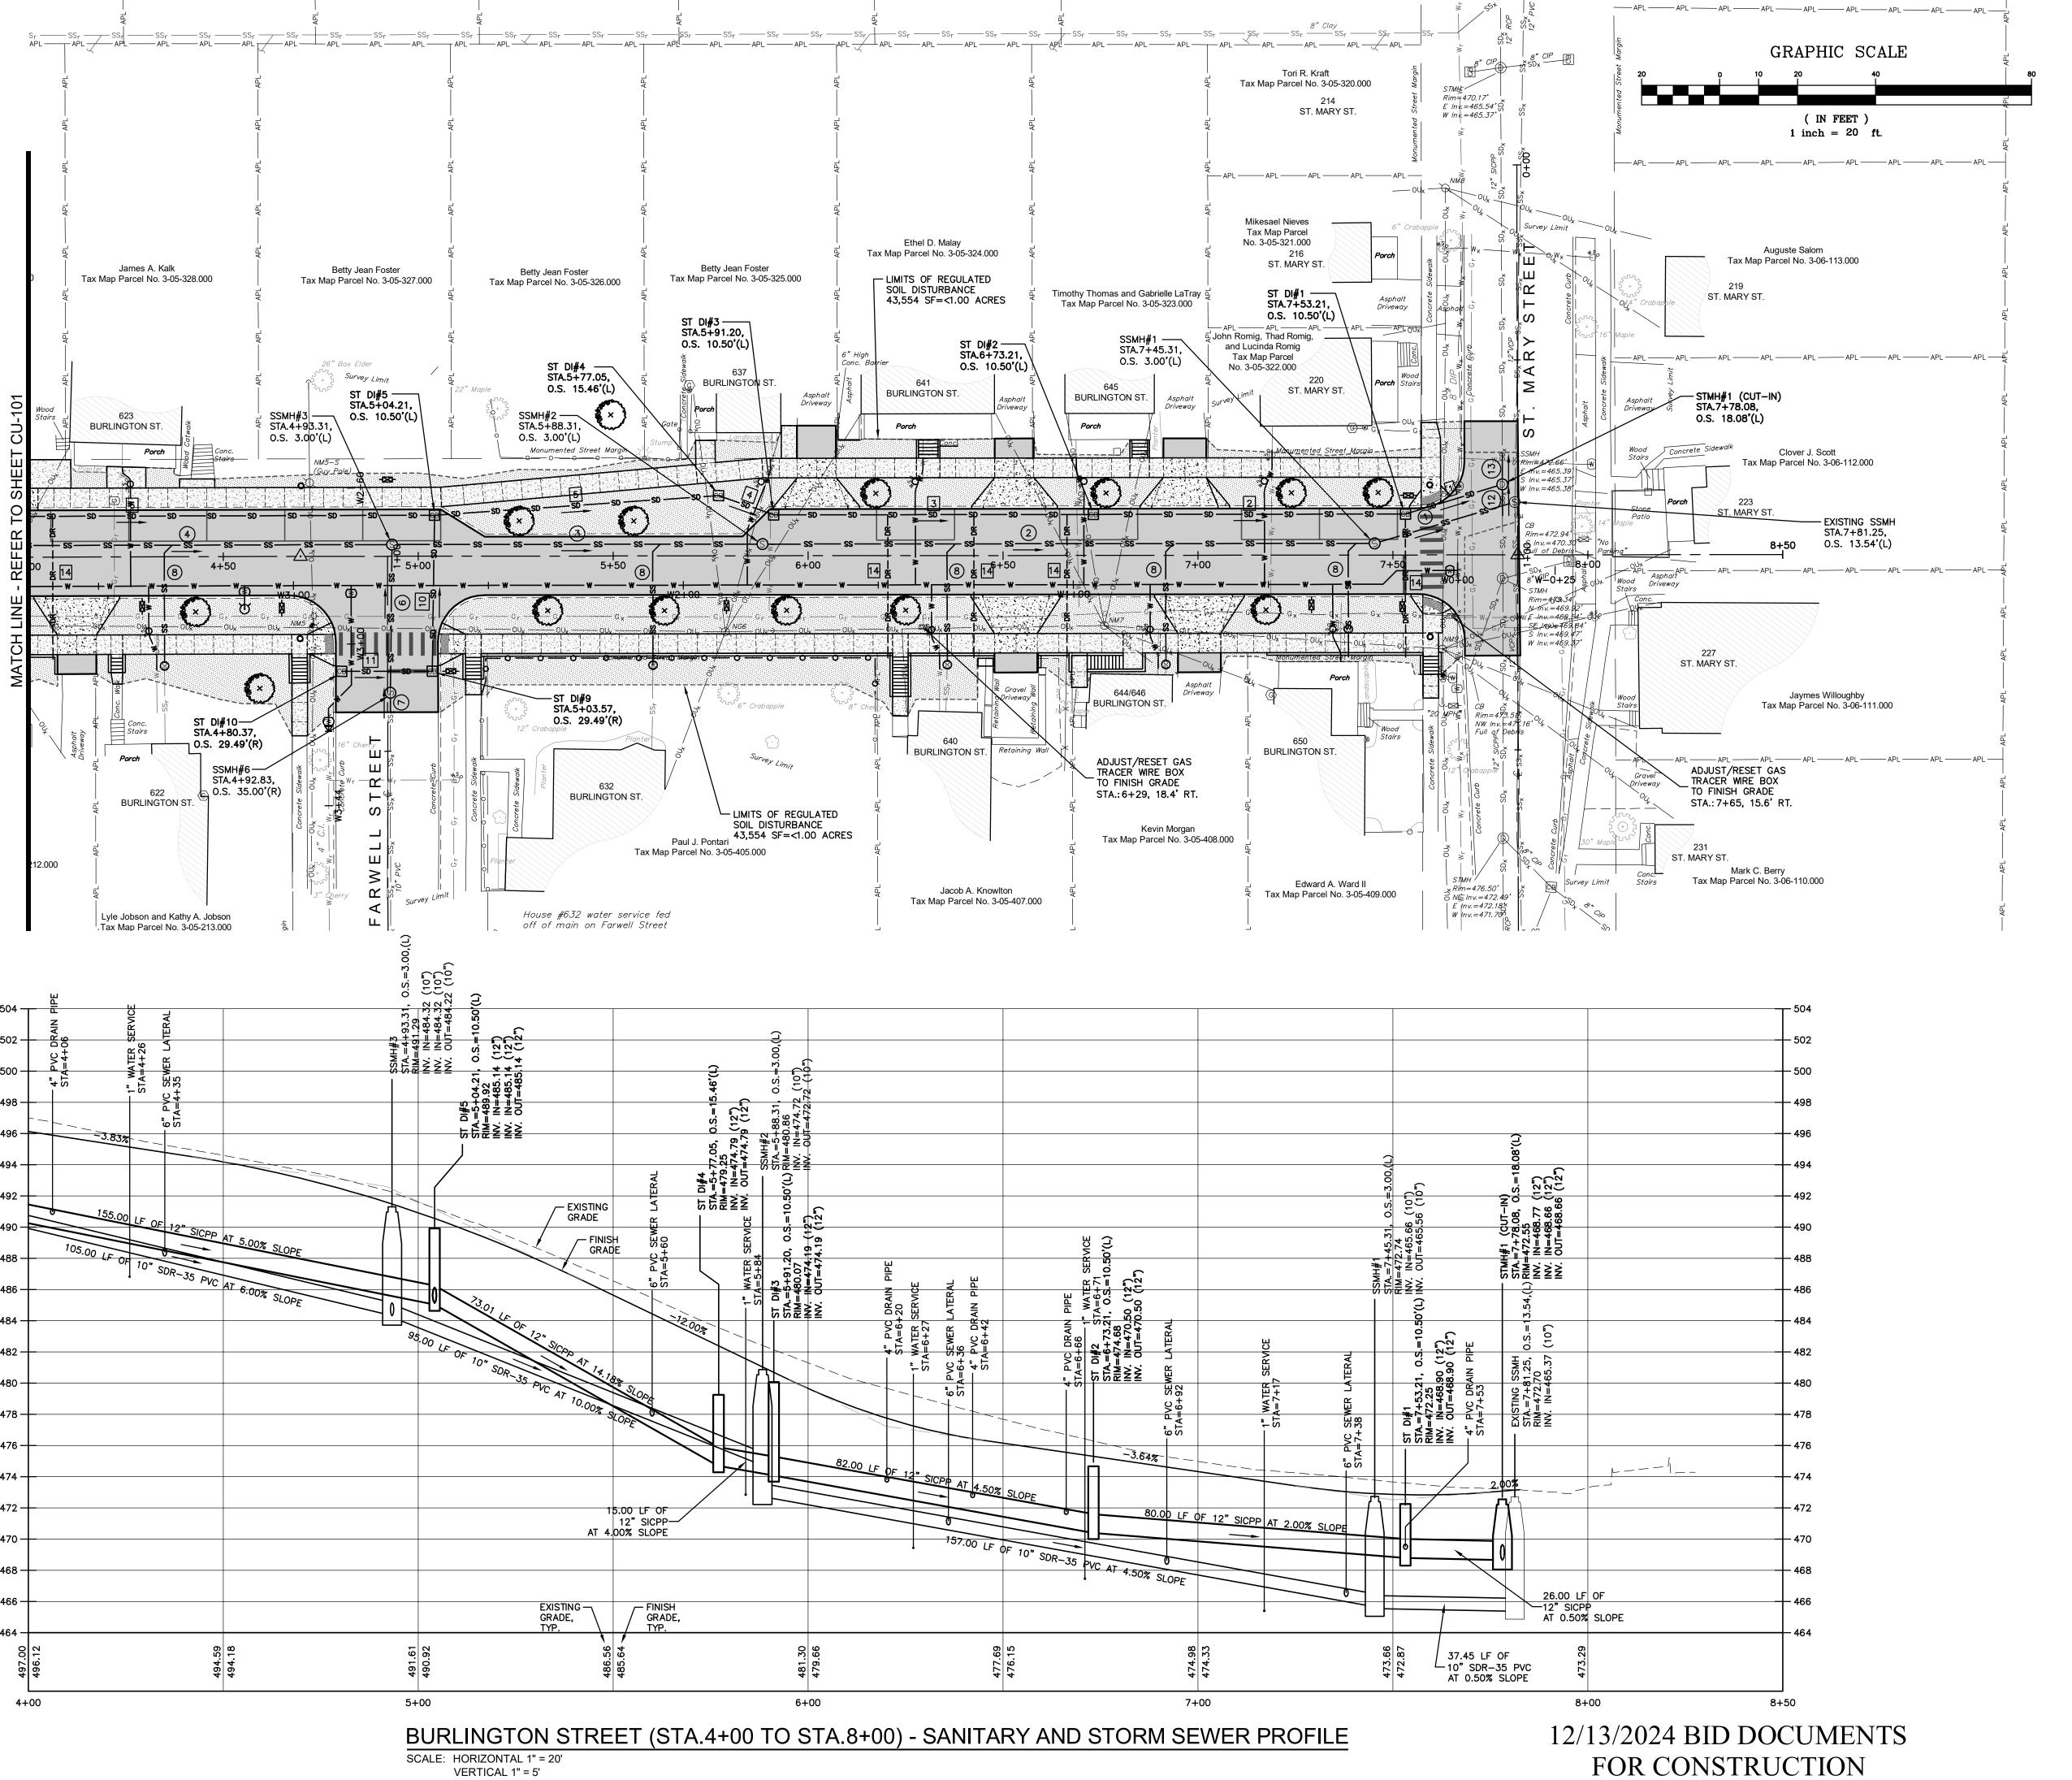FOR CONSTRUCTION





SANITAR	RY SEWER STRUC	TURE TABLE
STRUCTURE NAME	STATION AND OFFSET	RIMS AND INV
Existing SSMH	STA.=7+81.25, OFFESET 13.54', L	RIM=472.7 INV IN=465.
SSMH#1	STA.=7+45.31, OFFESET 3.00', L	RIM=472.7 INV IN=465. INV OUT=465
SSMH#2	STA.=5+88.31, OFFESET 3.00', L	RIM=480.8 INV IN=474. INV OUT=472
SSMH#3	STA.=4+93.31, OFFESET 3.00', L	RIM=491.2 INV IN=484. INV IN=484. INV OUT=484
SSMH#4	STA.=3+88.32, OFFESET 3.00', L	RIM=496.3 INV IN=490. INV OUT=490
SSMH#5	STA.=1+89.32, OFFESET 3.00', L	RIM=500.5 INV OUT=494

SANITARY SEWER PIPE TABLE			
PIPE TAG	SIZE	LENGTH	SLOPE
1	10"	37.45'	0.50%
2	10"	157.00'	4.50%
3	10"	95.00'	10.00%
4	10"	105.00'	6.00%
5	8"	199.00'	1.80%
6	10"	38.00'	5.50%
7	10"	5.00'	5.50%
	C" CDD 75 F	NO CANITADY	DEWED

STA.=4+92.83,

OFFESET 35.00', R

INV IN=486.51

INV OUT=486.41

6" SDR-35 PVC SANITARY SEWER LATERAL PIPE AT MIN. 2.00% SLOPE. (CONFIRM SIZE, TYPE, LOCATION AND ELEVATION OF EXISTING LATERAL. INSTALL CLEANOUT AND RECONNECT.)

STORM S	STORM SEWER STRUCTURE TABLE		
STRUCTURE NAME	STATION AND OFFSET	FRAMES AND INVERTS	
ST DI#1	STA.=7+53.21, OFFSET -10.50, L	FRAME=472.25 INV IN=468.90' INV OUT=468.90	
ST DI#2	STA.=6+73.21, OFFSET -10.50, L	FRAME=474.68 INV IN=470.50' INV OUT=470.50	
ST DI#3	STA.=5+91.20, OFFSET -10.50, L	FRAME=480.07 INV IN=474.19' INV OUT=474.19	
ST DI#4	STA.=5+77.05, OFFSET -15.46, L	FRAME=479.25 INV IN=474.79' INV OUT=474.79	
ST DI#5	STA.=5+04.21, OFFSET -10.50, L	FRAME=489.92 INV IN=485.14' INV IN=485.14' INV OUT=485.14	
ST DI#6	STA.=3+49.23, OFFSET -10.50, L	FRAME=497.16 INV IN=492.89' INV OUT=492.89	
ST DI#7	STA.=2+15.23, OFFSET -10.50, L	FRAME=499.70 INV IN=495.17' INV OUT=495.17	
ST DI#8	STA.=1+32.15, OFFSET 29.50, R	FRAME=504.30 INV OUT=497.98	
ST DI#9	STA.=5+03.57, OFFSET 29.49, R	FRAME=493.90 INV IN=488.34' INV OUT=488.34	
ST DI#10	STA.=4+80.37, OFFSET 29.49, R	FRAME=495.16 INV OUT=489.04	
STMH#1 (CUT-IN)	STA.=7+78.08, OFFSET -18.08, L	FRAME=472.55 INV IN=468.77' INV IN=468.66' INV OUT=468.66	
STMH#2	STA.=1+32.22, OFFSET -10.50, L	FRAME=500.50 INV IN=495.58' INV OUT=495.58	

STORM SEWER PIPE TABLE			
PIPE TAG	SIZE	LENGTH	SLOPE
1	12"	26.00'	0.50%
2	12"	80.00'	2.00%
3	12"	82.00'	4.50%
4	12"	15.00'	4.00%
5	12"	73.01'	14.18%
6	12"	155.00'	5.00%
7	12"	134.00'	1.70%
8	12"	83.00'	0.50%
9	12"	40.00'	6.00%
10	12"	40.00'	8.00%
11	12"	23.20'	3.00%
12	12"	8.00'	2.95%
13	12"	8.00'	2.95%
14	4" SDR-35 F	VC SOLID STOR	M DRAIN P

PIPE AT MIN. 1.00% SLOPE.

(PROVIDE BOOTED CONNECTION TO CITY
SINGLE CATCH BASIN OR DIRECT
CONNECTION TO SICPP STORM SEWER PIPE
WITH AN INSERT—A—TEE FITTING INTO THE
STORM SEWER SYSTEM. CONNECT SOLID PIPE TO PERFORATED UNDERDRAIN PIPE ON THE BACK SIDE OF THE RETAINING WALL)

**ARCHITECTS, ENGINEERS** 

& LAND SURVEYORS, PLLC NYS WBE/DBE Certified SBA Woman Owned

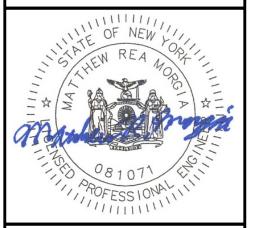
Small Business (WOSB)

aubertinecurrier.com

522 Bradley Street Watertown, New York 13601

Phone: (315)782-2005

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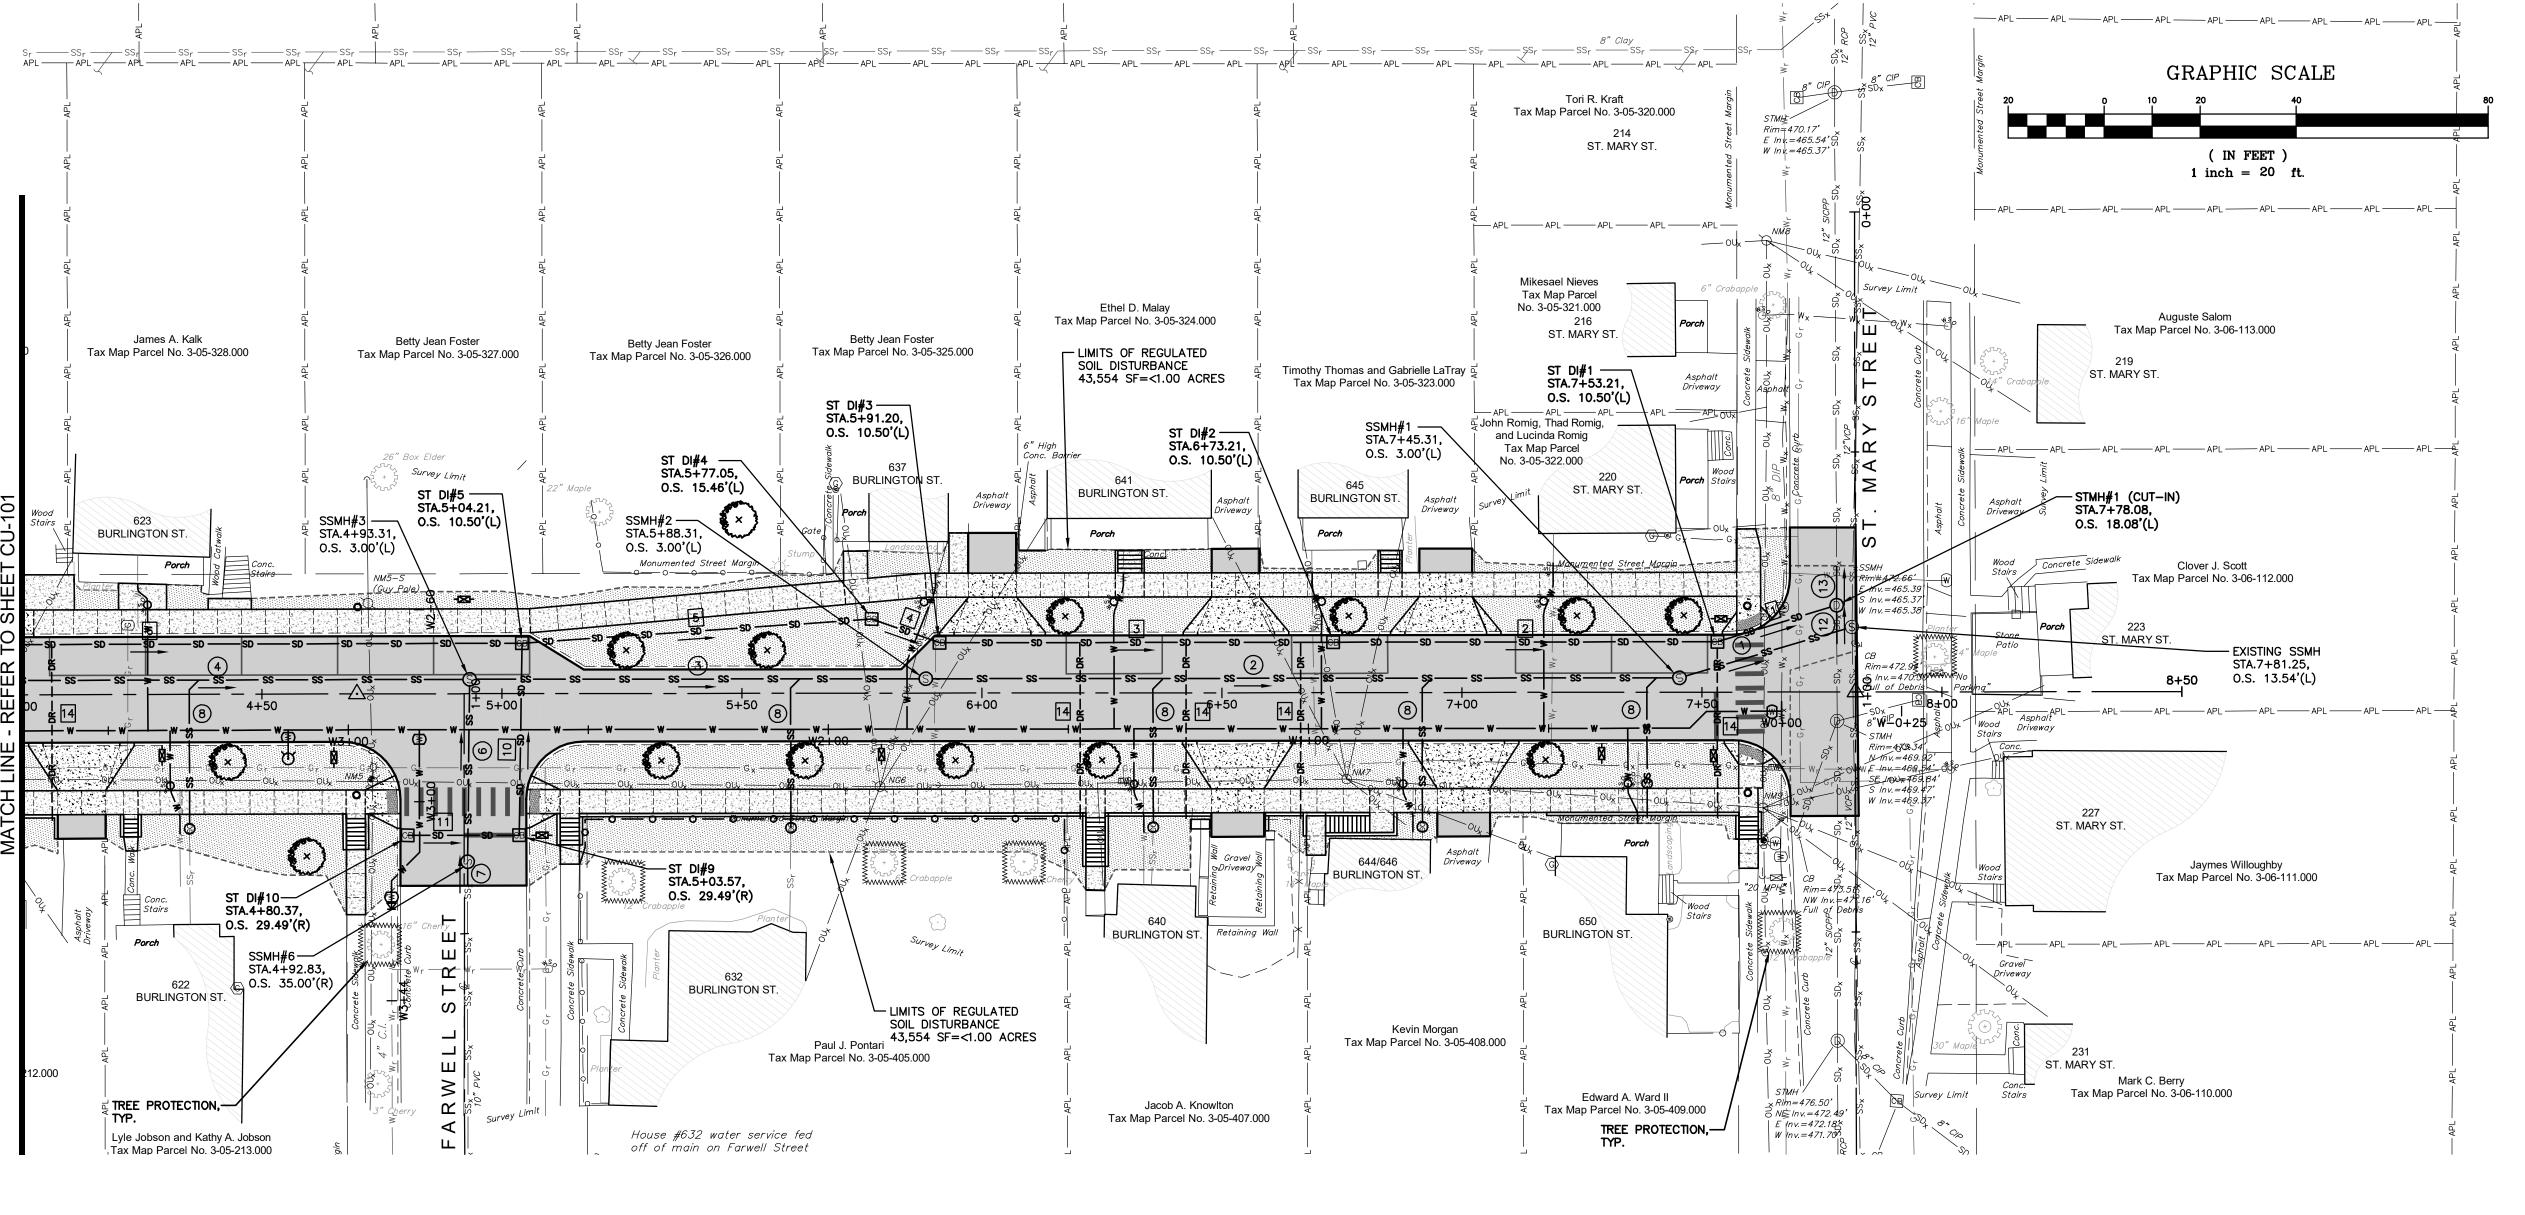



YORK

BURLINGTON STREET
RECONSTRUCTION PROJEC
CITY OF WATERTOWN
ENGINEERING DEPARTMENT
JEFFERSON COUNTY, STATE OF NEW YO


PROJECT NO: 2023-052 DRAWN BY: TFT CHECKED BY: MRM ISSUE DATES: 02/23/2024 04/30/2024 12/13/2024

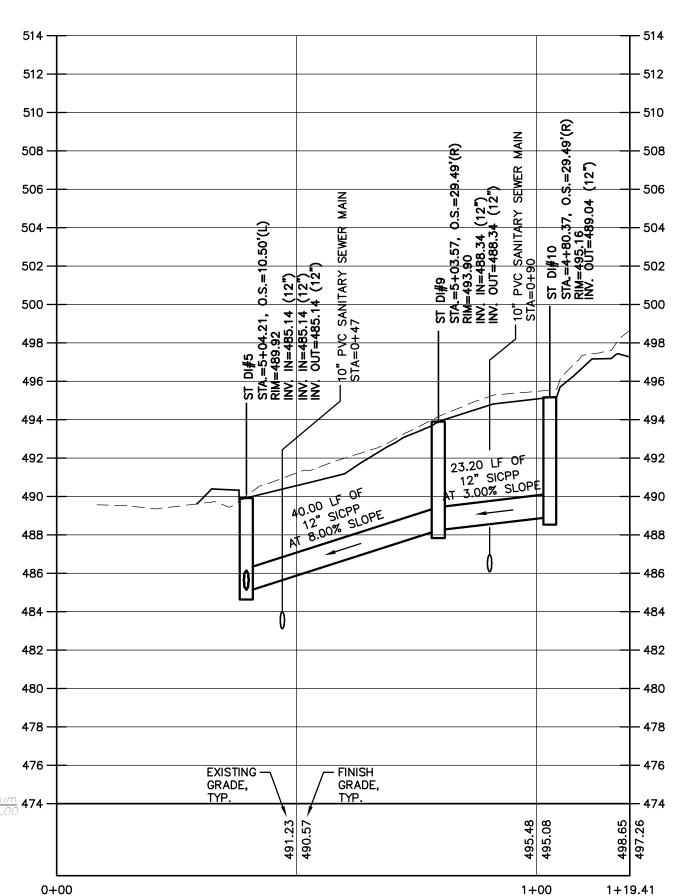UTILITY PLAN AND PROFILE SANITARY AND STORM SEWER






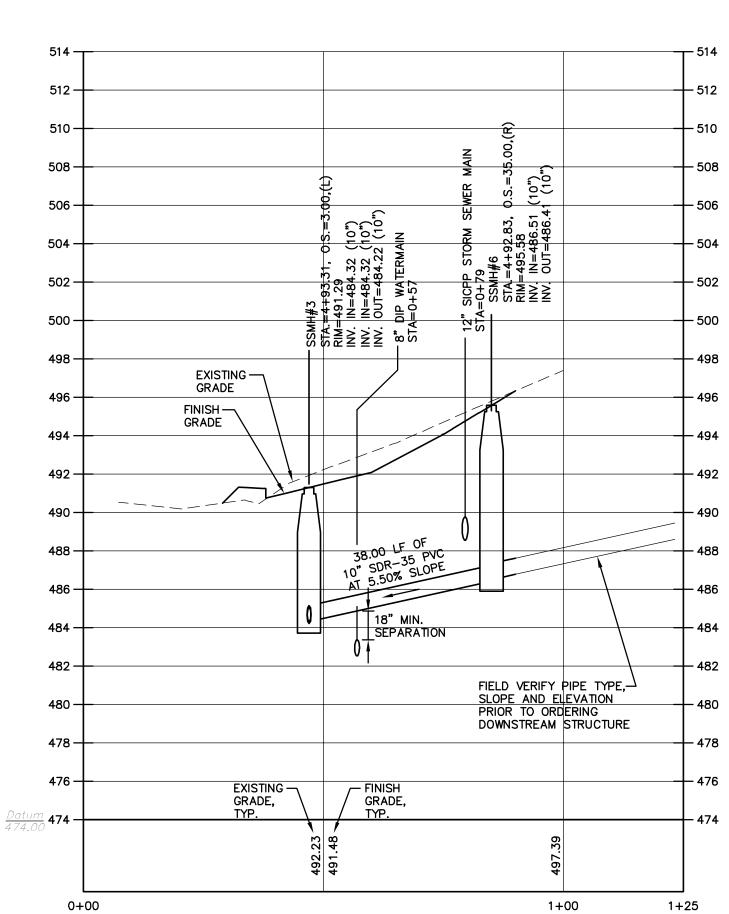STORM SEWER PROFILE - FARWELL STREET SCALE: HORIZONTAL 1" = 20' VERTICAL 1" = 5'



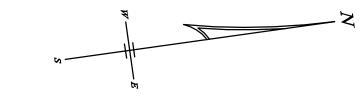SANITARY SEWER PROFILE - FARWELL STREET SCALE: HORIZONTAL 1" = 20' VERTICAL 1" = 5'



SANITARY SEWER STRUCTURE TABLE		
STRUCTURE NAME	STATION AND OFFSET	RIMS AND INVERTS
Existing SSMH	STA.=7+81.25, OFFESET 13.54', L	RIM=472.70 INV IN=465.37'
SSMH#1	STA.=7+45.31, OFFESET 3.00', L	RIM=472.74 INV IN=465.66' INV OUT=465.56
SSMH#2	STA.=5+88.31, OFFESET 3.00', L	RIM=480.86 INV IN=474.72' INV OUT=472.72
SSMH#3	STA.=4+93.31, OFFESET 3.00', L	RIM=491.29 INV IN=484.32' INV IN=484.32' INV OUT=484.22
SSMH#4	STA.=3+88.32, OFFESET 3.00', L	RIM=496.38 INV IN=490.80' INV OUT=490.62
SSMH#5	STA.=1+89.32, OFFESET 3.00', L	RIM=500.59 INV OUT=494.38
SSMH#6	STA.=4+92.83, OFFESET 35.00', R	RIM=495.58 INV IN=486.51' INV OUT=486.41

SANITARY SEWER PIPE TABLE			
PIPE TAG	SIZE	LENGTH	SLOPE
1	10"	37.45'	0.50%
2	10"	157.00'	4.50%
3	10"	95.00'	10.00%
4	10"	105.00'	6.00%
5	8"	199.00'	1.80%
6	10"	38.00'	5.50%
7	10"	5.00'	5.50%
8	6" SDR-35 PVC SANITARY SEWER		


LATERAL PIPE AT MIN. 2.00% SLOPE. (CONFIRM SIZE, TYPE, LOCATION AND ELEVATION OF EXISTING LATERAL. INSTALL CLEANOUT AND RECONNECT.)

STORM S	RE TABLE	
STRUCTURE NAME	STATION AND OFFSET	FRAMES AND INVERTS
ST DI#1	STA.=7+53.21, OFFSET -10.50, L	FRAME=472.25 INV IN=468.90' INV OUT=468.90
ST DI#2	STA.=6+73.21, OFFSET -10.50, L	FRAME=474.68 INV IN=470.50' INV OUT=470.50
ST DI#3	STA.=5+91.20, OFFSET -10.50, L	FRAME=480.07 INV IN=474.19' INV OUT=474.19
ST DI#4	STA.=5+77.05, OFFSET -15.46, L	FRAME=479.25 INV IN=474.79' INV OUT=474.79
ST DI#5	STA.=5+04.21, OFFSET -10.50, L	FRAME=489.92 INV IN=485.14' INV IN=485.14' INV OUT=485.14
ST DI#6	STA.=3+49.23, OFFSET -10.50, L	FRAME=497.16 INV IN=492.89' INV OUT=492.89
ST DI#7	STA.=2+15.23, OFFSET -10.50, L	FRAME=499.70 INV IN=495.17' INV OUT=495.17
ST DI#8	STA.=1+32.15, OFFSET 29.50, R	FRAME=504.30 INV OUT=497.98
ST DI#9	STA.=5+03.57, OFFSET 29.49, R	FRAME=493.90 INV IN=488.34' INV OUT=488.34
ST DI#10	STA.=4+80.37, OFFSET 29.49, R	FRAME=495.16 INV OUT=489.04
STMH#1 (CUT-IN)	STA.=7+78.08, OFFSET -18.08, L	FRAME=472.55 INV IN=468.77' INV IN=468.66' INV OUT=468.66
STMH#2	STA.=1+32.22, OFFSET -10.50, L	FRAME=500.50 INV IN=495.58' INV OUT=495.58

STORM SEWER PIPE TABLE			
PIPE TAG	SIZE	LENGTH	SLOPE
1	12"	26.00'	0.50%
2	12"	80.00'	2.00%
3	12"	82.00'	4.50%
4	12"	15.00'	4.00%
5	12"	73.01	14.18%
6	12"	155.00'	5.00%
7	12"	134.00'	1.70%
8	12"	83.00'	0.50%
9	12"	40.00'	6.00%
10	12"	40.00'	8.00%
11	12"	23.20'	3.00%
12	12"	8.00'	2.95%
13	12"	8.00'	2.95%
14	4" SDR-35 PVC SOLID STORM DRAIN PIPE AT MIN. 1.00% SLOPE. (PROVIDE BOOTED CONNECTION TO CITY		

SINGLE CATCH BASIN OR DIRECT CONNECTION TO SICPP STORM SEWER PIPE WITH AN INSERT—A—TEE FITTING INTO THE STORM SEWER SYSTEM. CONNECT SOLID PIPE TO PERFORATED UNDERDRAIN PIPE ON THE BACK SIDE OF THE RETAINING WALL)

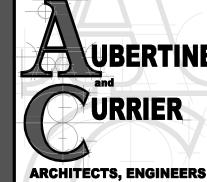12/13/2024 BID DOCUMENTS FOR CONSTRUCTION



& LAND SURVEYORS, PLLC NYS WBE/DBE Certified

SBA Woman Owned

Small Business (WOSB)

aubertinecurrier.com

522 Bradley Street Watertown, New York 13601

Phone: (315)782-2005

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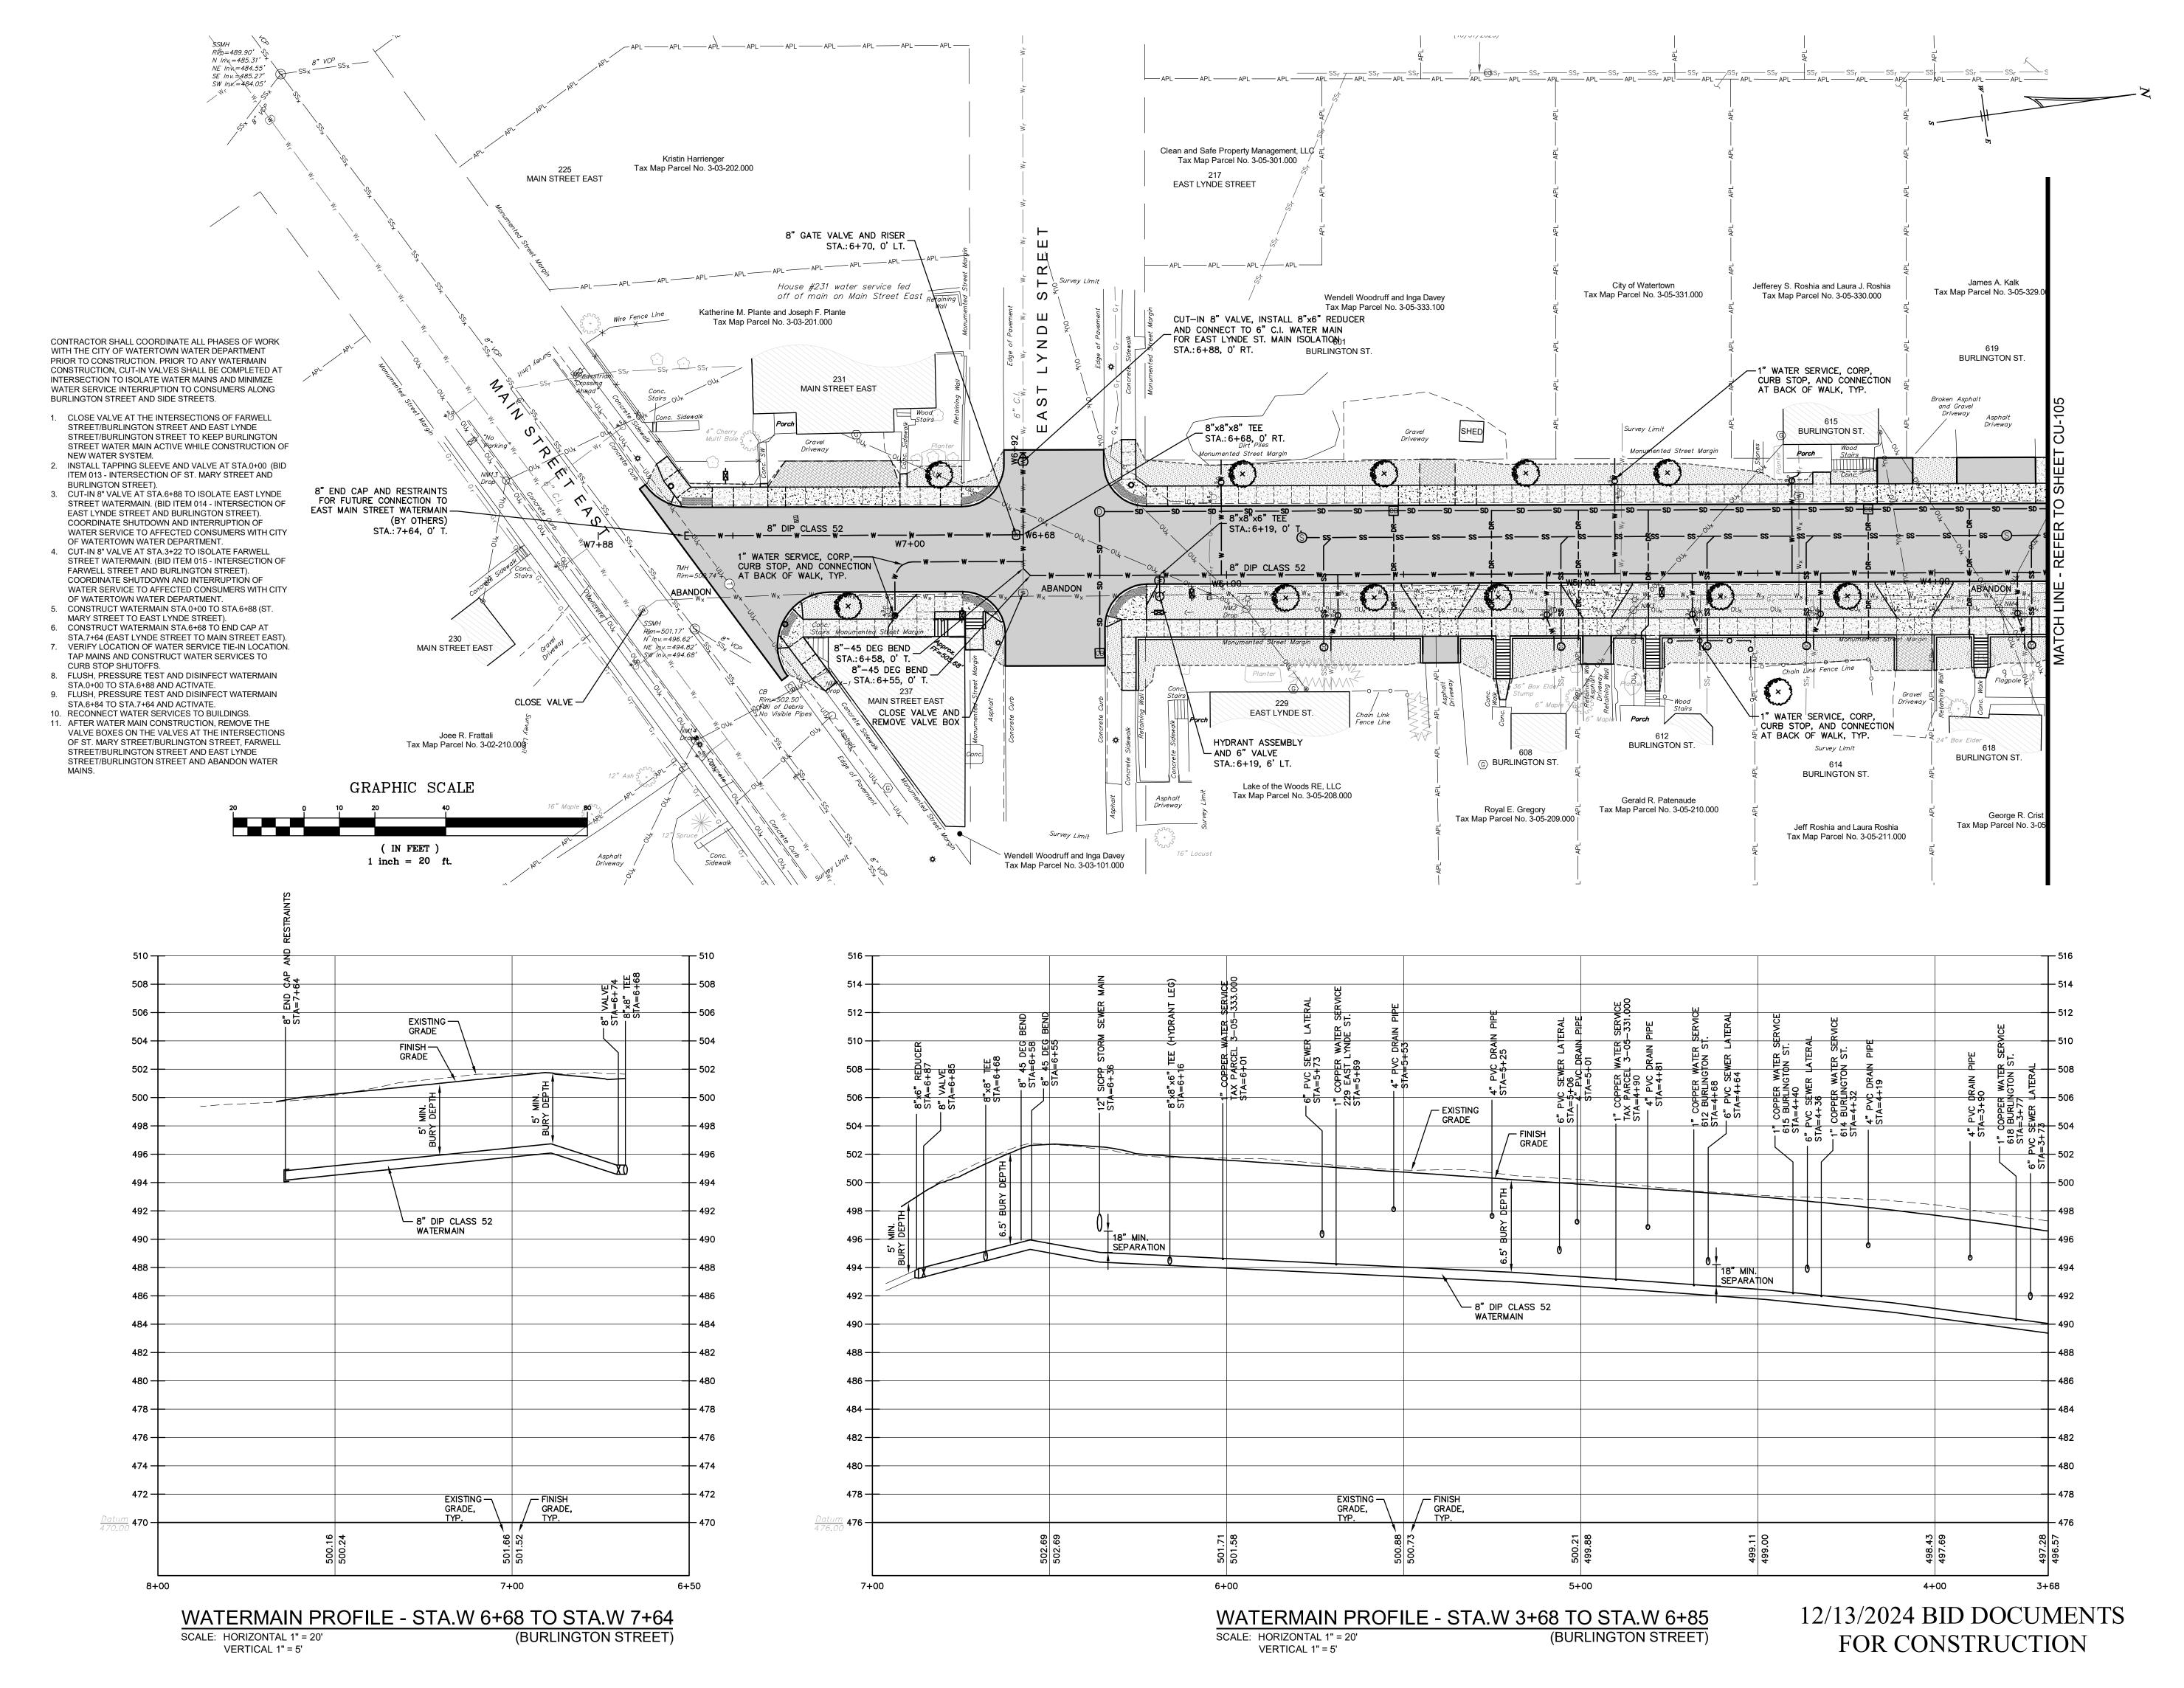
YORK

CITY OF WA ENGINEERING JEFFERSON COUNTY, CONSTRUC R

PROJECT NO: 2023-052 DRAWN BY: TFT CHECKED BY: MRM ISSUE DATES: 02/23/2024 04/30/2024

SANITARY AND STORM SEWER **PROFILES** 

12/13/2024



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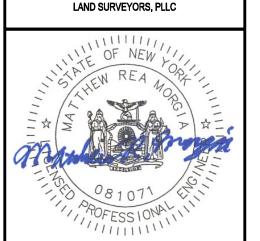
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& LAND SURVEYORS, PLLC

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Phone: (315)782-2005



BURLINGTON STREET
CONSTRUCTION PROJECT

RECONSTRUCTION PROJICITY OF WATERTOWN ENGINEERING DEPARTMENT JEFFERSON COUNTY, STATE OF NEW

YORK

PROJECT NO: 2023-052

SCALE: 1"=20'


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UTILITY PLAN AND PROFILE WATERMAIN

**CU-104** 



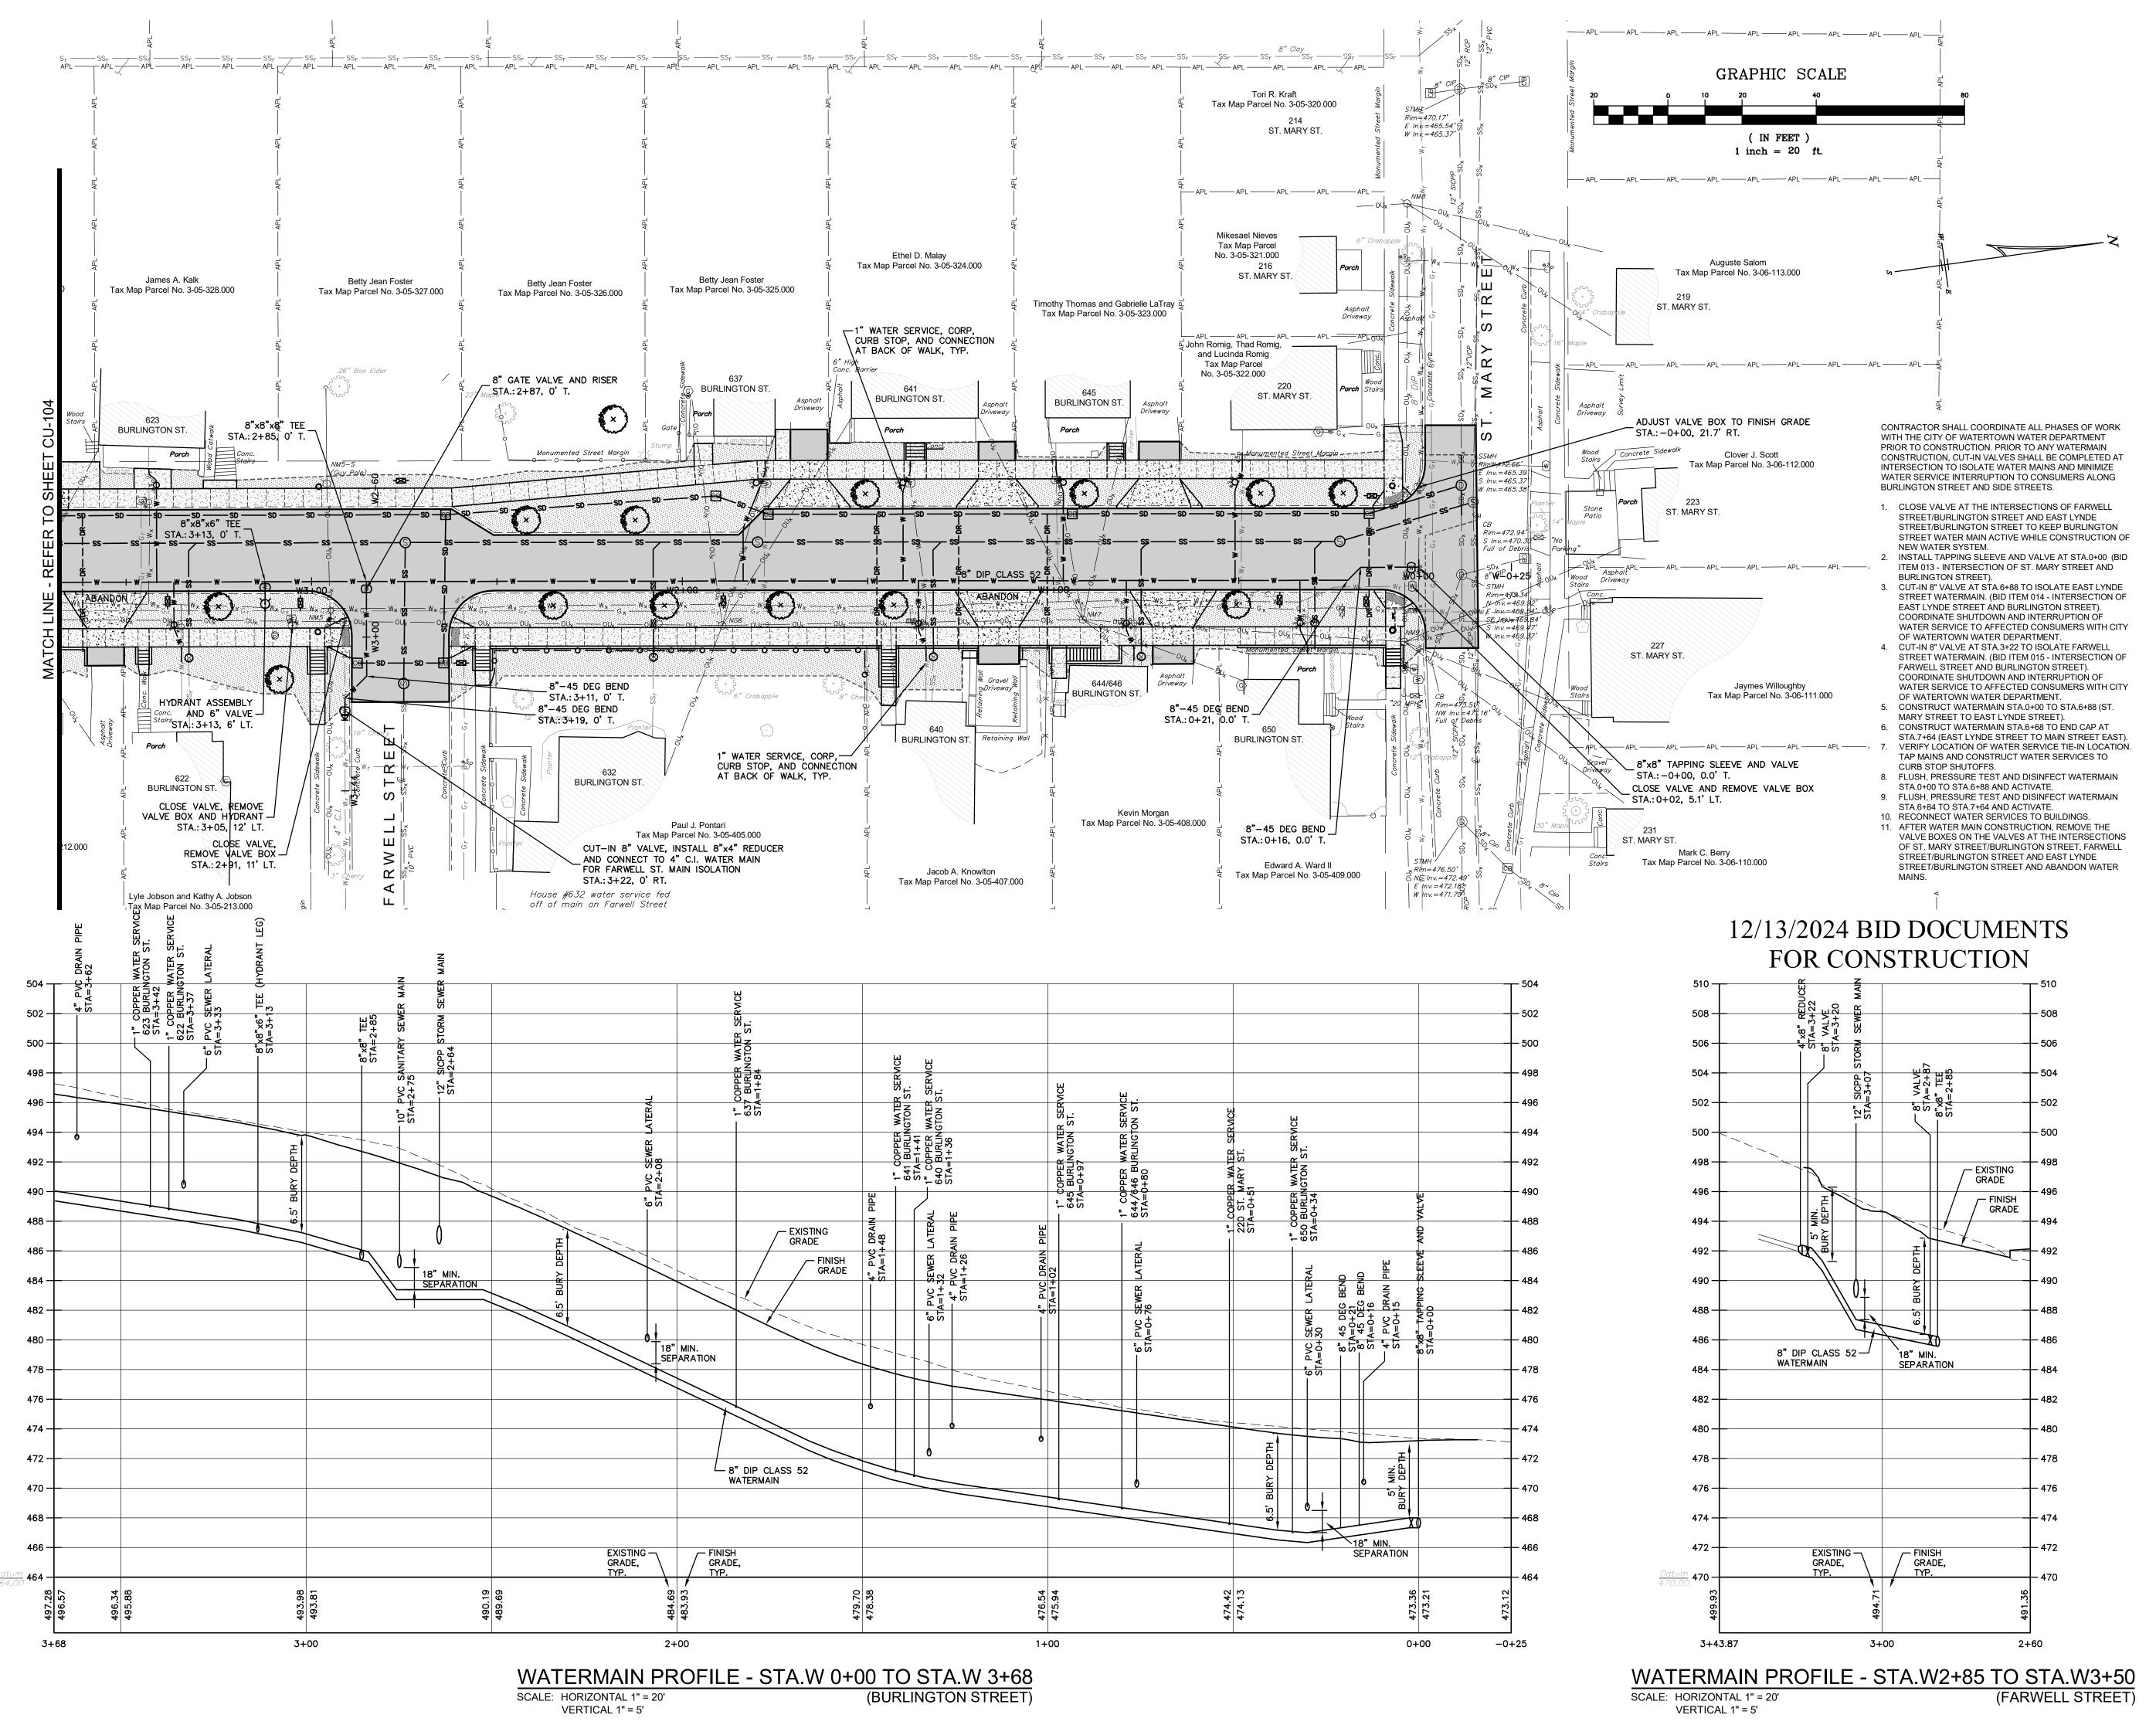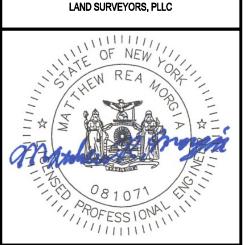
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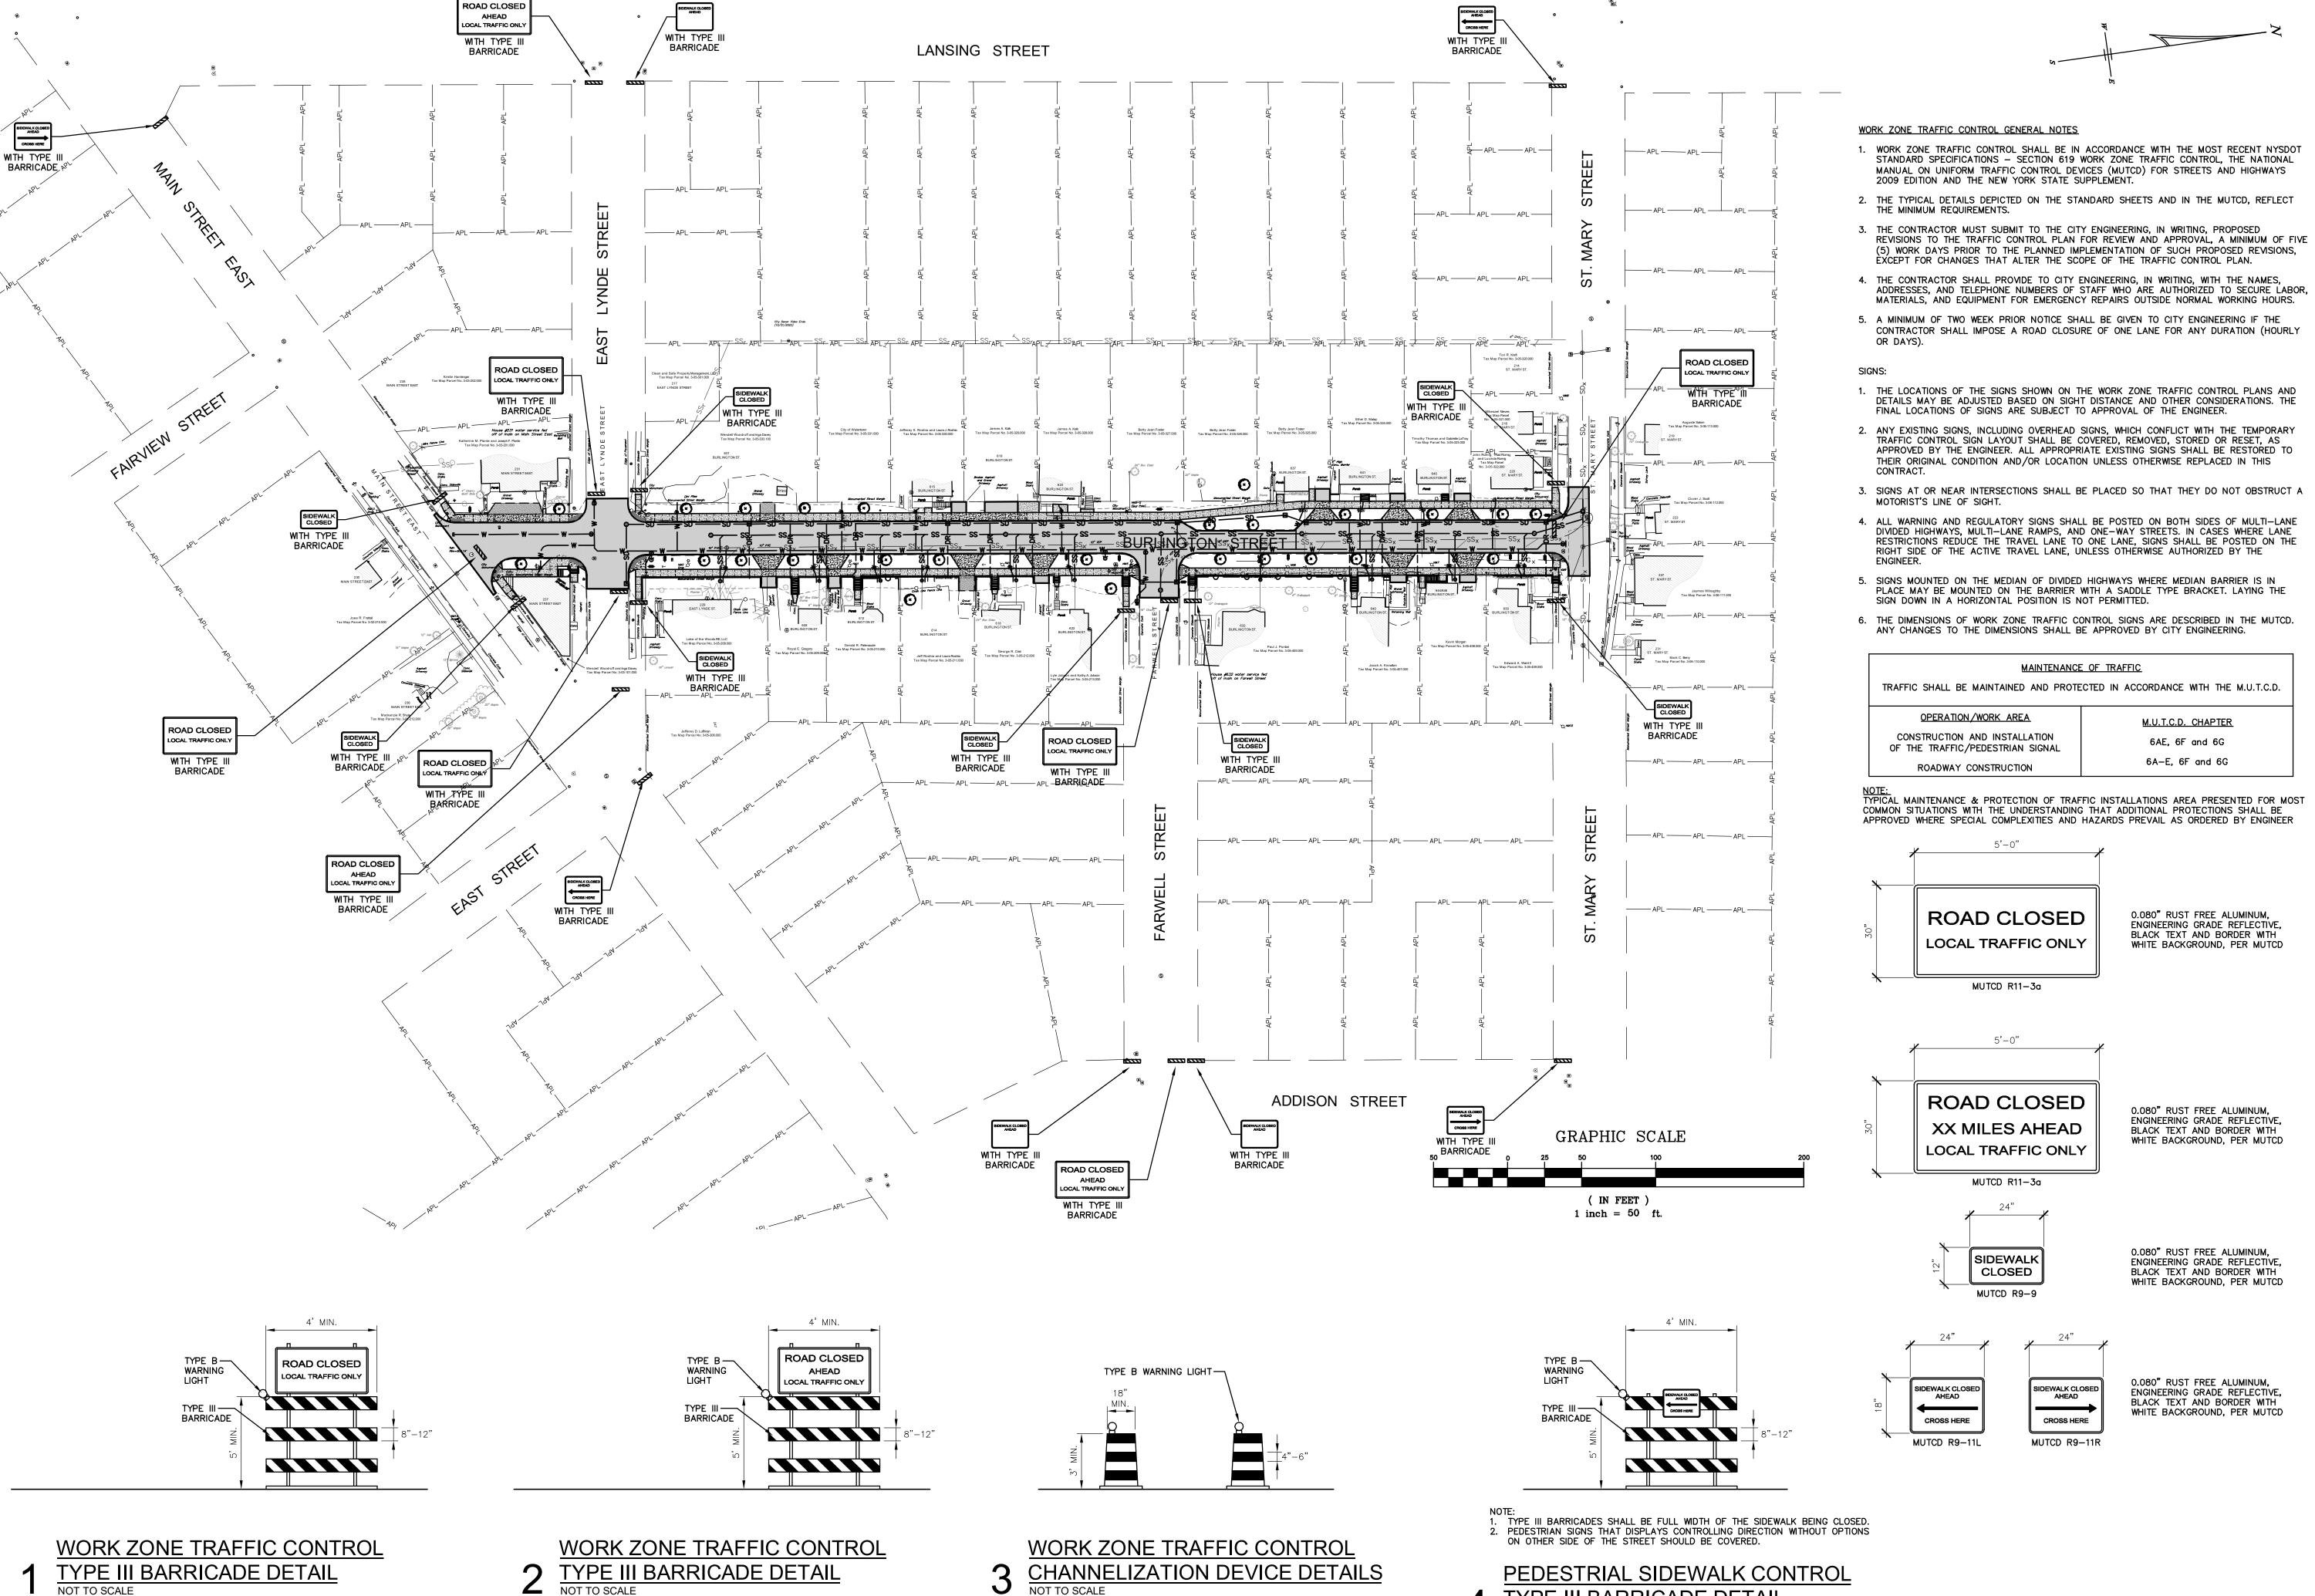
YORK

BURLINGTON STREET
RECONSTRUCTION PROJECTY OF WATERTOWN
ENGINEERING DEPARTMENT
JEFFERSON COUNTY, STATE OF NEW YO

PROJECT NO: 2023-052 DRAWN BY: TFT

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UTILITY PLAN AND PROFILE



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STREET ON PROJE

RECONSTRUCT
CITY OF WATERING DEFFERSON COUNTY, S

BURLING

PROJECT NO: 2023-052

SCALE: 1"=50"

DRAWN BY: TFT

CHECKED BY: MRM

ISSUE DATES:

02/23/2024 04/30/2024 12/13/2024

YORK


TYPE III BARRICADE DETAIL

CONTROL PLAN 12/13/2024 BID DOCUMENTS

FOR CONSTRUCTION


**CT-100** 

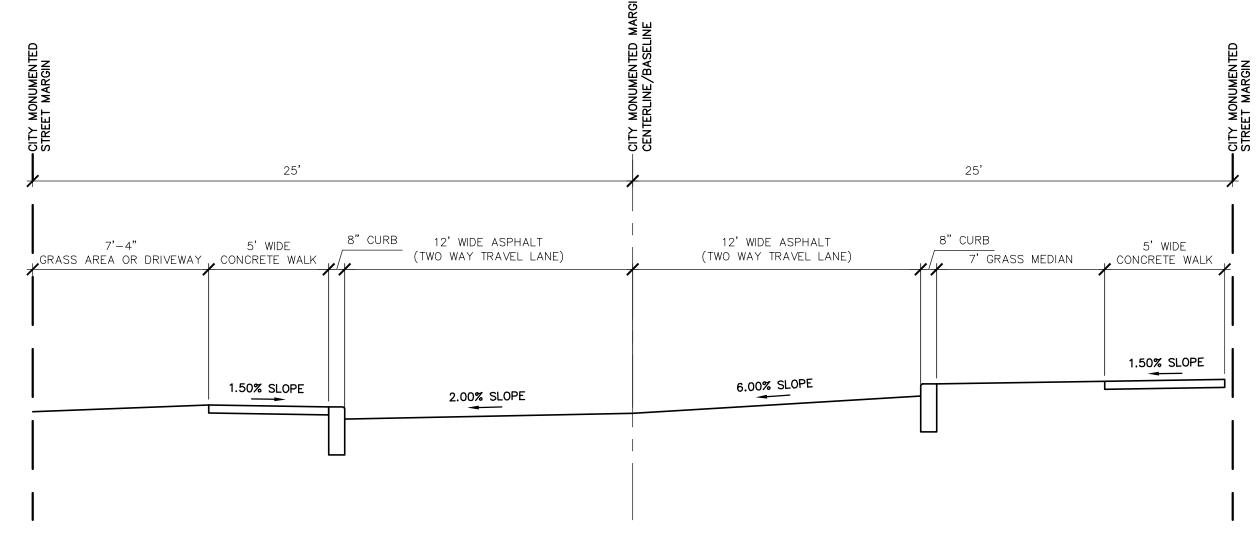WORK ZONE TRAFFIC




TYPICAL STREET CROSS SECTION (STA.0+55 TO STA.0+93)

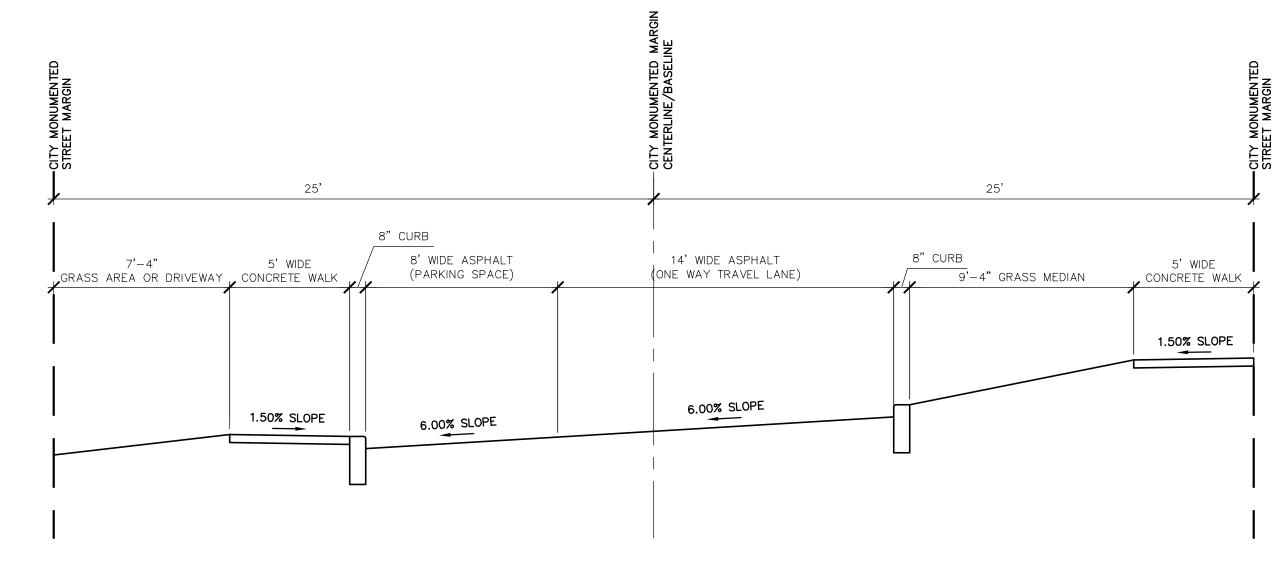SCALE: 1" = 4'




TYPICAL STREET CROSS SECTION (STA.1+45 TO STA.4+67)

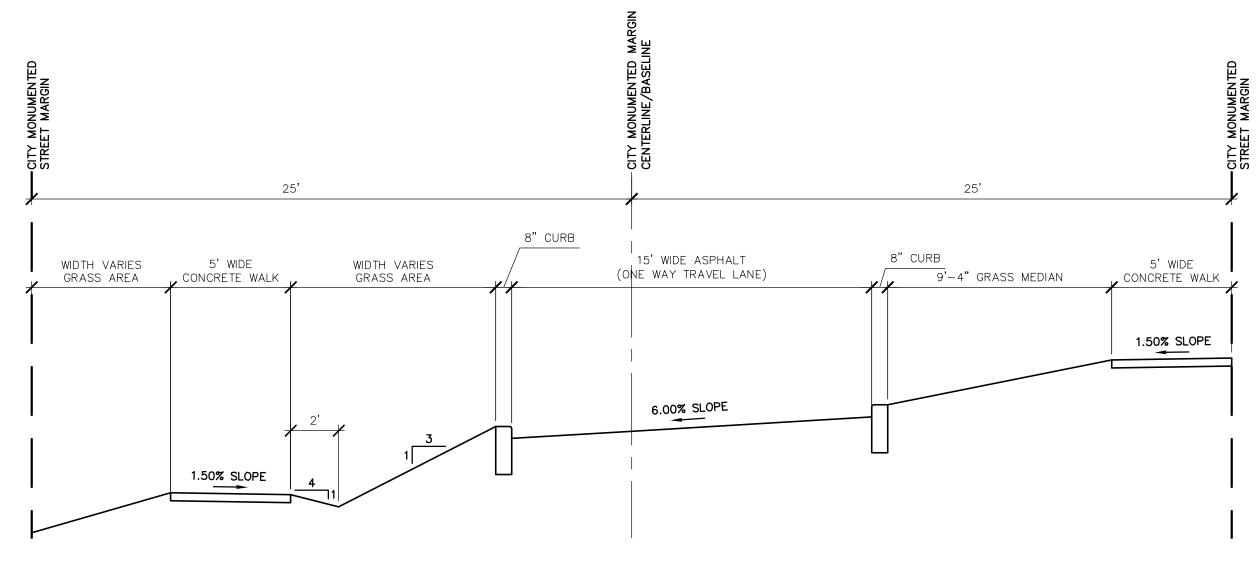SCALE: 1" = 4'




TYPICAL STREET CROSS SECTION (STA.5+17 TO STA.5+83)

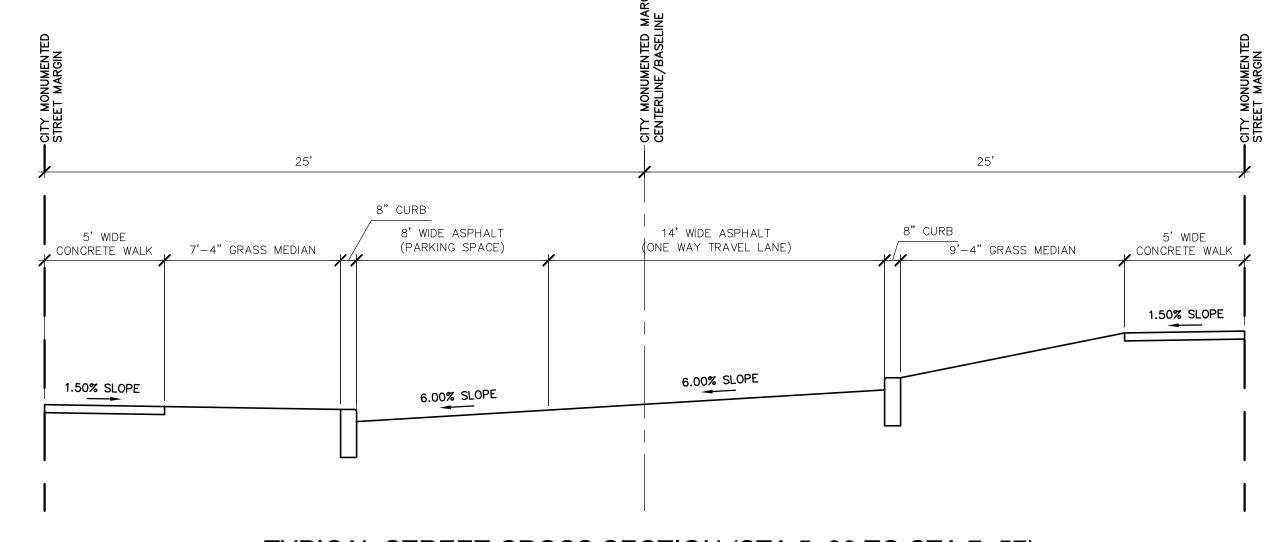SCALE: 1" = 4'



TYPICAL STREET CROSS SECTION (STA.5+90 TO STA.7+57)

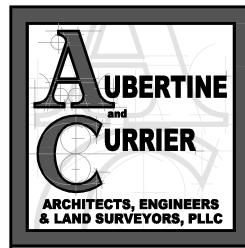SCALE: 1" = 4'



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STON STREET
UCTION PROJECT
NE WATERTOWN

YORK


RECONSTRUCTION
CITY OF WATERT
ENGINEERING DEPAF
JEFFERSON COUNTY, STATE

ROJECT NO: 2023-052

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TYPICAL STREET CROSS SECTIONS


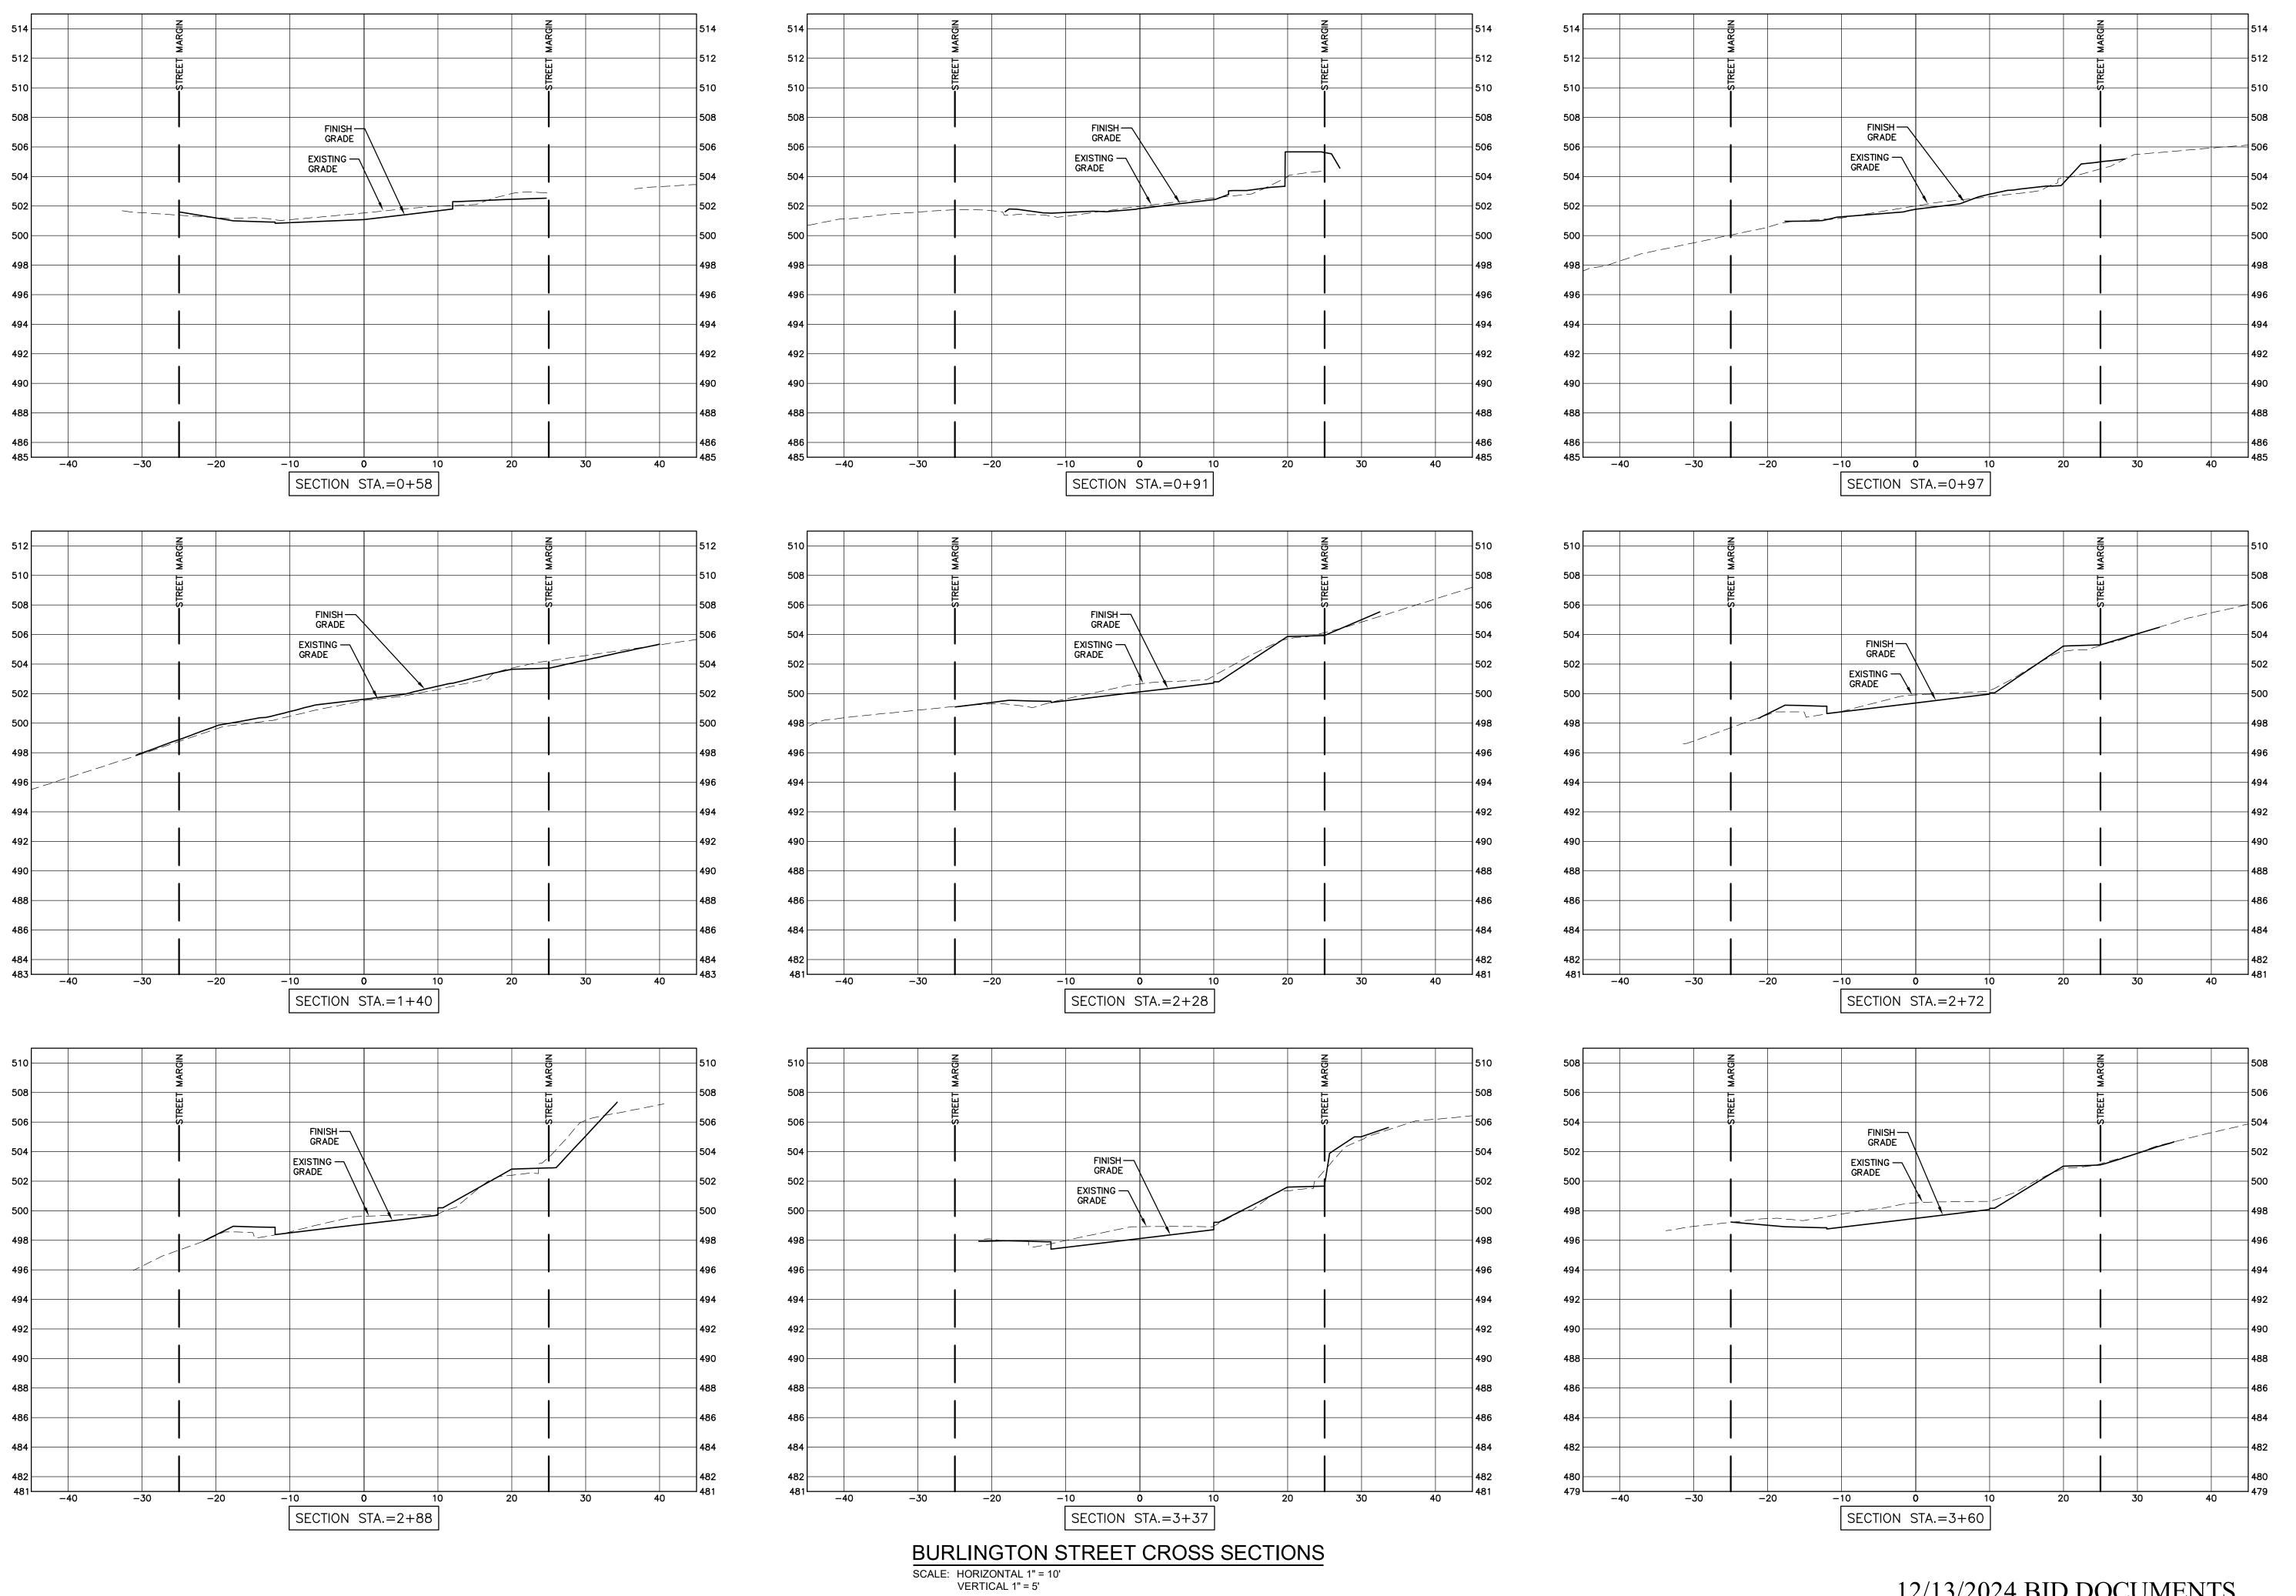
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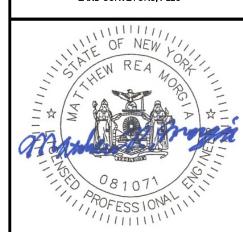
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BURLINGTON STREET
RECONSTRUCTION PROJECT
CITY OF WATERTOWN
ENGINEERING DEPARTMENT
JEFFERSON COUNTY, STATE OF NEW YORK

PROJECT NO: 2023-052

 PROJECT NO:
 2023-052

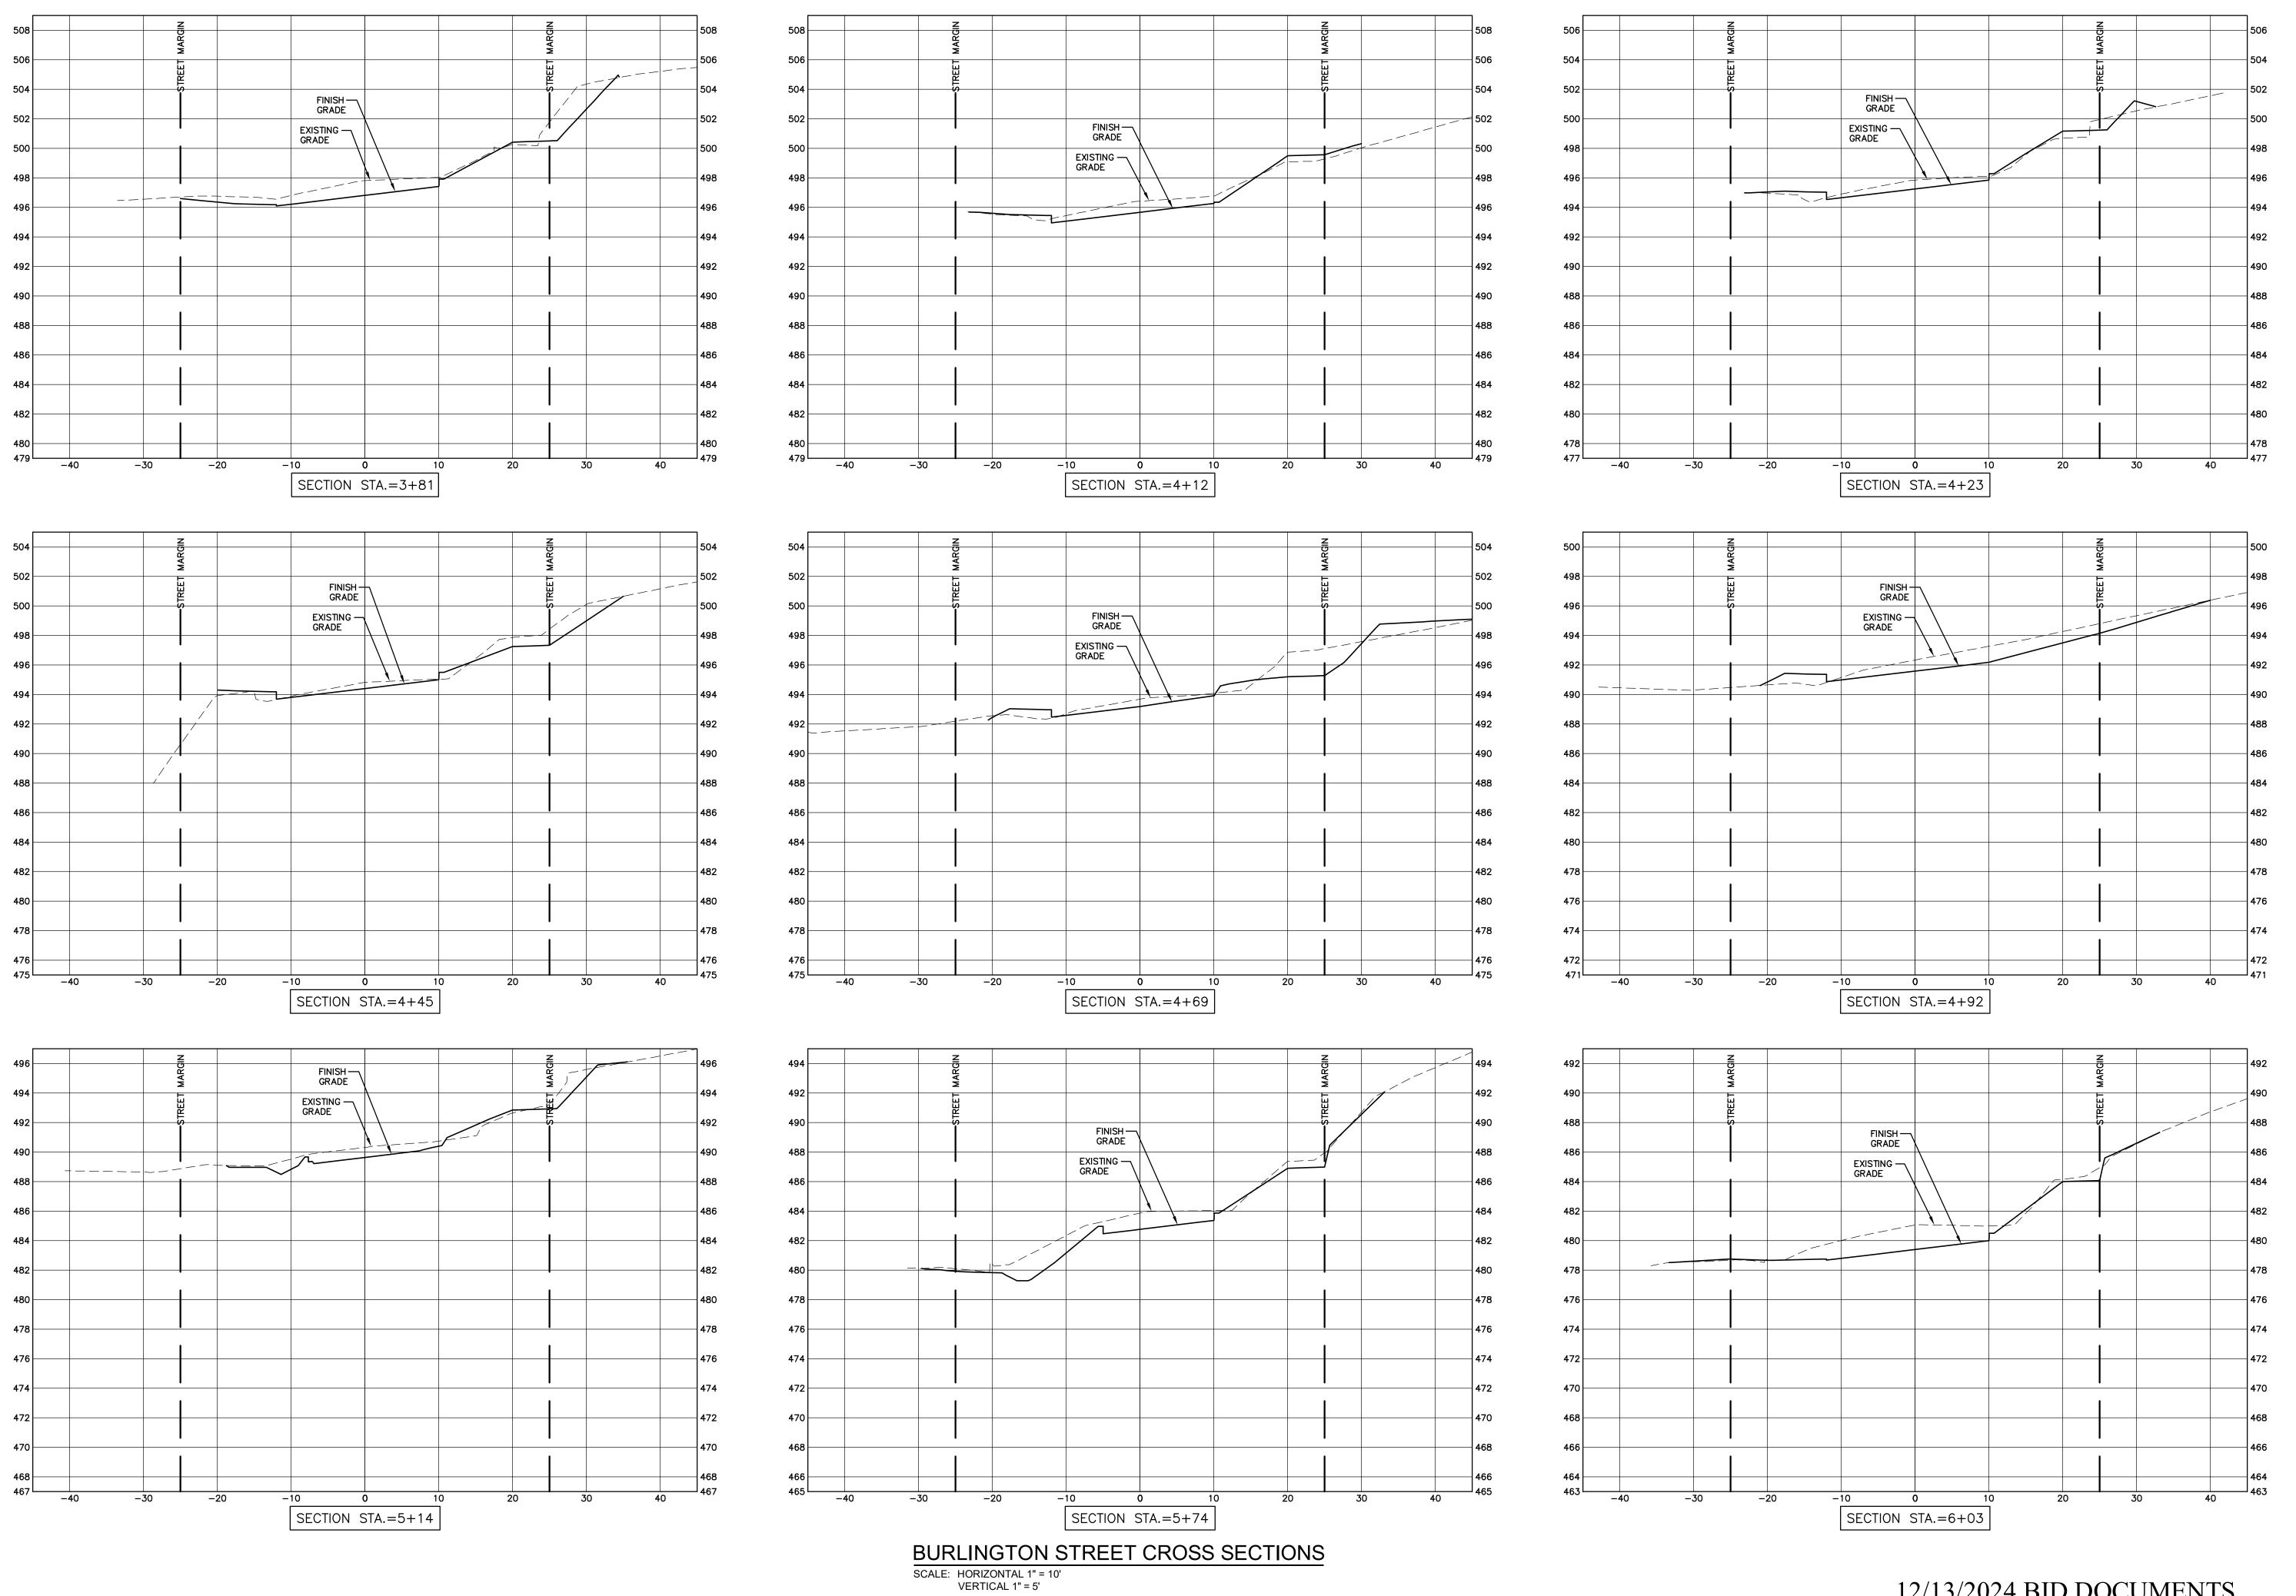
 SCALE:
 AS NOTED

 DRAWN BY:
 TFT

CHECKED BY: MRM

ISSUE DATES:
02/23/2024
04/30/2024
12/13/2024

BURLINGTON STREET CROSS SECTIONS



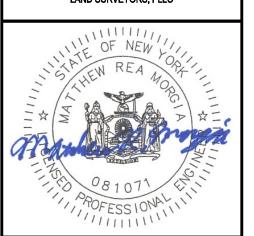
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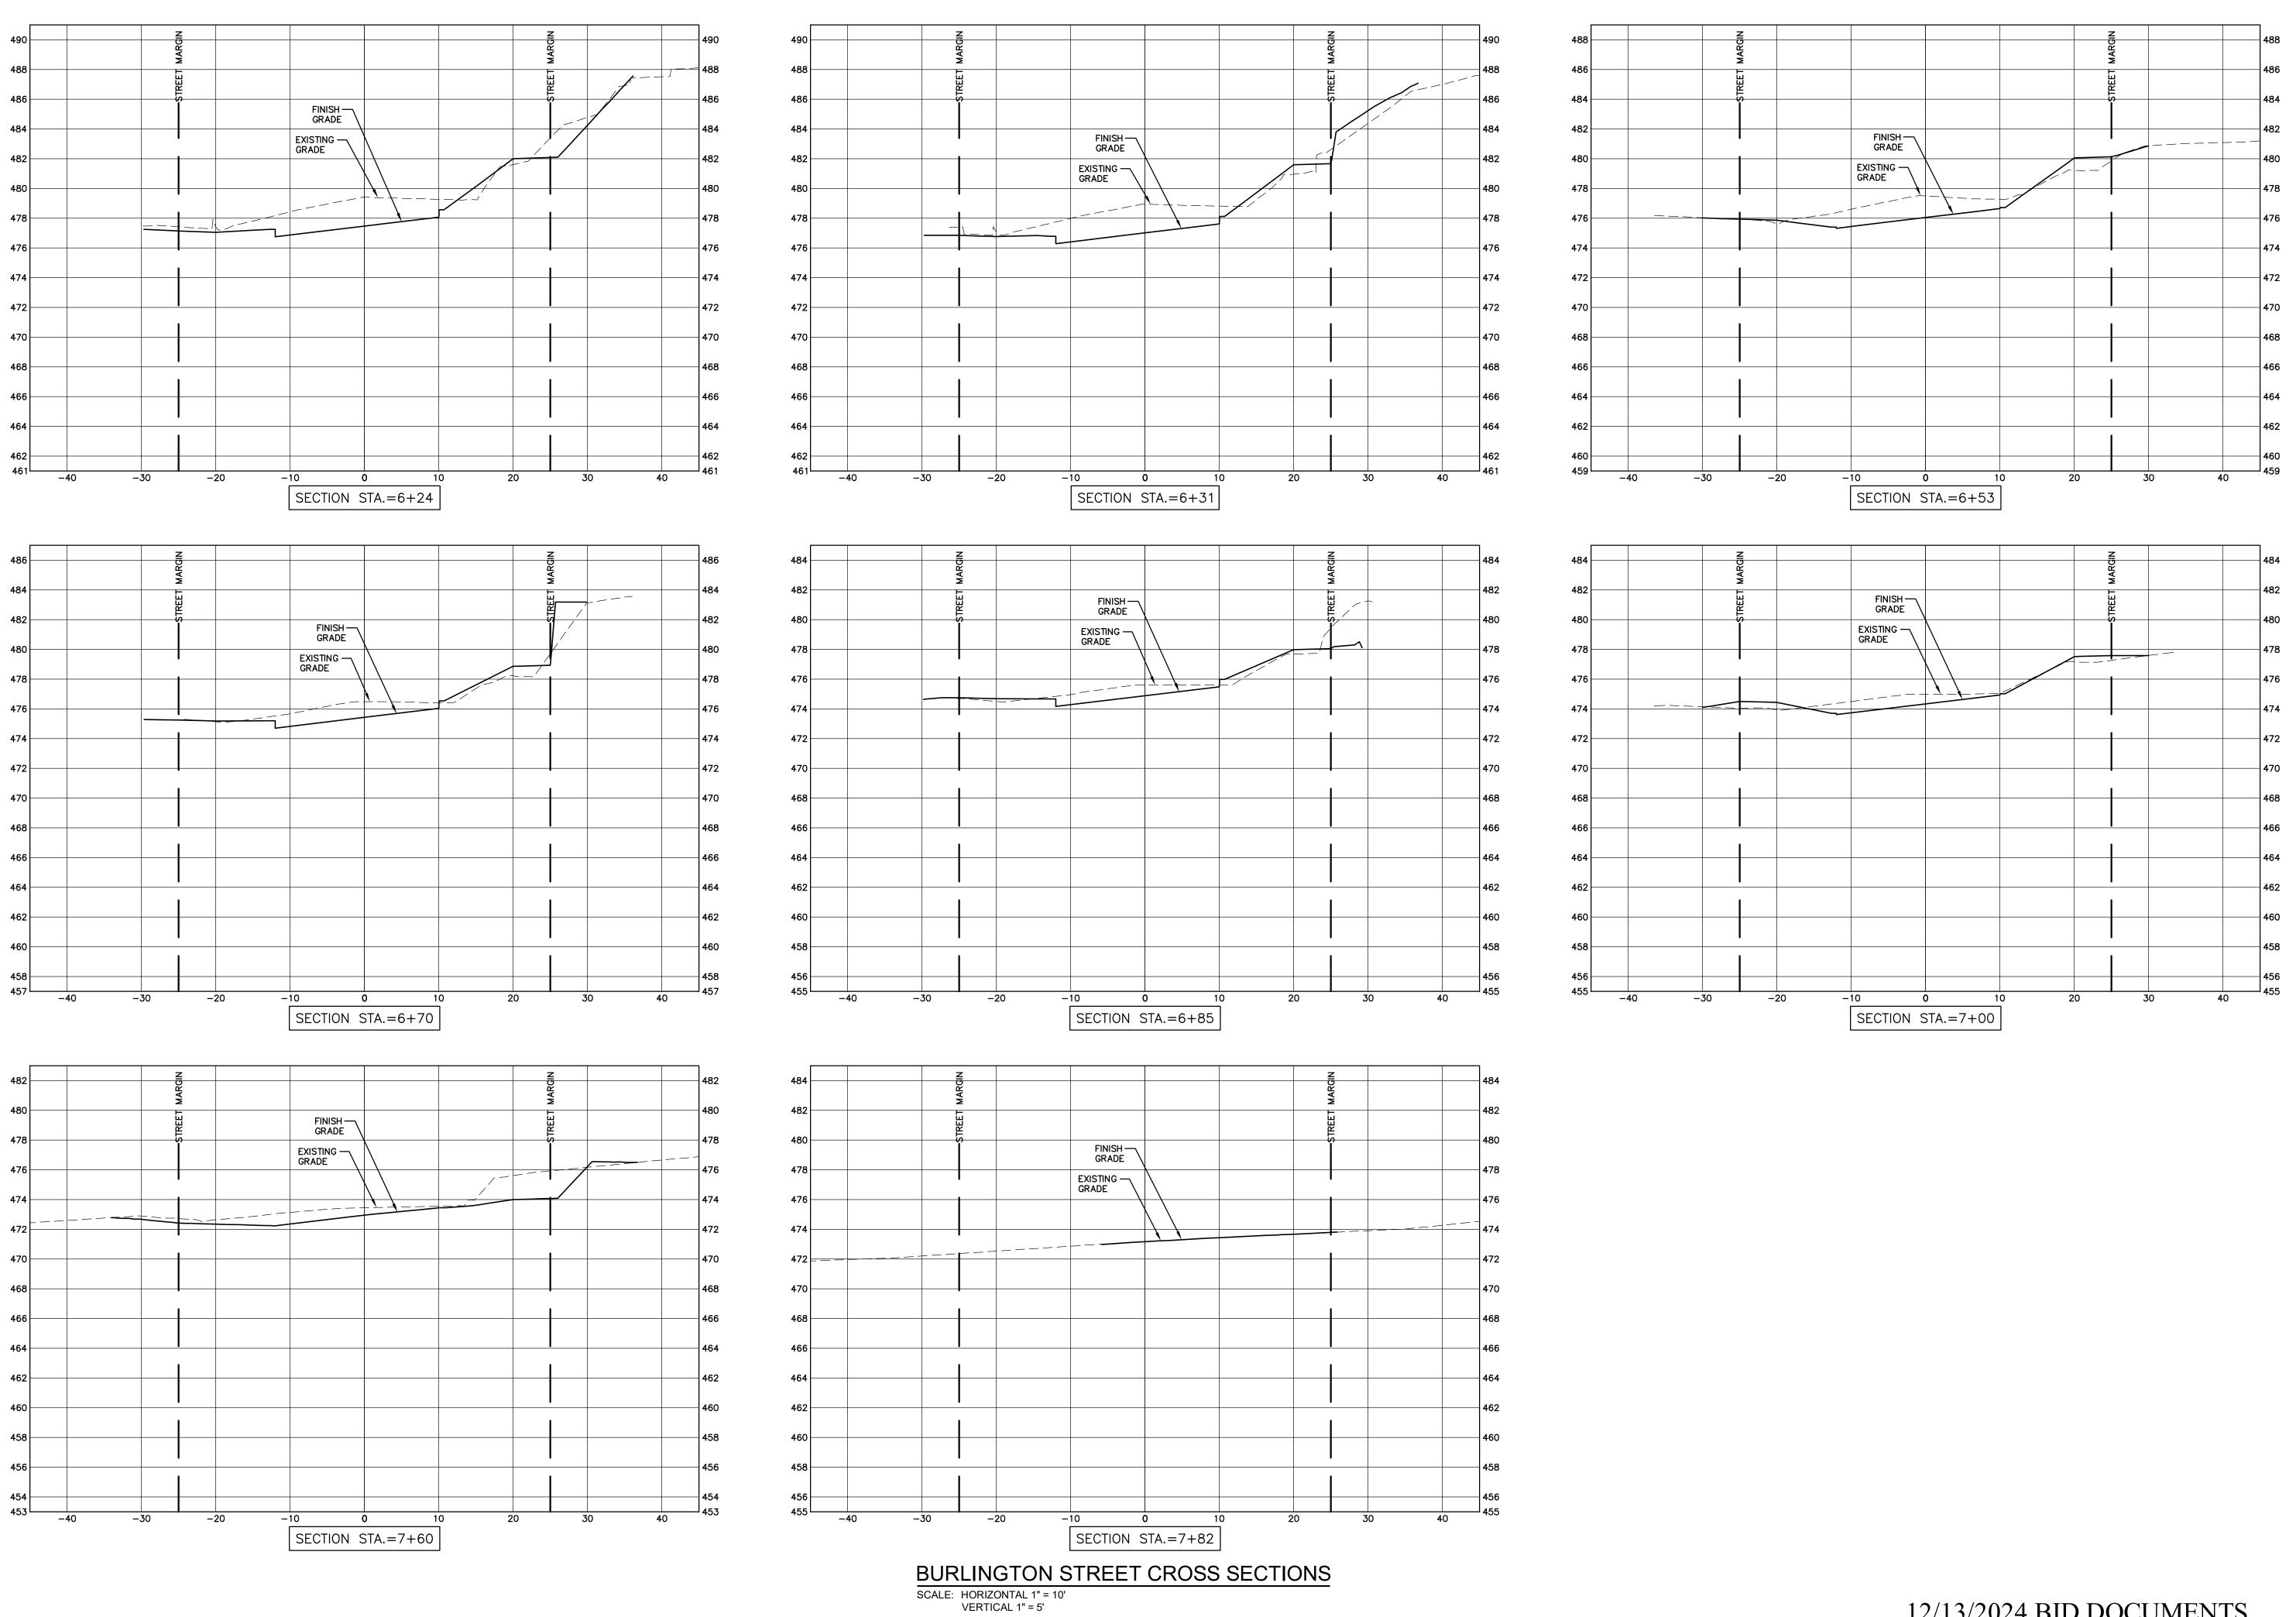
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RECONSTRUCTION PROJE(
CITY OF WATERTOWN
ENGINEERING DEPARTMENT
JEFFERSON COUNTY, STATE OF NEW YO

YORK

PROJECT NO: 2023-052 DRAWN BY: TFT

CHECKED BY: MRM ISSUE DATES: 02/23/2024 04/30/2024 12/13/2024

> BURLINGTON STREET **CROSS SECTIONS**



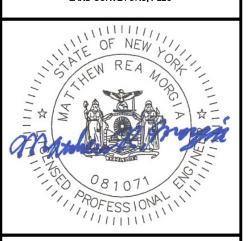
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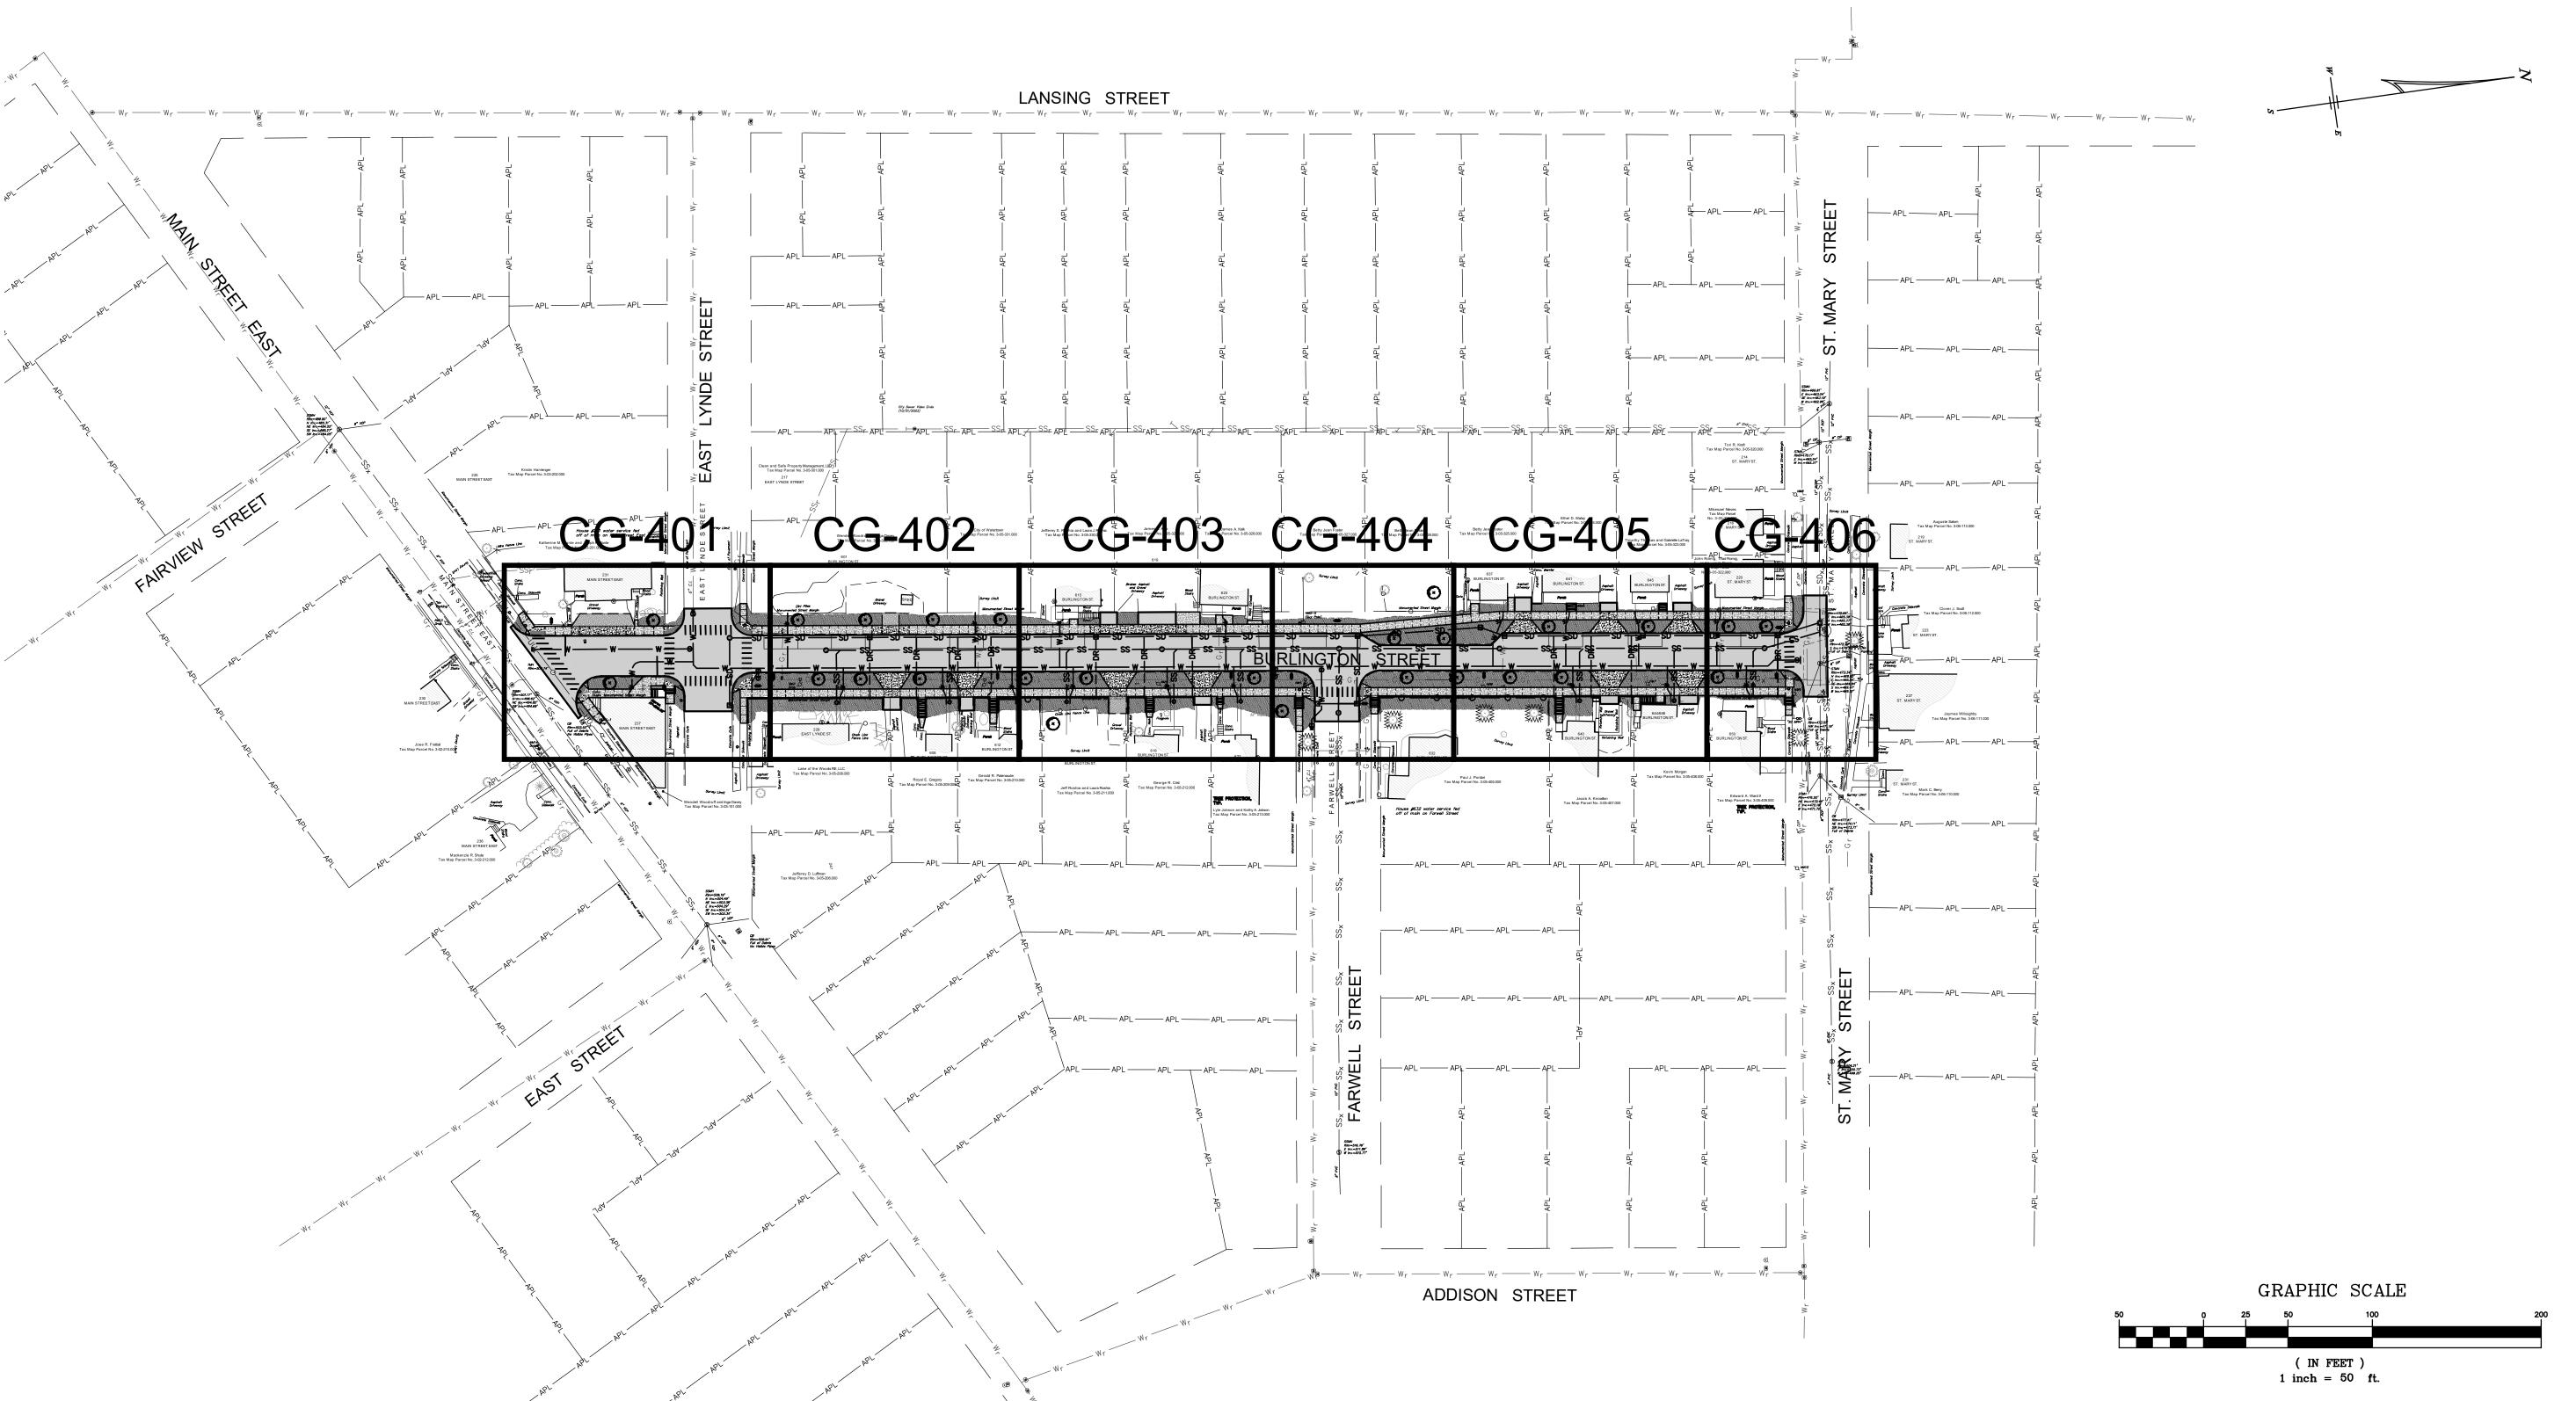


YORK

BURLINGTON STREET
RECONSTRUCTION PROJE(
CITY OF WATERTOWN
ENGINEERING DEPARTMENT
JEFFERSON COUNTY, STATE OF NEW YO

ISSUE DATES: 02/23/2024 04/30/2024 12/13/2024

BURLINGTON STREET CROSS SECTIONS



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and

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BURLINGTON STREET
RECONSTRUCTION PROJECT
CITY OF WATERTOWN
ENGINEERING DEPARTMENT
JEFFERSON COUNTY, STATE OF NEW YORK

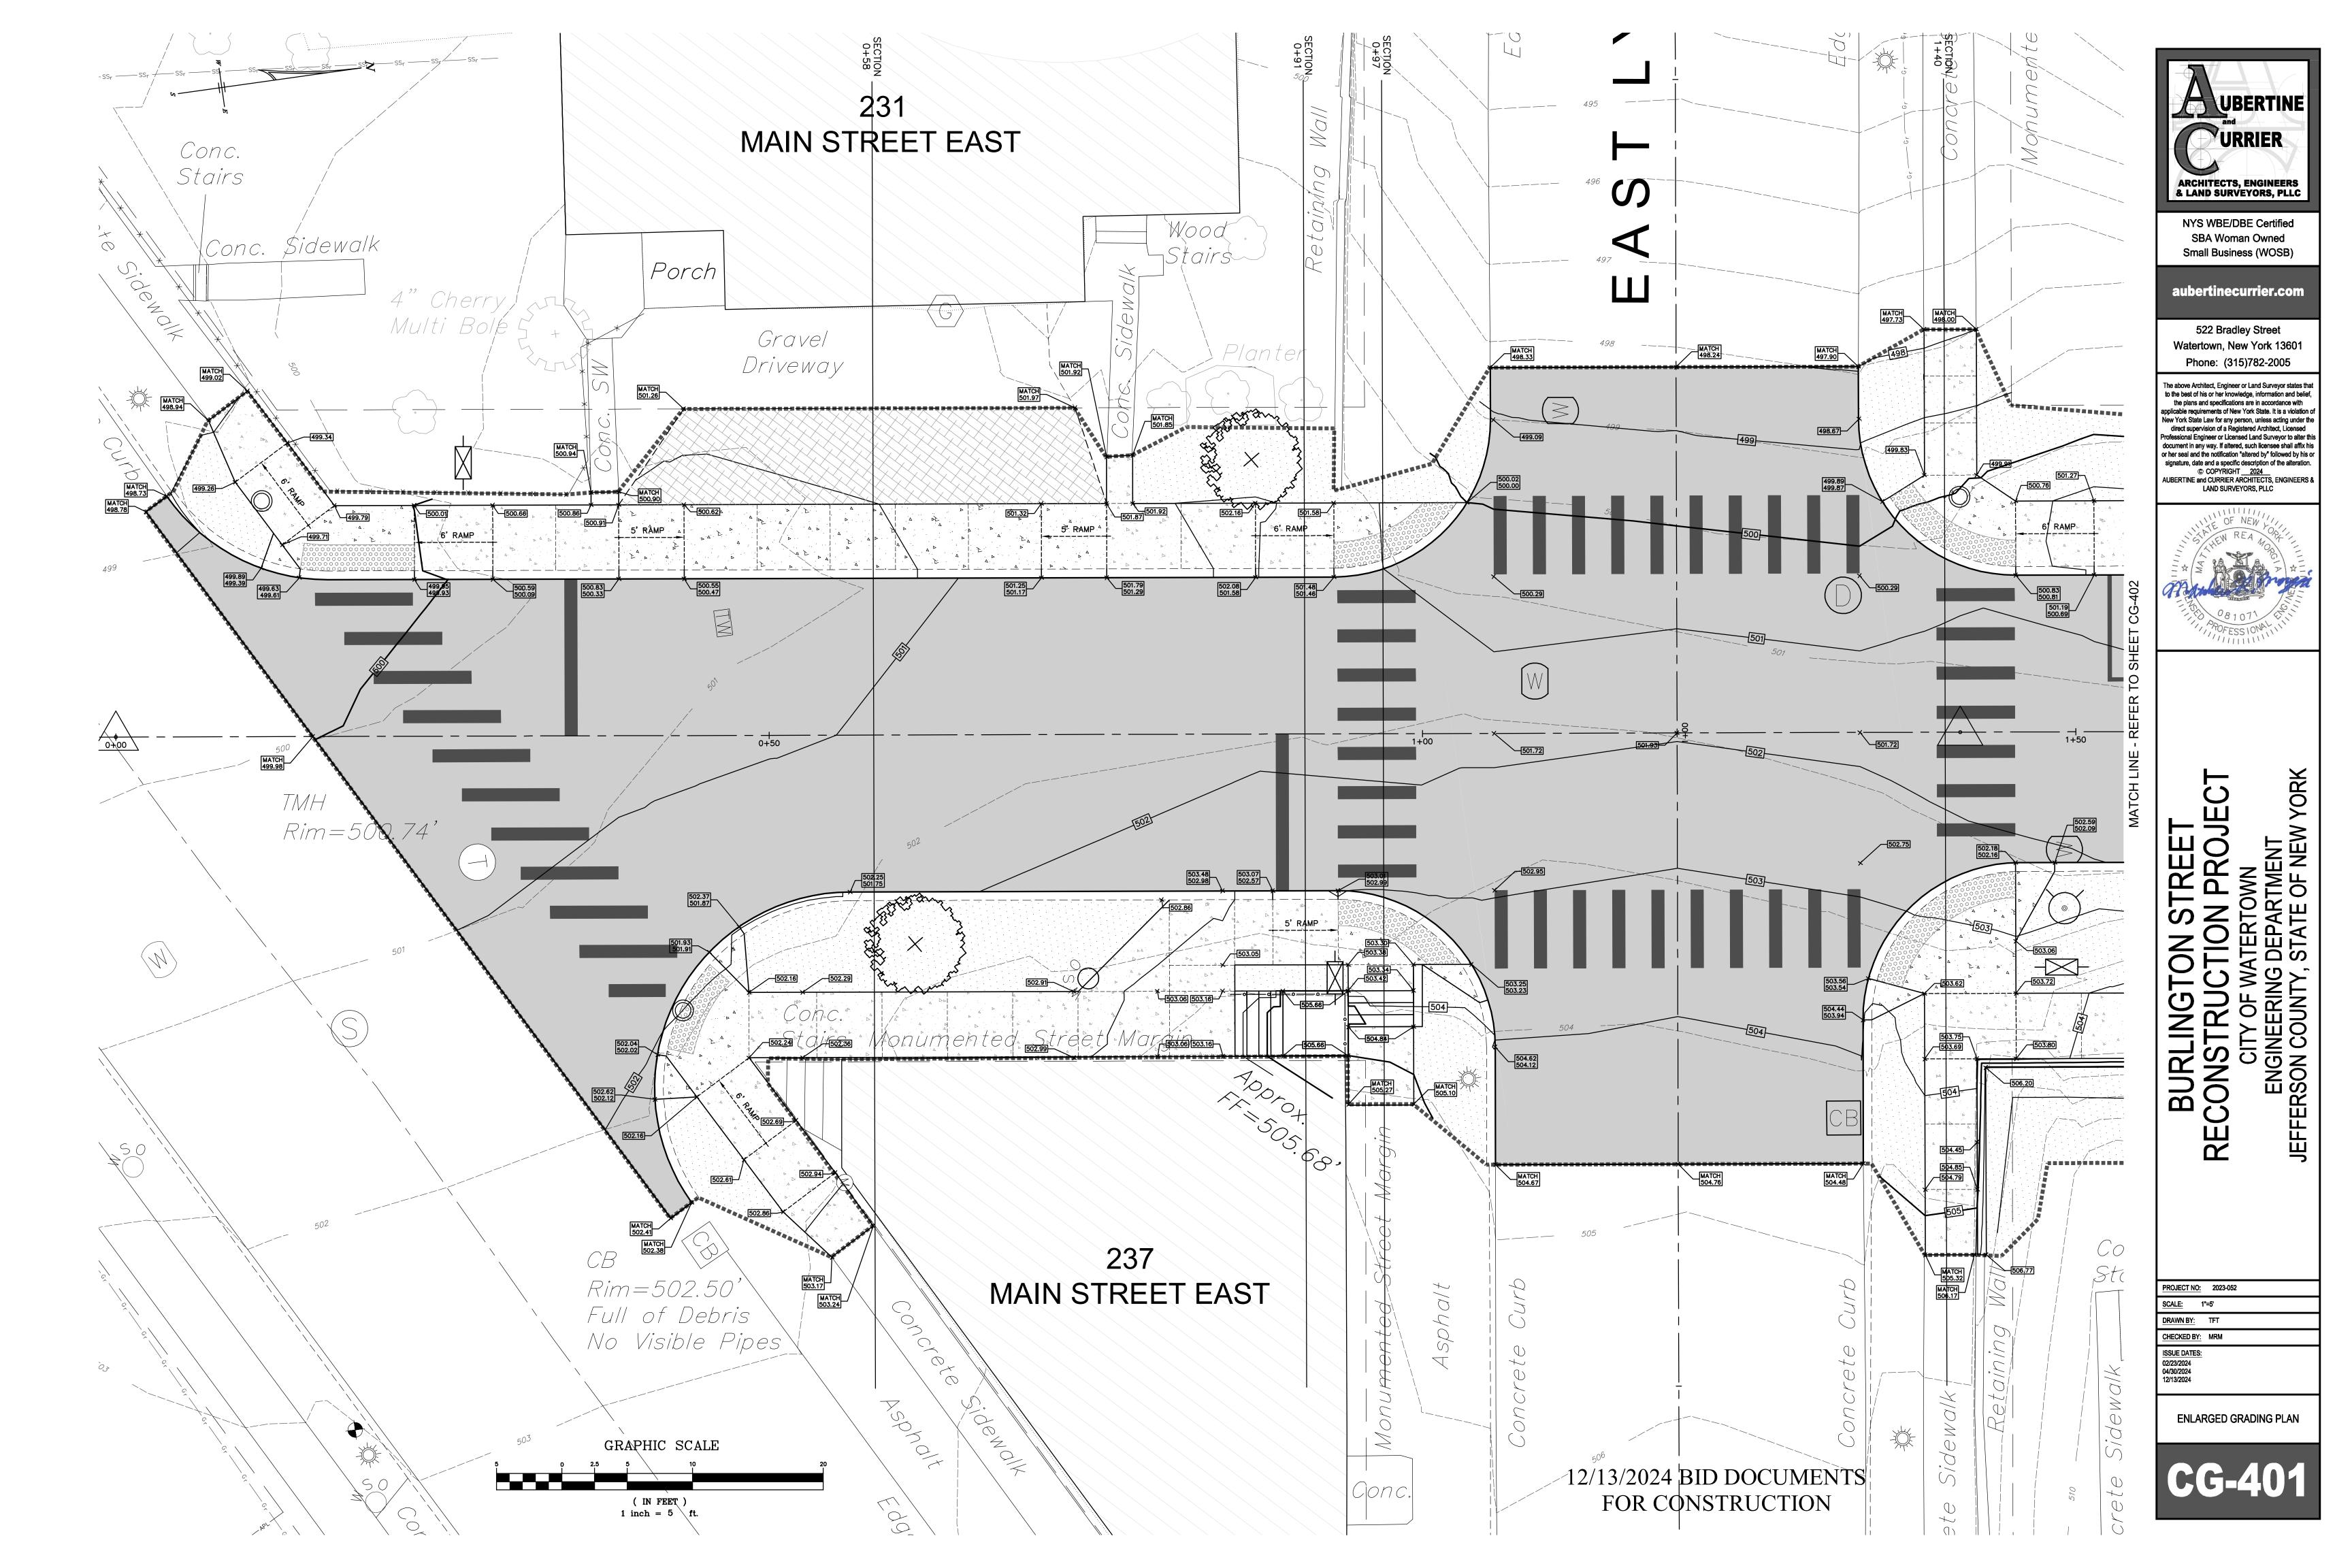
<u>DJECT NO:</u> 2023-052 ALE: 1"=50'

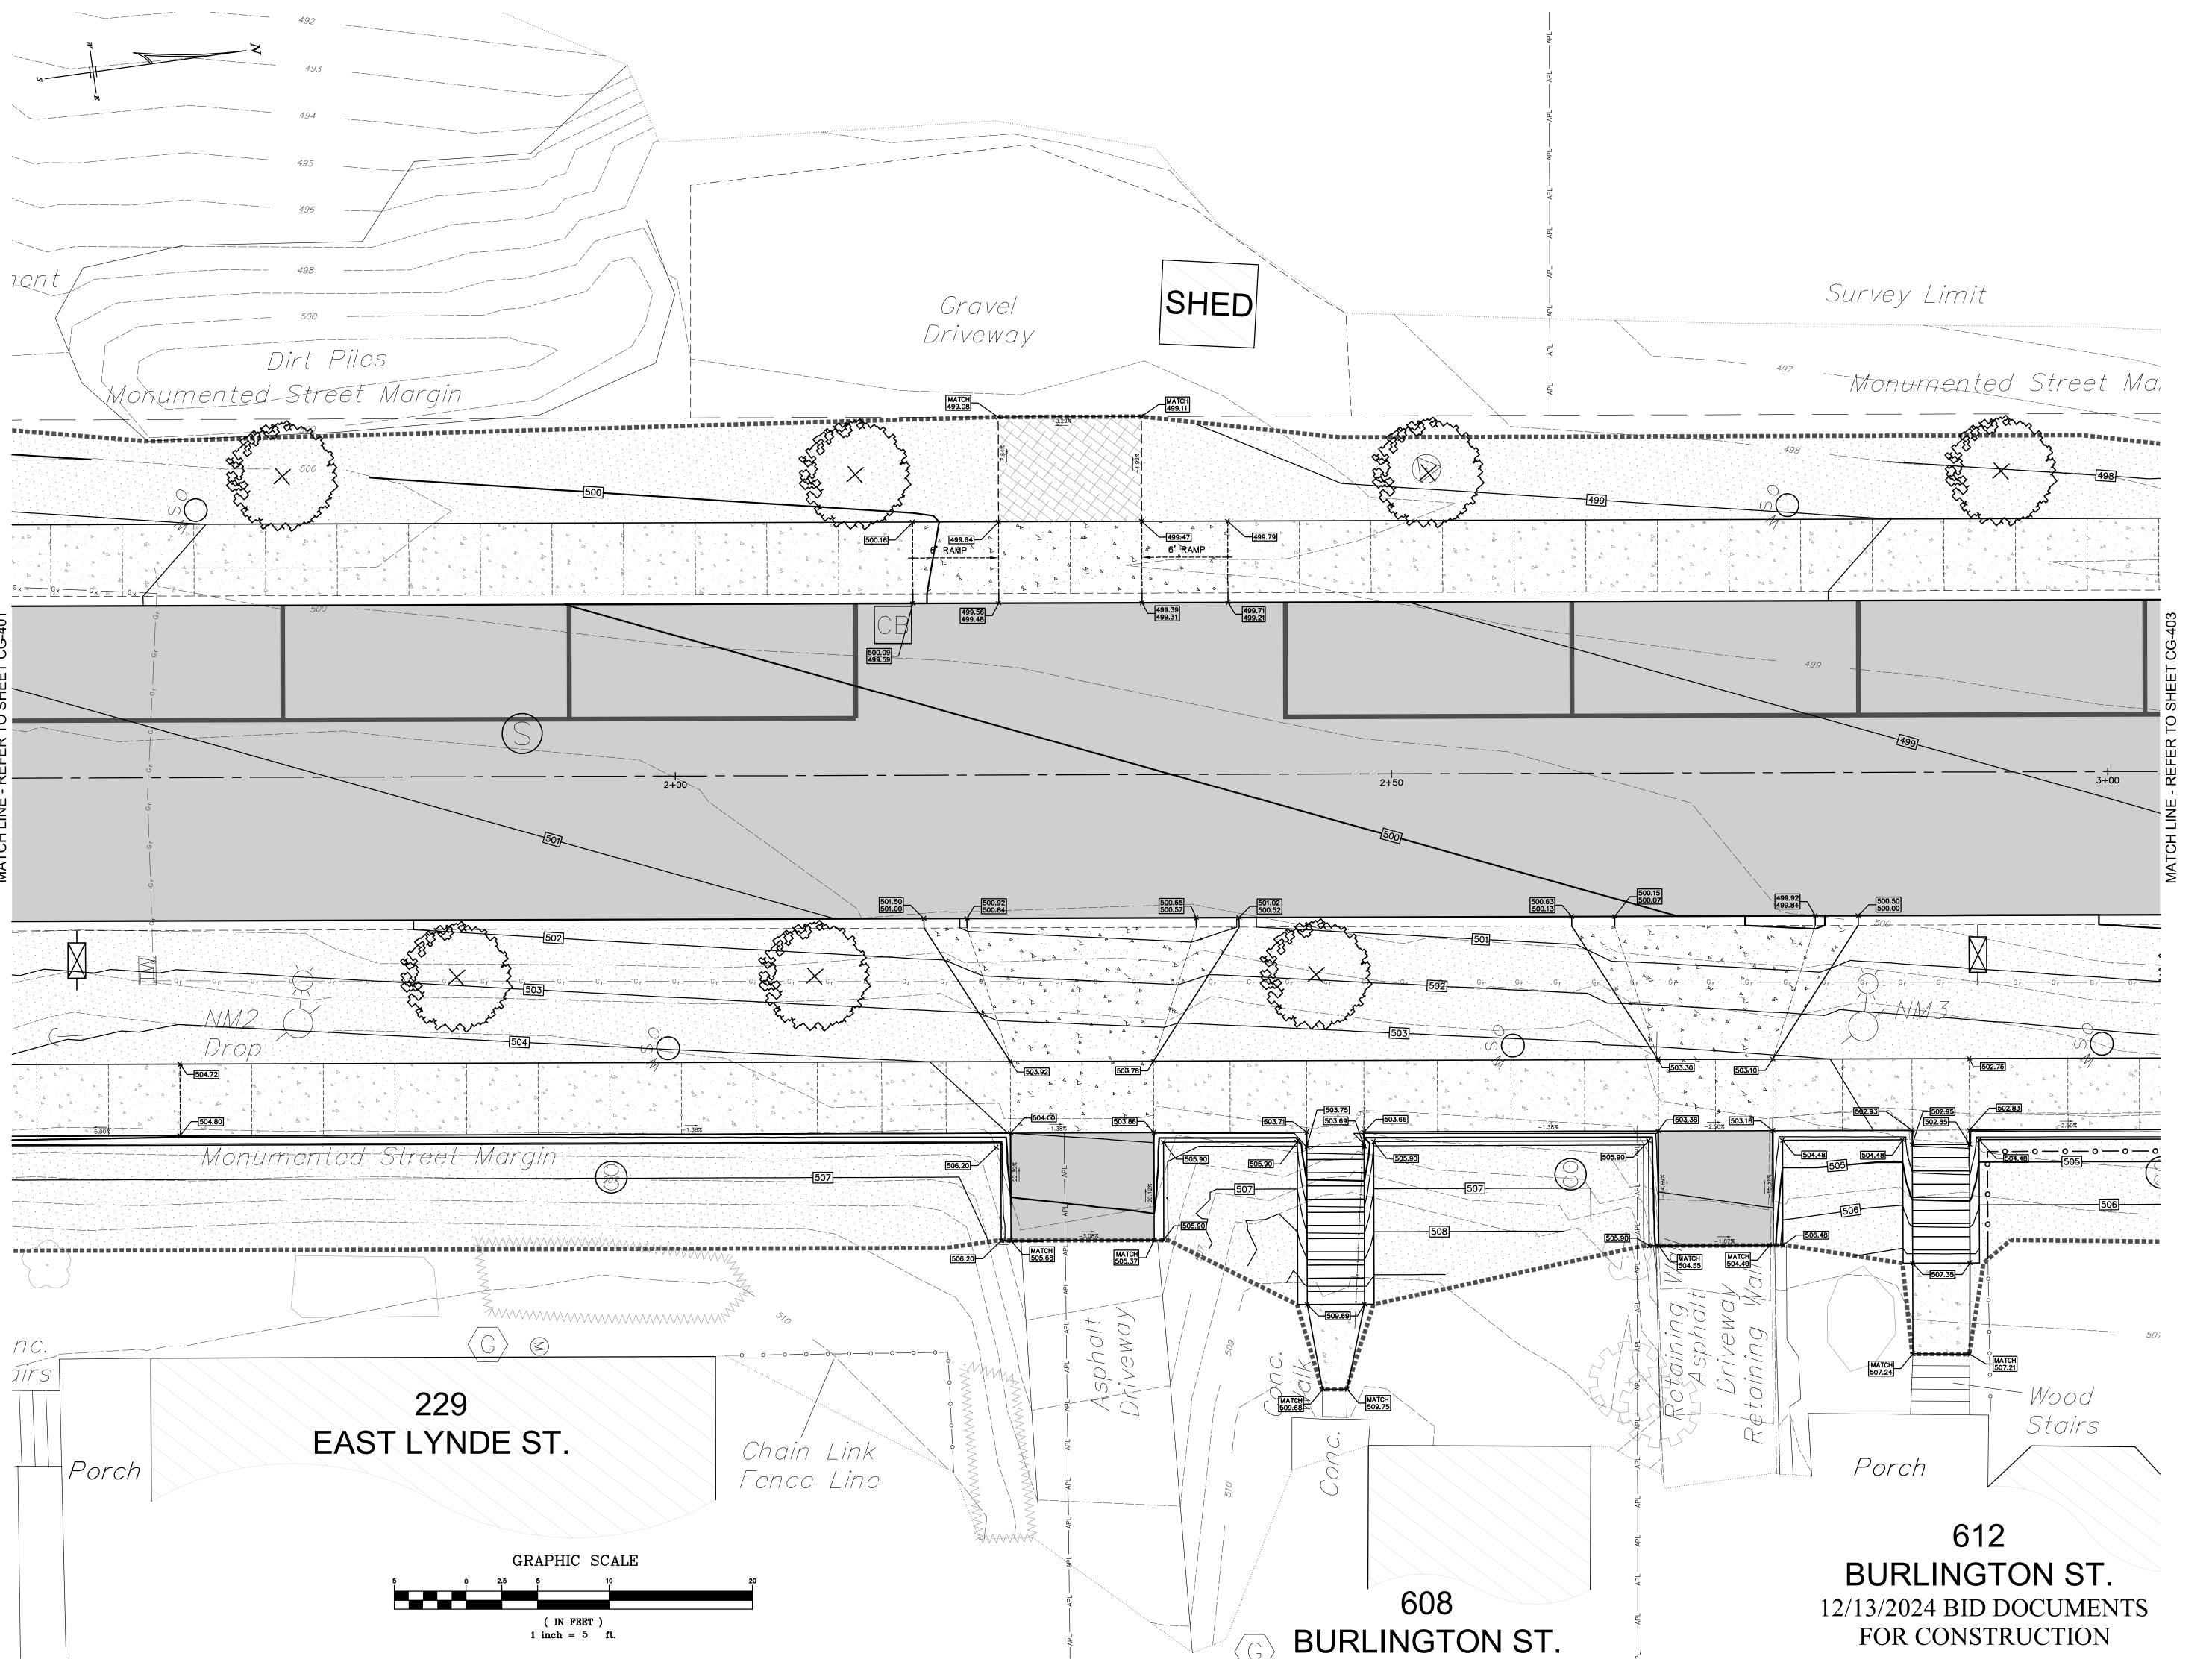
DRAWN BY: TFT

CHECKED BY: MRM

ISSUE DATES: 02/23/2024 04/30/2024 12/13/2024

OVERALL ENLARGED GRADING PLAN KEY MAP








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ENGINEERING DEPARTMENT

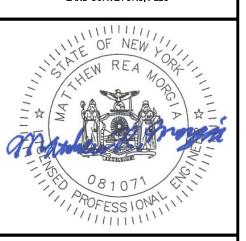OJECT NO: 2023-052

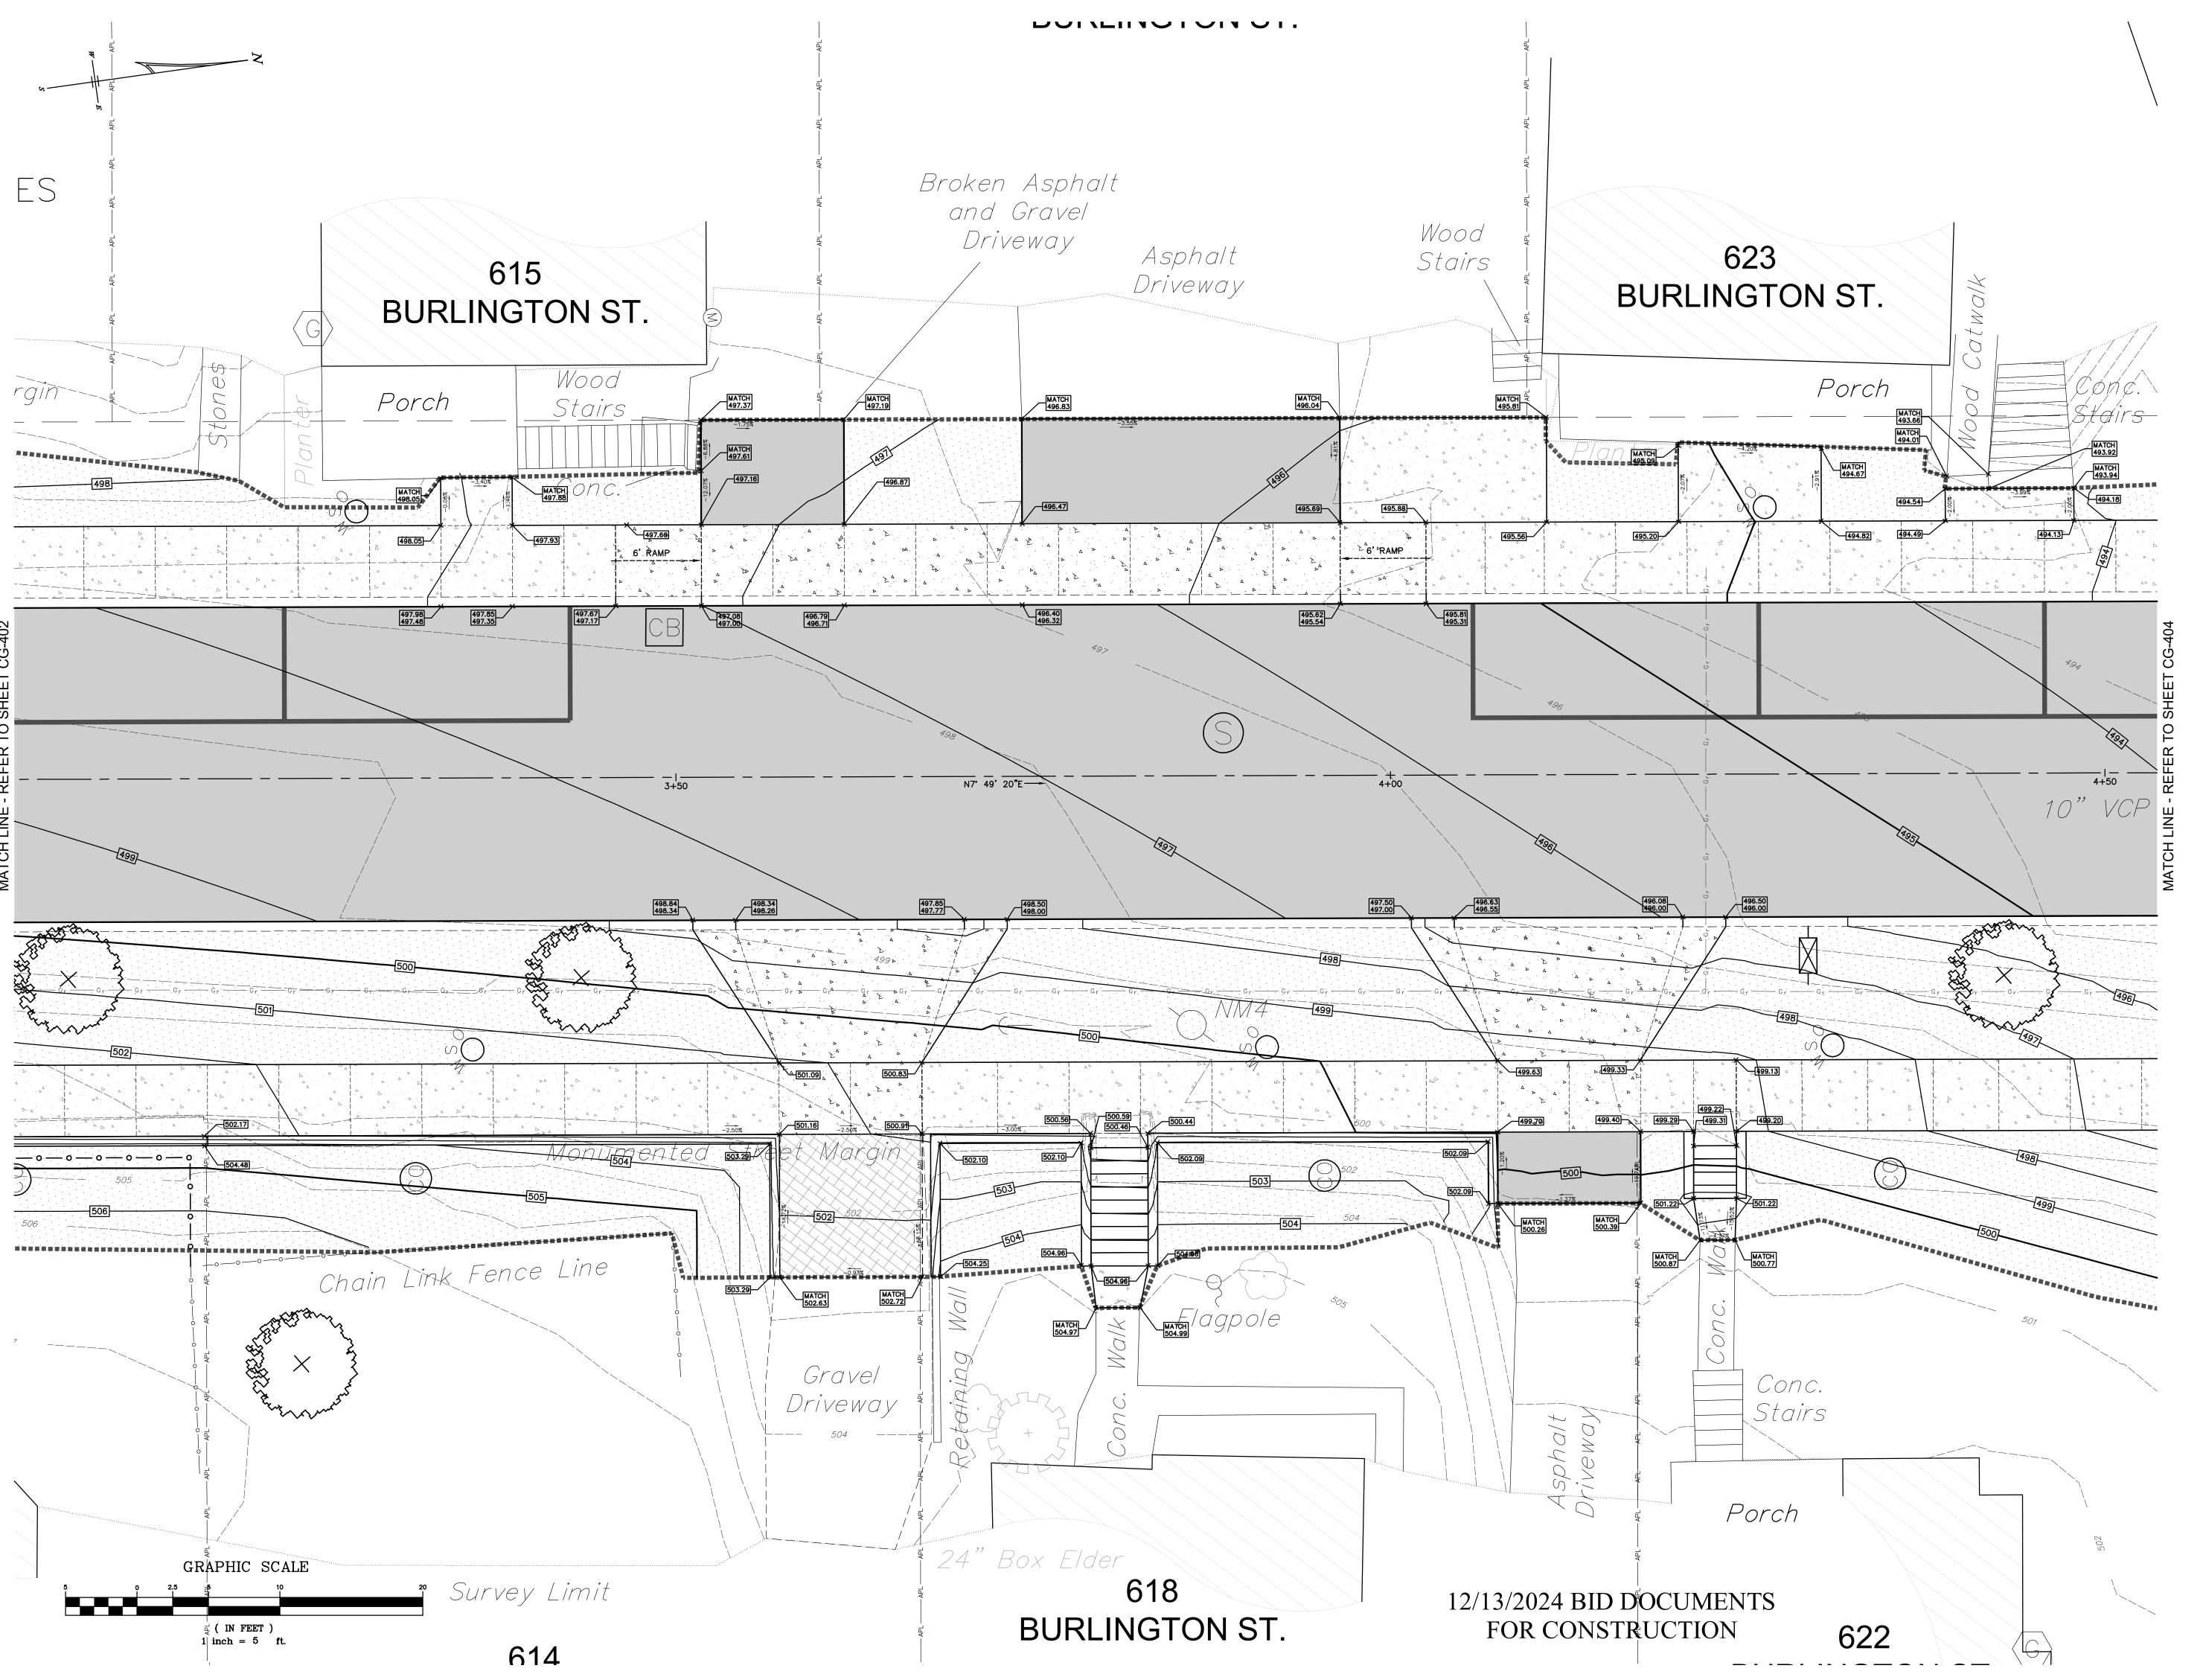
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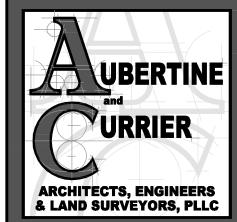
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ECKED BY: MRM

SSUE DATES: )2/23/2024 )4/30/2024 )2/13/2024

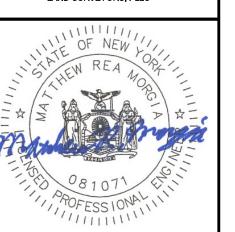
ENLARGED GRADING PLAN





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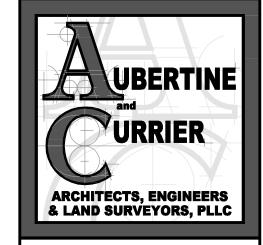
BURLINGTON STREET
RECONSTRUCTION PROJECT
CITY OF WATERTOWN
ENGINEERING DEPARTMENT
JEFFERSON COUNTY, STATE OF NEW YORK

<u>O:</u> 2023-052 1"=20'

ECKED BY: MRM

UE DATES: 23/2024 80/2024 83/2024

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JEFFERSON COUNTY, STATE OF NEW YORK

PROJECT NO: 2023-052

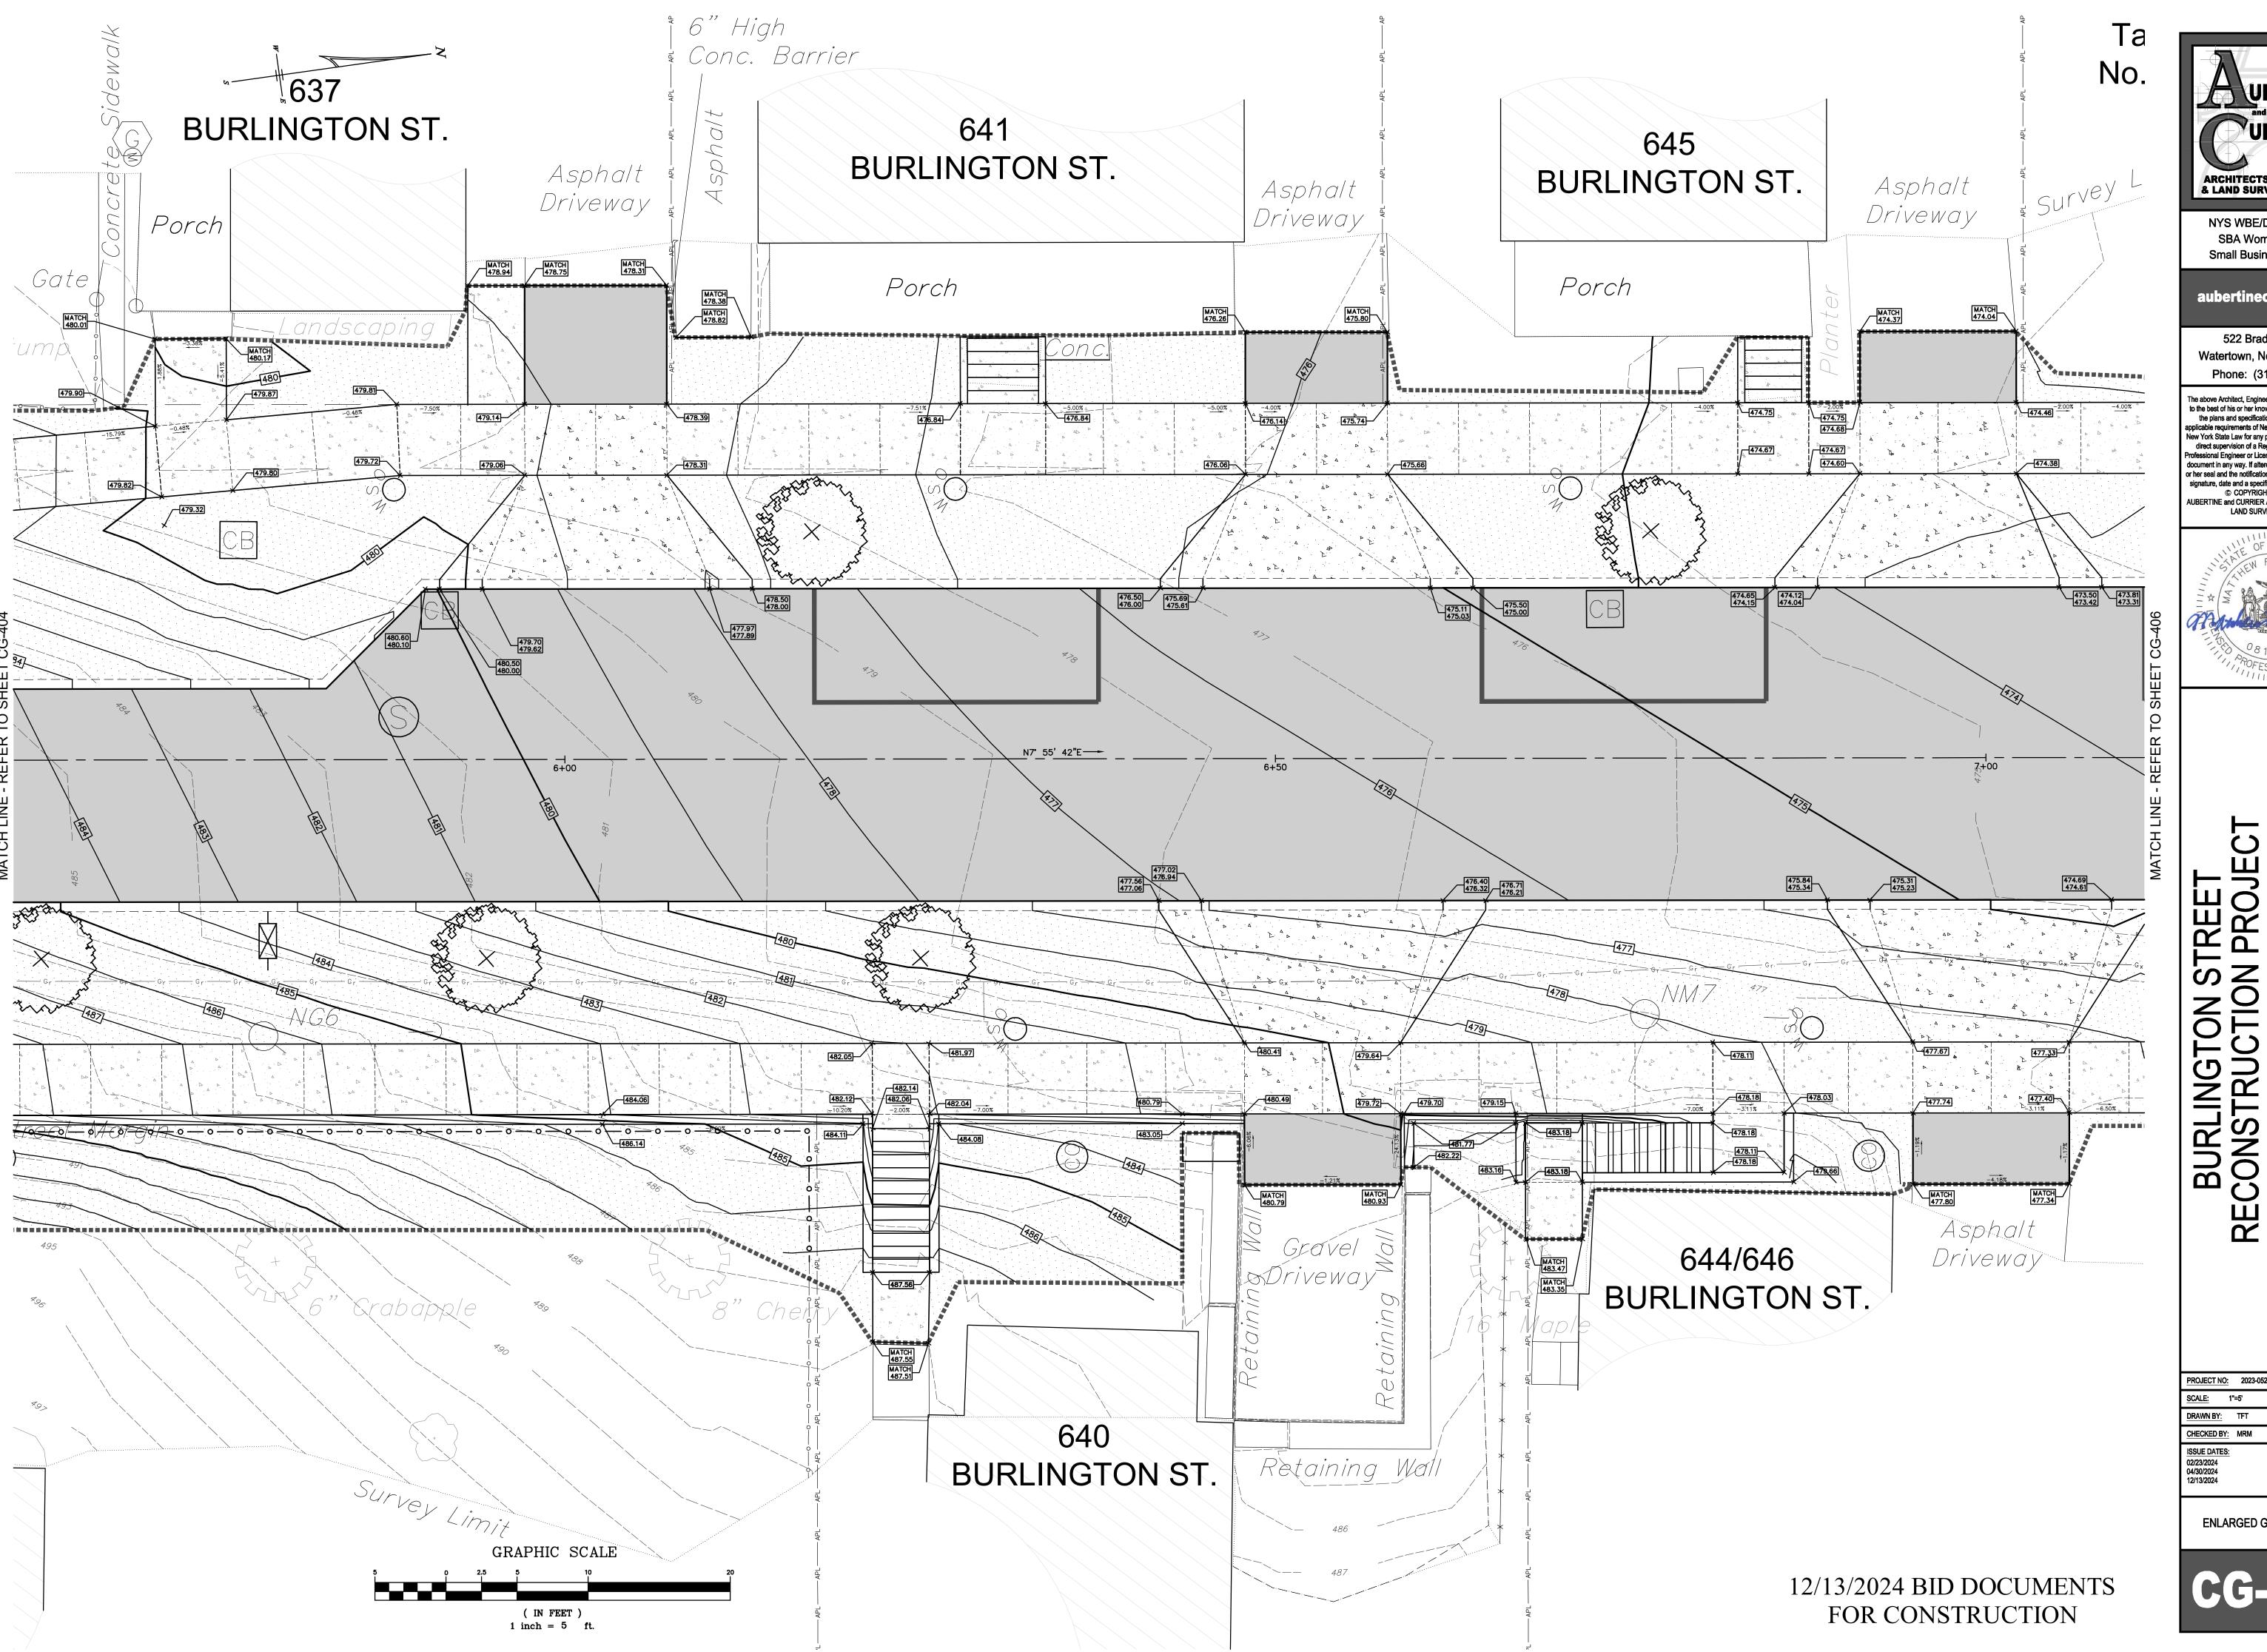
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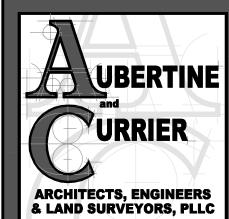
SCALE: 1"=5"
DRAWN BY: TFT

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ISSUE DATES:
02/23/2024
04/30/2024
12/13/2024

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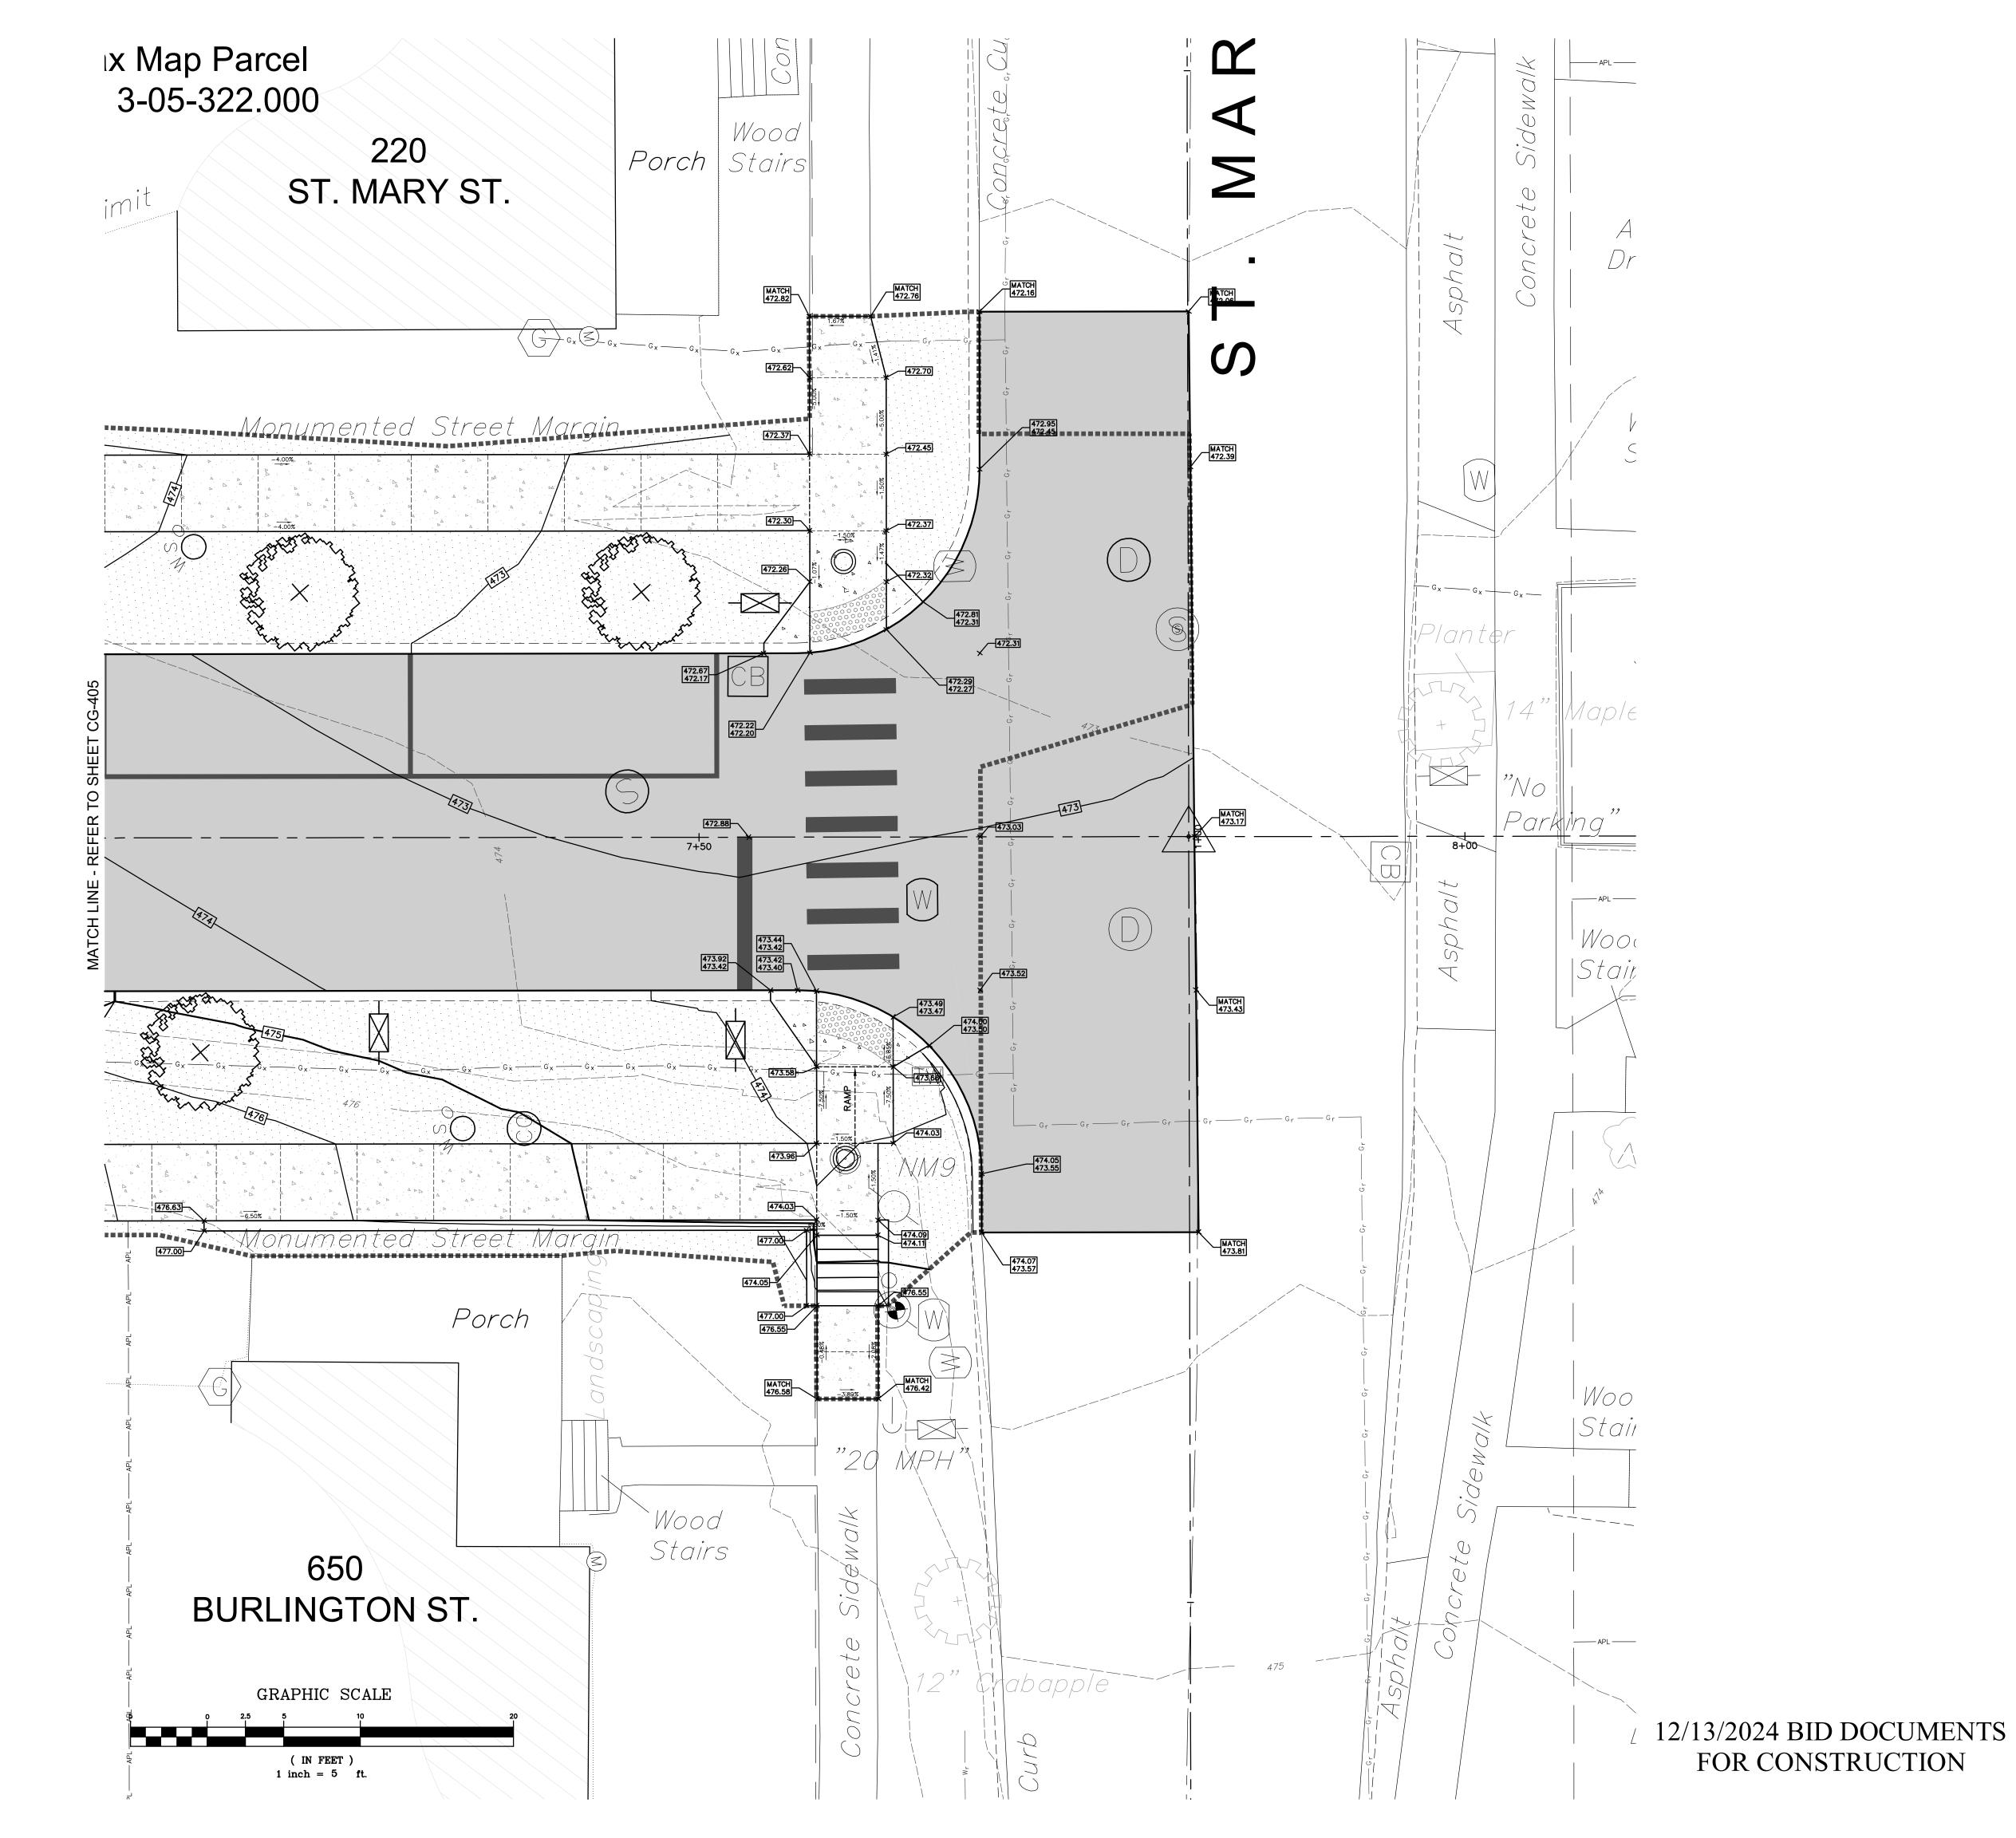
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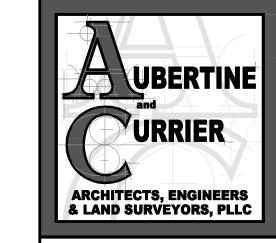


CITY OF W ENGINEERING JEFFERSON COUNTY

YORK

ENLARGED GRADING PLAN





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RECONSTRUCTION PROJECT
CITY OF WATERTOWN
ENGINEERING DEPARTMENT
JEFFERSON COUNTY, STATE OF NEW YORK

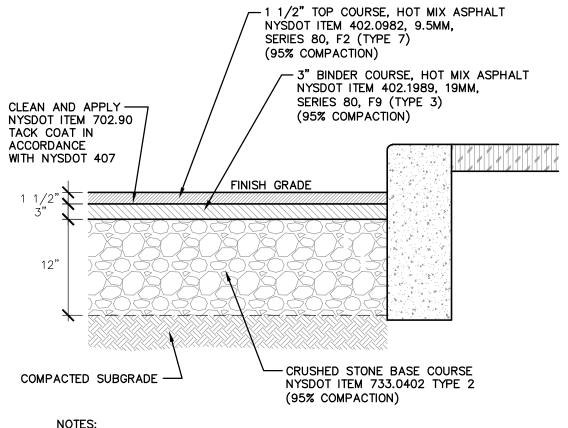
PROJECT NO: 2023-052

SCALE: 1"=5'

DRAWN BY: TFT

ISSUE DATES: 02/23/2024 04/30/2024 12/13/2024


ENLARGED GRADING PLAN



- 1. ALL HMA COMPACTION WILL BE TO 95% MADMTD (MIXTURE'S AVERAGE DAILY MAXIMUM THEORETICAL DENSITY) PER NYS DOT SPECIFICATIONS FOR HMA COMPACTION 402-3.07


  2. BASE COURSE SHALL BE COMPACTED TO 95% MODIFIED PROCTOR
- 3. FIELD VERIFICATION OF COMPACTION SHALL BE BY NUCLEAR DENSITY TESTING METHODS

#### TYPICAL ASPHALT STREET PAVEMENT DETAIL

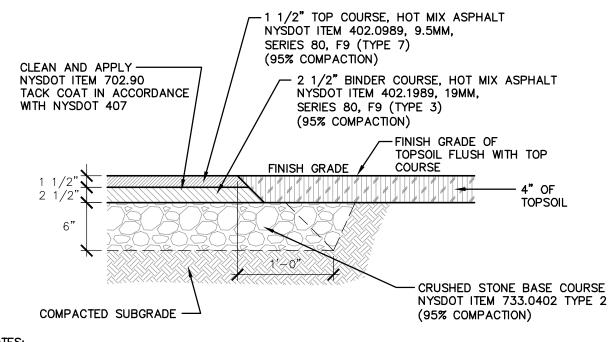


- 1. ALL HMA COMPACTION WILL BE TO 95% MADMTD (MIXTURE'S AVERAGE DAILY MAXIMUM THEORETICAL DENSITY) PER NYS DOT SPECIFICATIONS FOR HMA COMPACTION 402-3.07 BASE COURSE SHALL BE COMPACTED TO 95% MODIFIED PROCTOR
- MAXIMUM DENSITY. FIELD VERIFICATION OF COMPACTION SHALL BE BY NUCLEAR DENSITY TESTING METHODS


#### TYPICAL ASPHALT DRIVEWAY PAVEMENT DETAIL

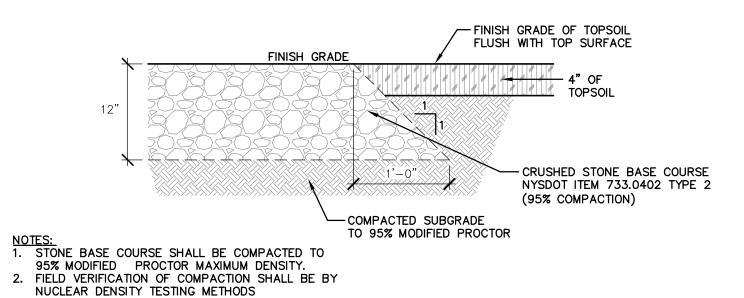

### 3 TYPICAL CRUSHED STONE SURFACE DRIVEWAY DETAIL NOT TO SCALE

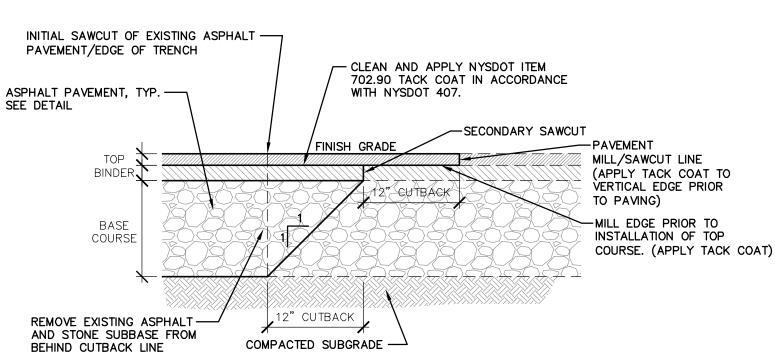

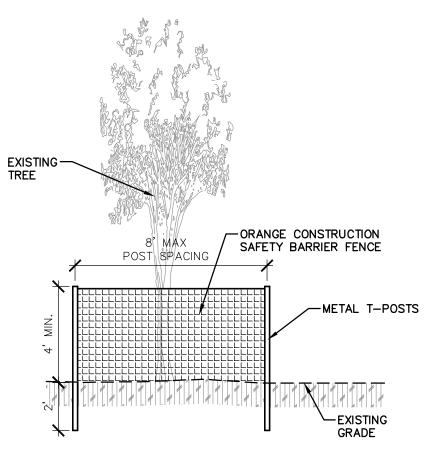TYPICAL ASPHALT PAVEMENT JOINT DETAIL (CONNECTION AT EXISTING PAVEMENT)




- 1. TREE PROTECTION FENCING SHALL BE INSTALLED PRIOR TO THE START OF ANY CONSTRUCTION.


  2. FOR NEWLY PLANTED TREES AND TREES WITH A CROWN SPREAD OF EIGHT (8) FEET OR LESS, A MINIMUM OF 8'x8' SQUARE TREE PROTECTION FENCE SHALL BE INSTALLED.
- 3. FOR TREES WITH A CROWN SPREAD OF OVER EIGHT (8) FEET, THE TREE PROTECTION FENCE SHALL EXTEND TO THE TREES DRIPLINE OR AT A DISTANCE PRESCRIBED BY THE CITY ARBORIST.

  4. THERE SHALL BE NO STORAGE OF MATERIAL WITHIN BOUNDARIES OF
- TREE PROTECTION FENCING.
- 5. TREE PROTECTION FENCING SHALL BE MAINTAINED THROUGHOUT THE DURATION OF CONSTRUCTION.


#### TYPICAL TREE PROTECTION DETAIL

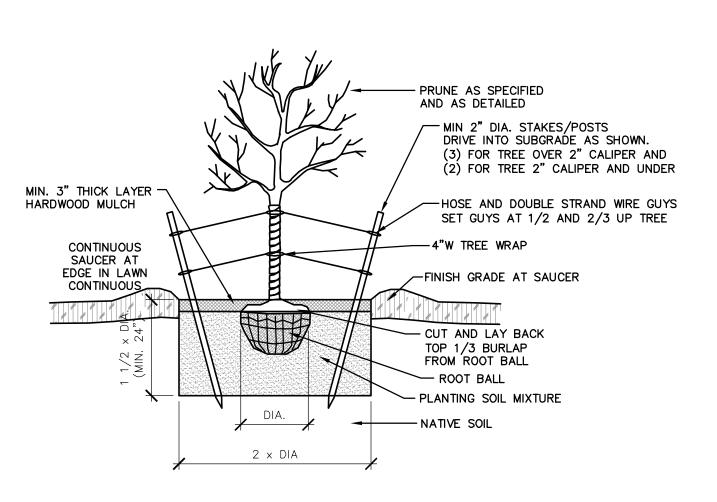

TYPICAL TREE PLANTING DETAIL

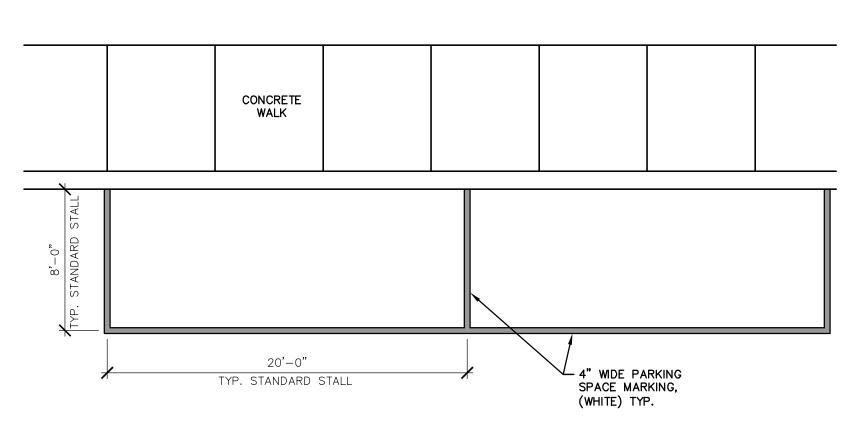


#### TYPICAL PARKING STALL MARKINGS DETAIL

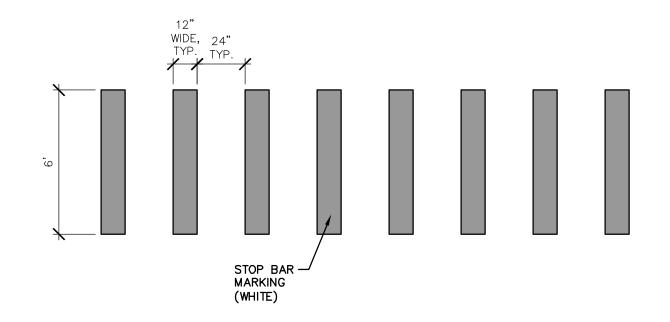


NOTE:
ALL PAVEMENT MARKINGS SHALL BE PLACED IN ACCORDANCE WITH THE NATIONAL MANUAL FOR UNIFORM TRAFFIC CONTROL DEVISES AND NYS DOT STANDARDS

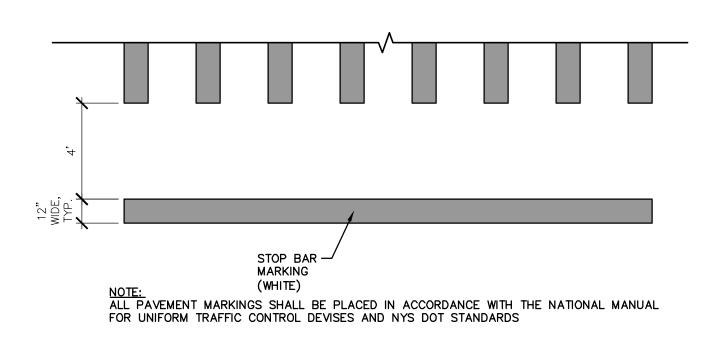TYPICAL CROSS WALK DETAIL NOT TO SCALE



TYPICAL STOP BAR DETAIL

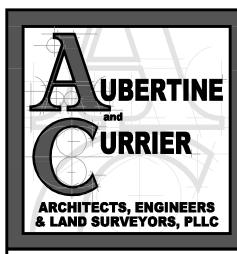

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YORK ON STREET TION PROJE RECONSTRUCT
CITY OF WA
ENGINEERING BURLING

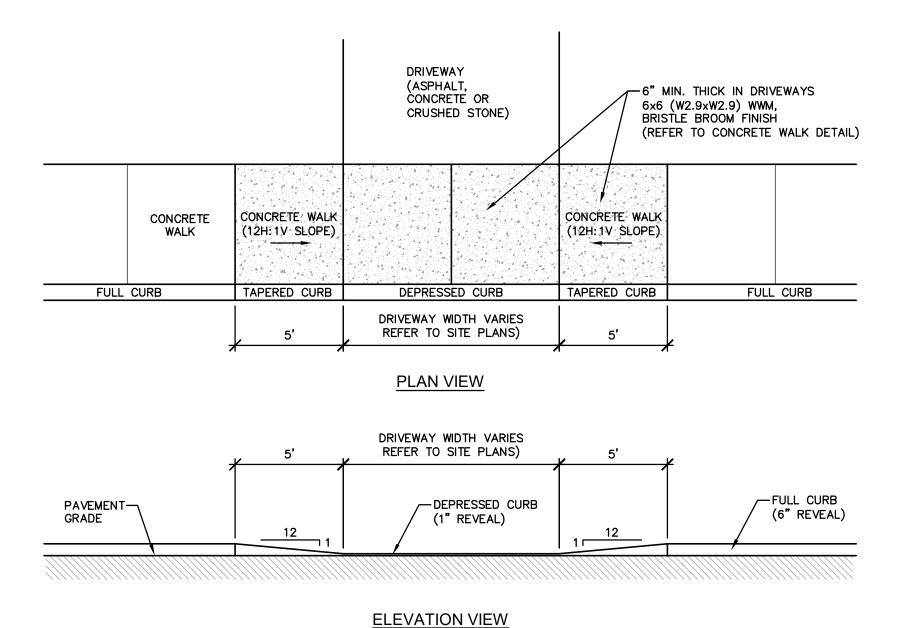
PROJECT NO: 2023-052

DRAWN BY: TFT


CHECKED BY: MRM

ISSUE DATES: 02/23/2024 04/30/2024 12/13/2024


SITE DETAILS




1 TYPICAL DRIVEWAY APRON DETAIL

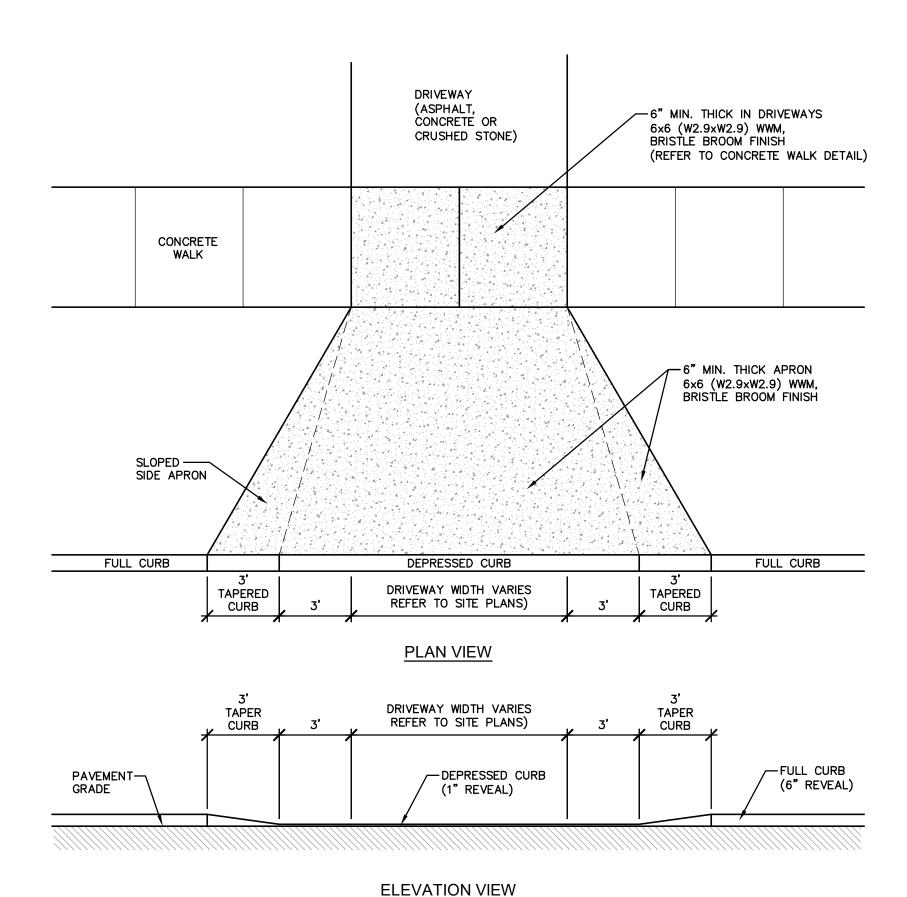

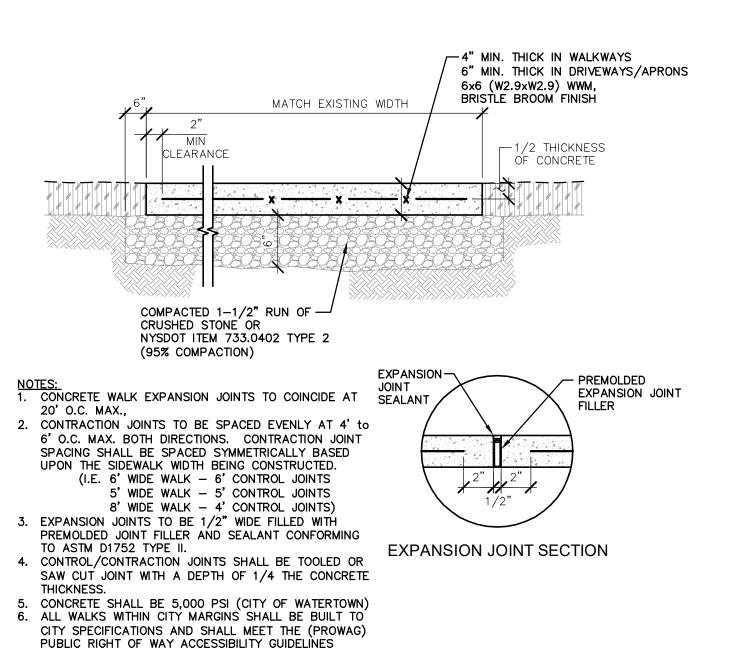
2 TYPICAL DRIVEWAY APRON DETAIL (WITH GRASS MEDIAN)




#### 3 TYPICAL CONCRETE WALK DETAIL

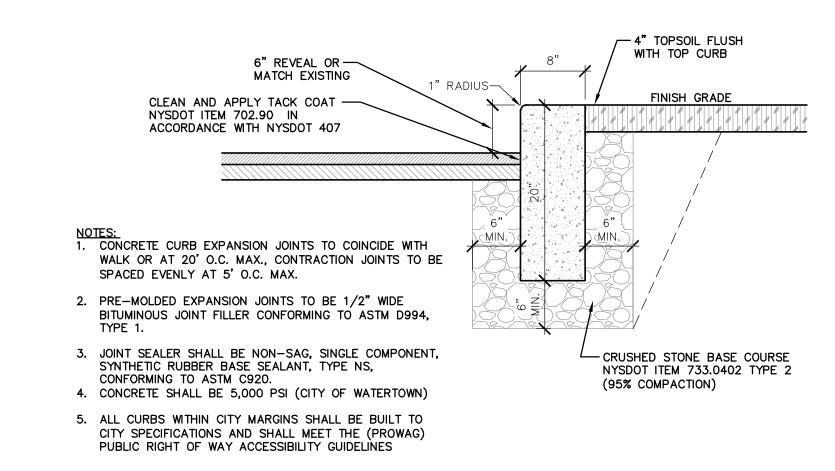


### 4 TYPICAL FULL CONCRETE CURB DETAIL NOT TO SCALE

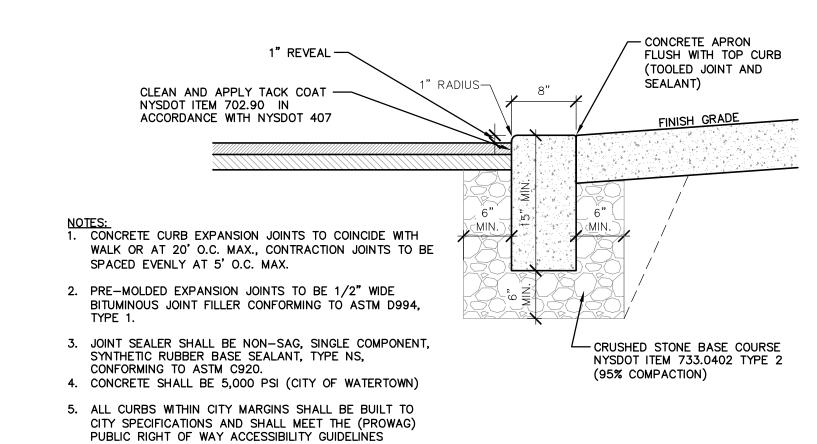

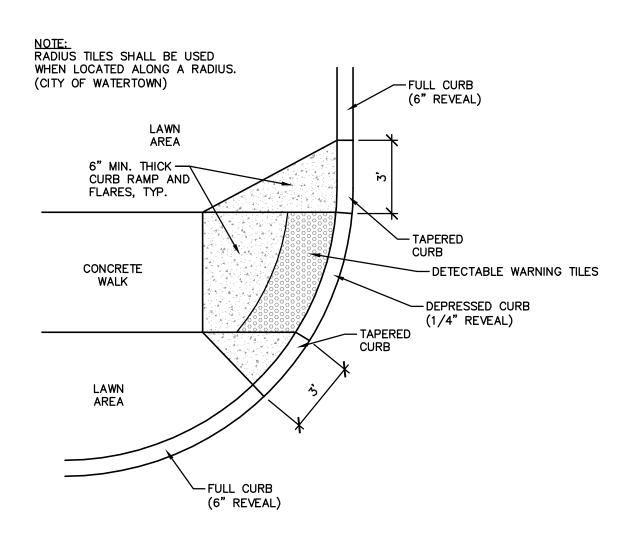
5 TYPICAL DEPRESSED CONCRETE CURB DETAIL
NOT TO SCALE



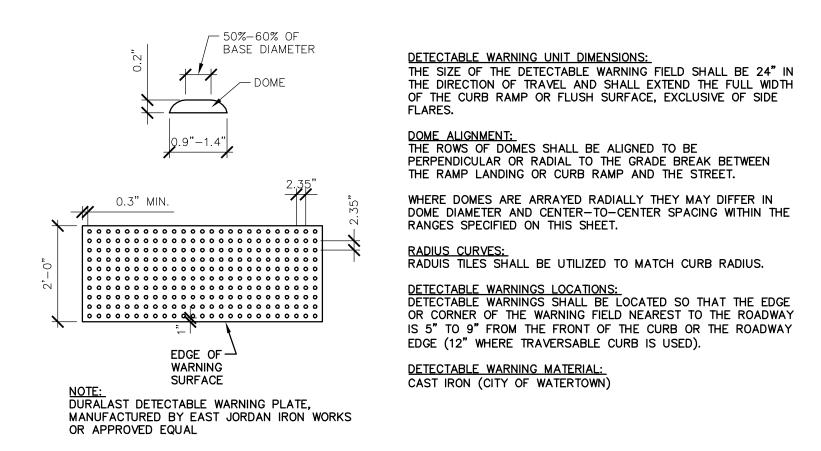6 TYPICAL SIDEWALK WITH DETECTABLE WARNING TILE DETAIL
NOT TO SCALE



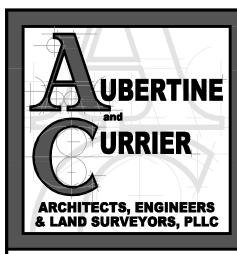7 TYPICAL DETECTABLE WARNING SURFACE DETAIL NOT TO SCALE




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RECONSTRUCTION PROJECT
CITY OF WATERTOWN
ENGINEERING DEPARTMENT
JEFFERSON COUNTY, STATE OF NEW YORK

 PROJECT NO:
 2023-052

 SCALE:
 AS NOTED

DRAWN BY: TFT

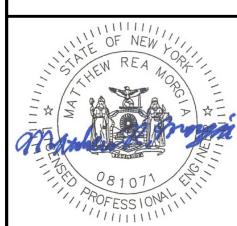CHECKED BY: MRM


ISSUE DATES:


02/23/2024 04/30/2024 12/13/2024


SITE DETAILS

CS-501

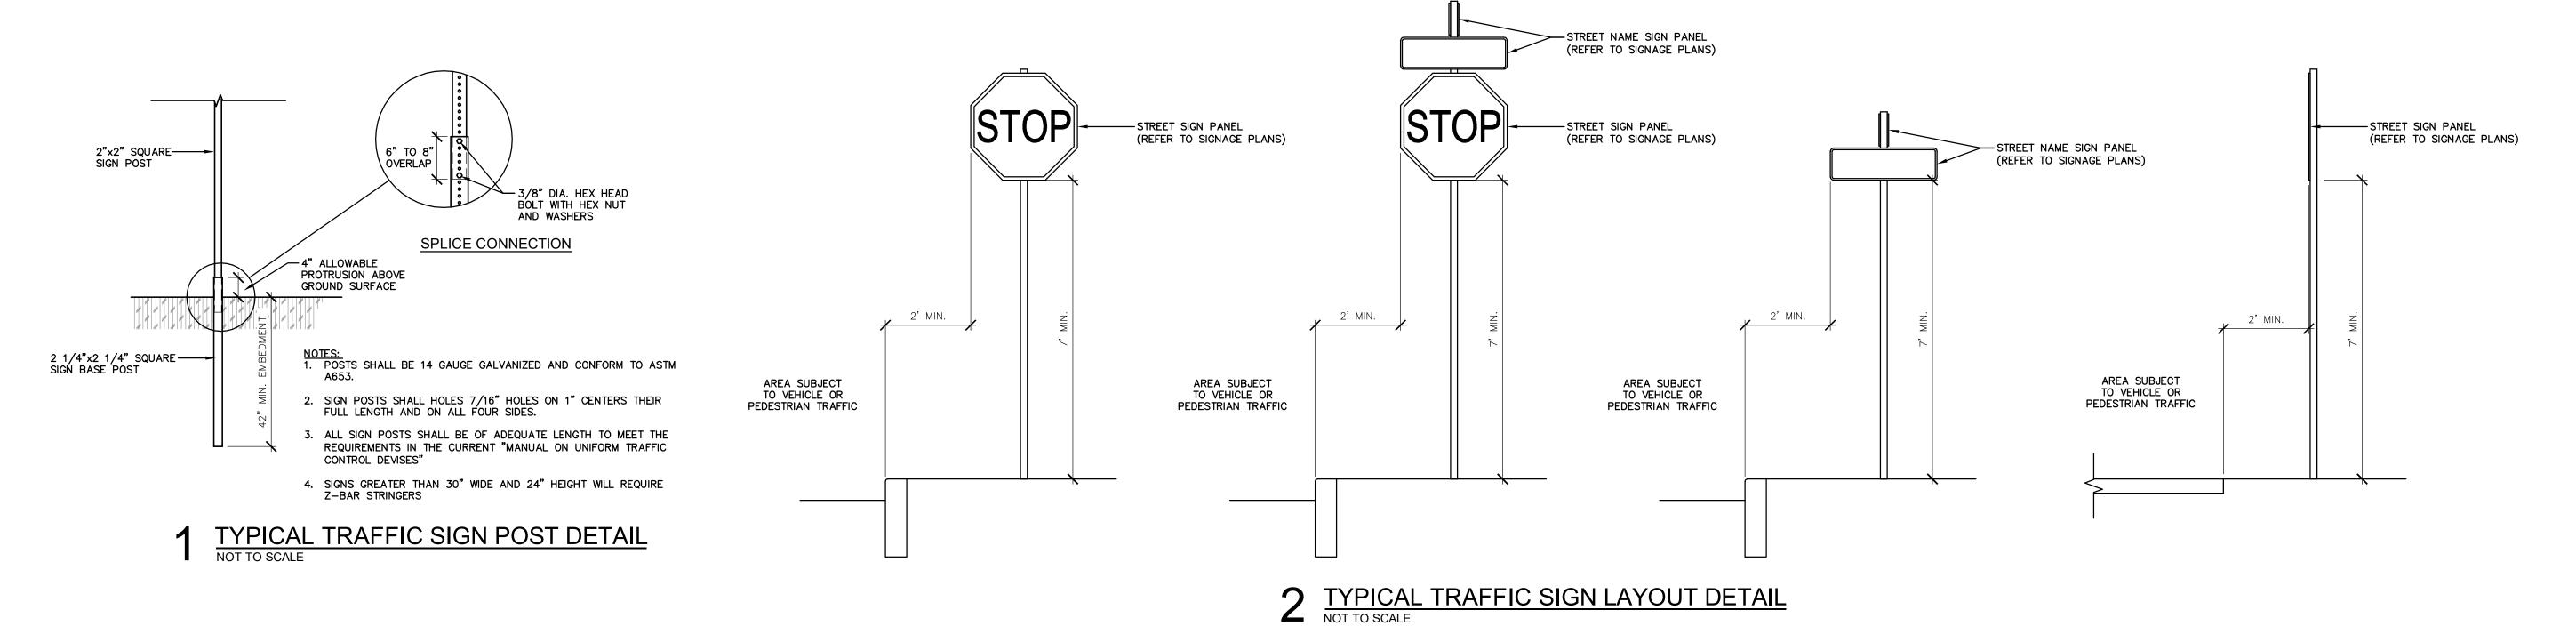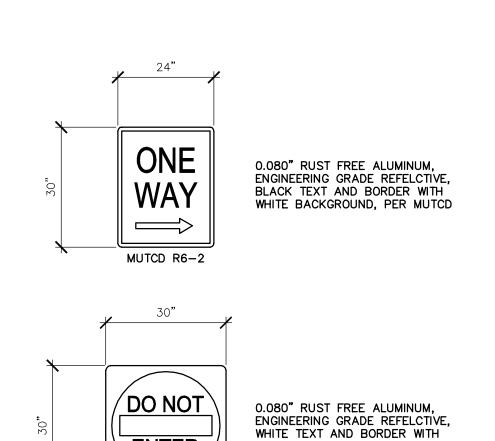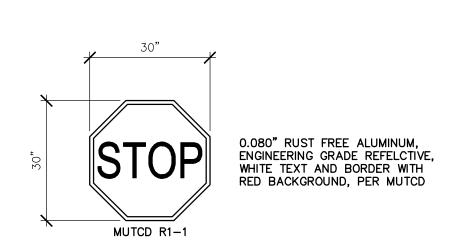12/13/2024 BID DOCUMENTS FOR CONSTRUCTION







RED BACKGROUND, PER MUTCD


NOTES:

1. ALL SIGNS SHALL BE INSTALLED IN ACCORDANCE WITH
THE CURRENT "MANUAL ON UNIFORM TRAFFIC CONTROL DEVICES".


ENTER

- 2. SIGNS WIDER THAN 30" SHALL USE TWO OR MORE POSTS.
- 3. SIGN POSTS AND MOUNTING SHALL BE CONSTRUCTED AS TO HOLD SIGNS IN A PROPER AND PERMANENT POSITION AND TO RESIST SWAYING IN THE WIND OR DISPLACEMENT BY VANDALISM.

## STREET SIGN PANEL DETAIL NOT TO SCALE

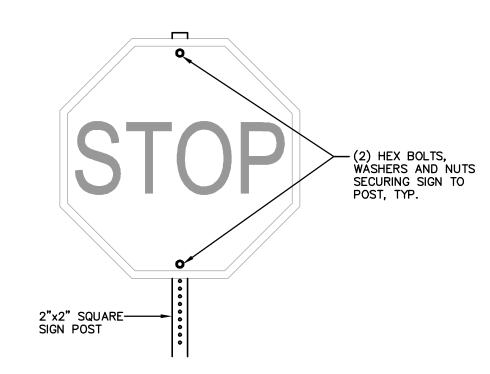


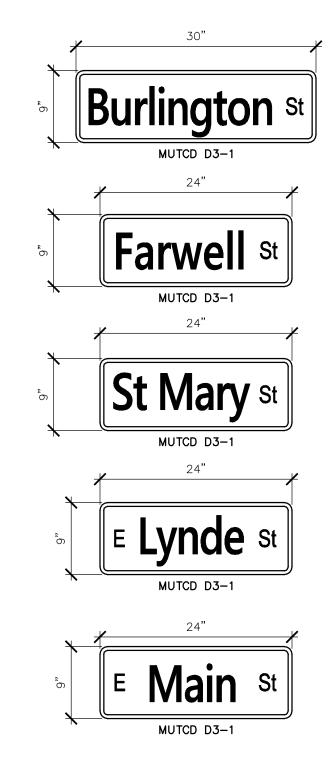STREET SIGN MOUNTING DETAIL
NOT TO SCALE




STREET NAME SIGNS:
0.080" RUST FREE ALUMINUM,
ENGINEERING GRADE REFLECTIVE,
WHITE TEXT AND BORDER WITH GREEN BACKGROUND, PER MUTCD, INITIAL UPPER CASE LETTER SHALL BE A MIN. 4" HIGH, LOWER CASE LETTERS SHALL BE MIN. 3' HIGH.
SUPPLEMENTAL UPPER CASE LETTER SHALL BE A MIN. 3" HIGH, LOWER CASE LETTERS SHALL BE MIN. 2 1/4" HIGH.


# STREET NAME SIGN PANEL DETAIL NOT TO SCALE

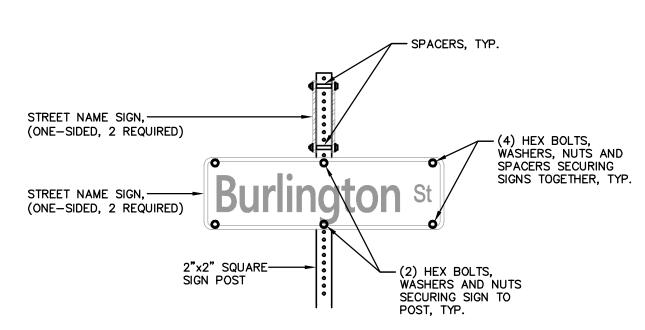

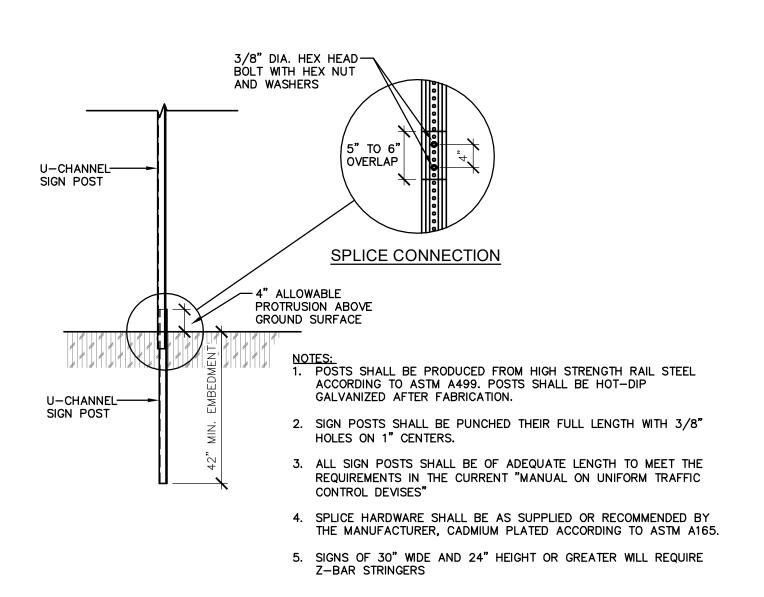STREET NAME SIGN MOUNTING DETAIL NOT TO SCALE



## TYPICAL "NO PARKING" SIGN POST DETAIL NOT TO SCALE

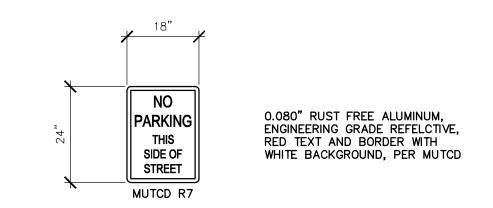


NOTES:

1. ALL SIGNS SHALL BE INSTALLED IN ACCORDANCE WITH
THE CURRENT "MANUAL ON UNIFORM TRAFFIC CONTROL

2. SIGN POSTS AND MOUNTING SHALL BE CONSTRUCTED AS TO HOLD SIGNS IN A PROPER AND PERMANENT POSITION AND TO RESIST SWAYING IN THE WIND OR DISPLACEMENT BY VANDALISM.

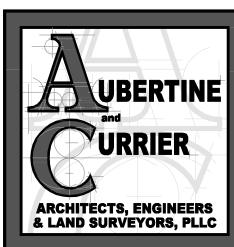"NO PARKING" SIGN PANEL DETAIL
NOT TO SCALE

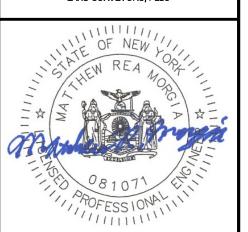


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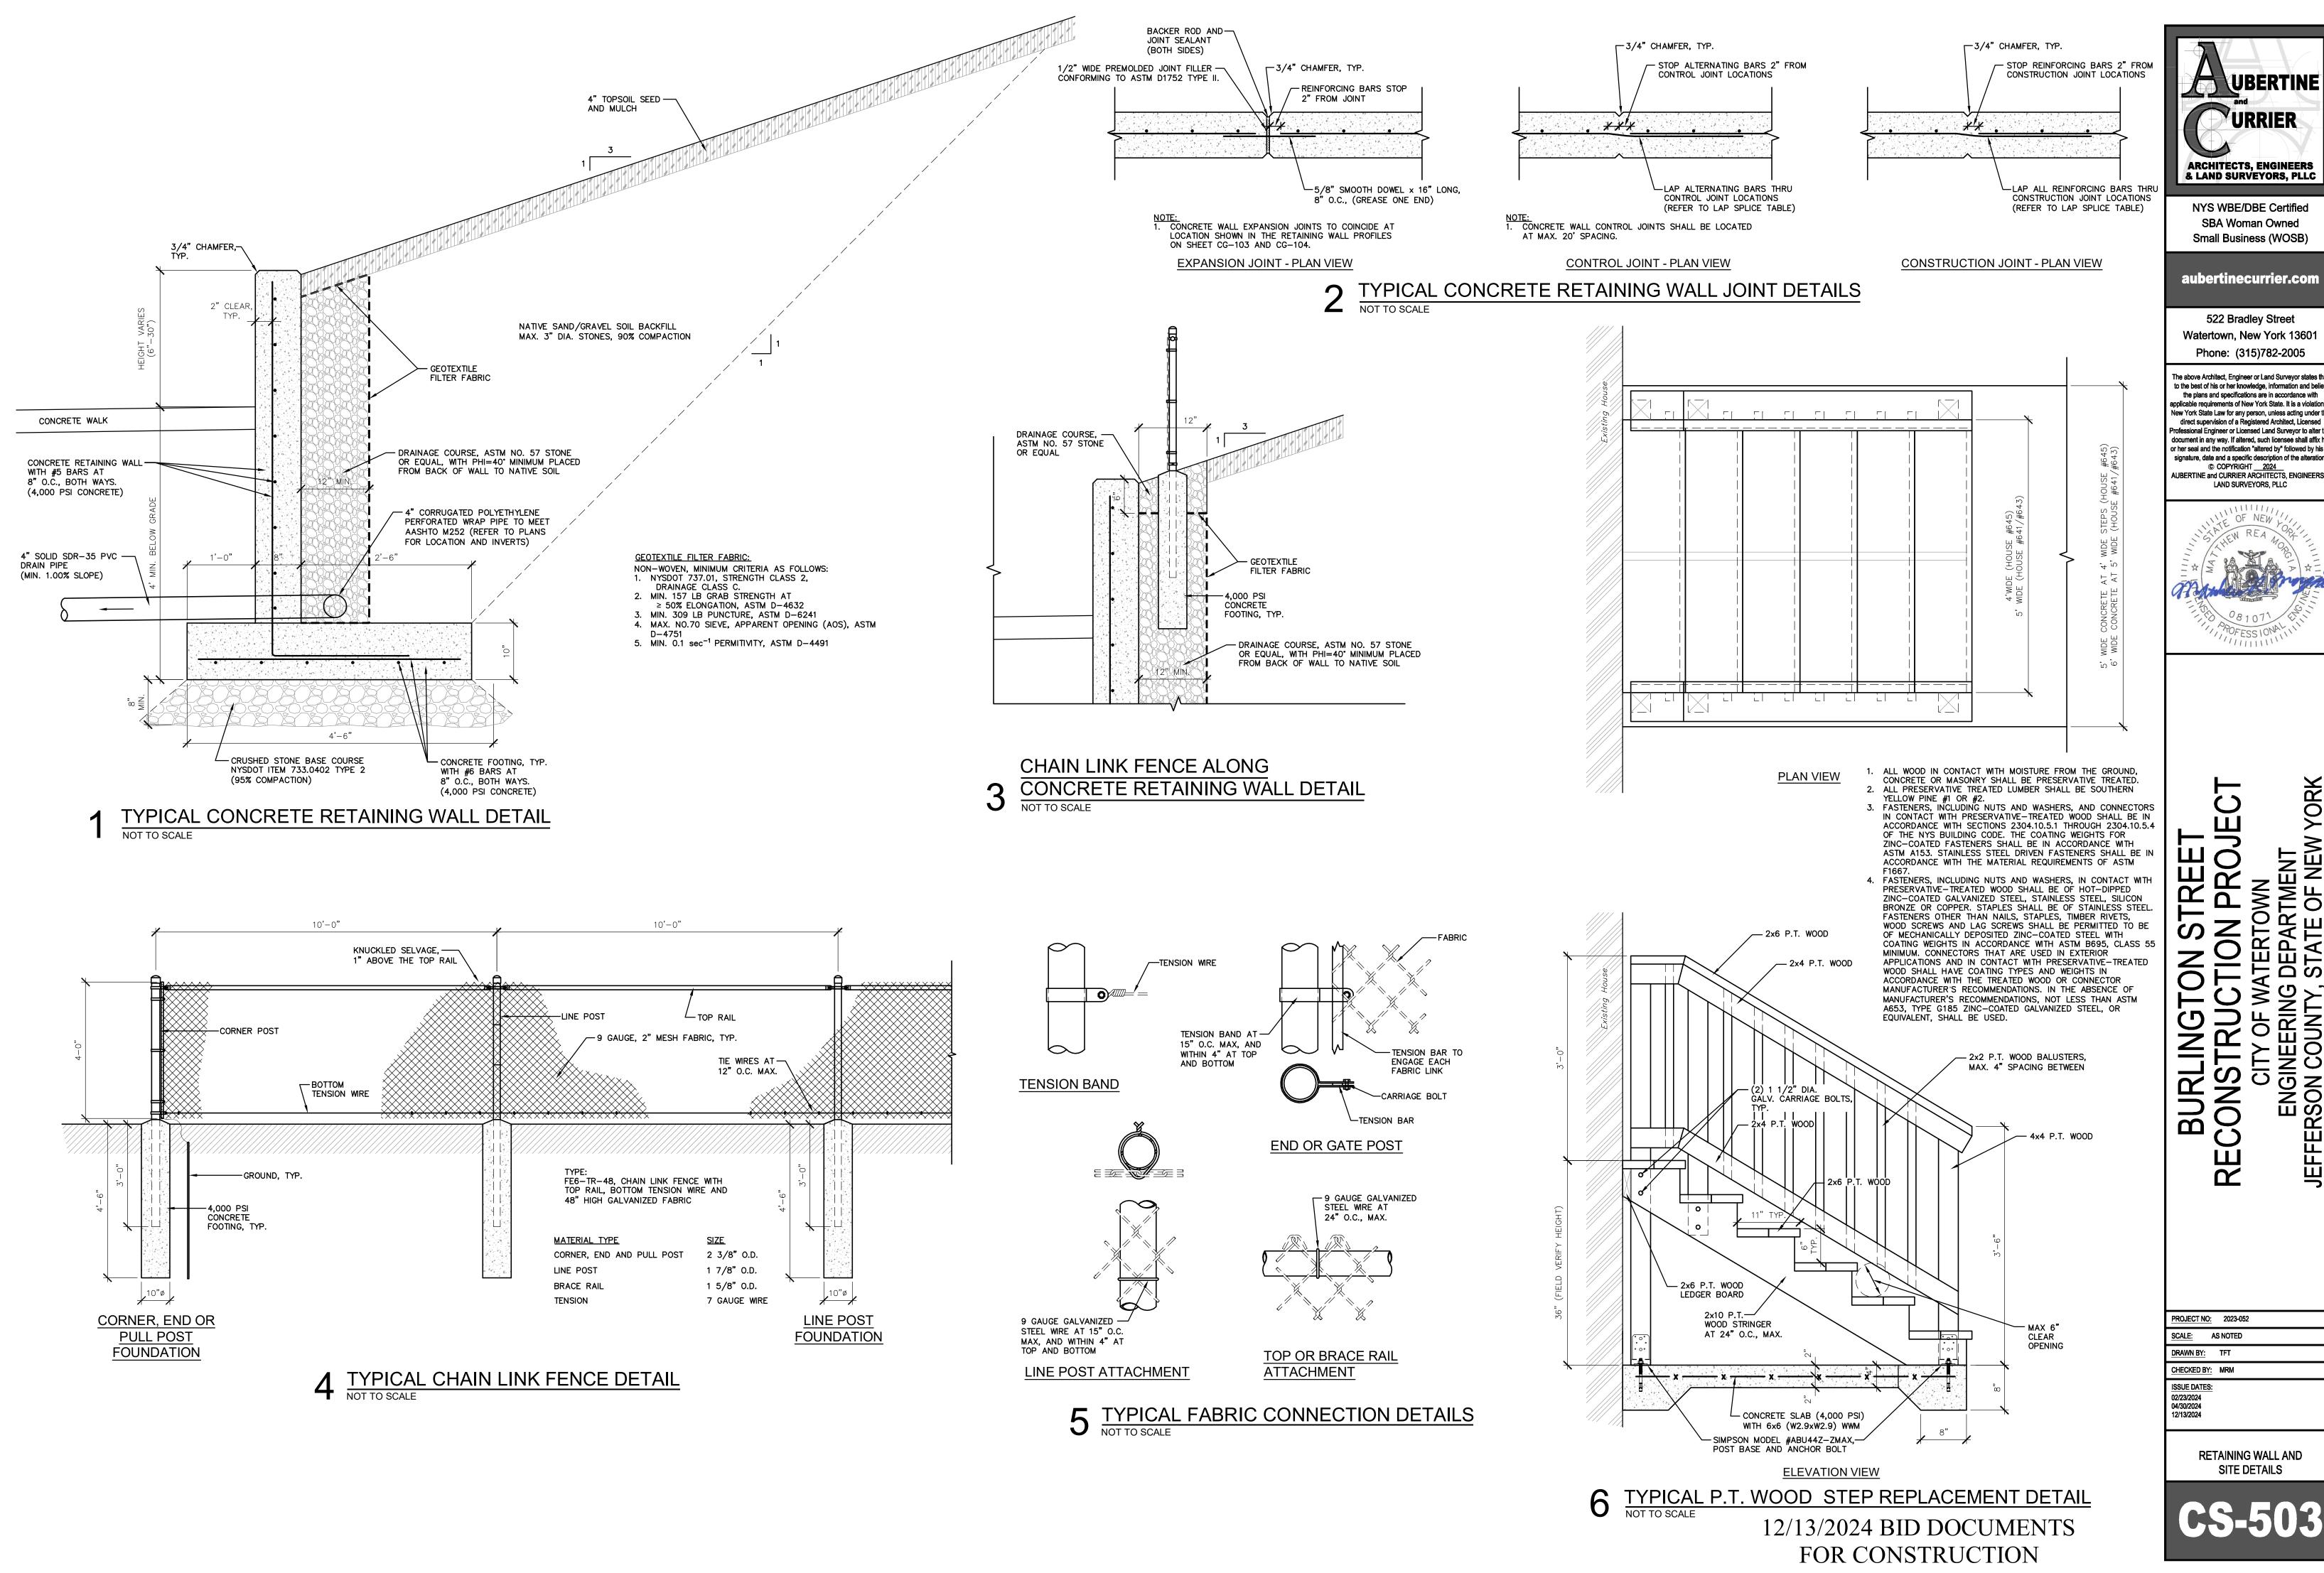
YORK

BURLINGTON STREET
RECONSTRUCTION PROJEC
CITY OF WATERTOWN
ENGINEERING DEPARTMENT
JEFFERSON COUNTY, STATE OF NEW YO

PROJECT NO: 2023-052 DRAWN BY: TFT

CHECKED BY: MRM 02/23/2024 04/30/2024 12/13/2024

SIGNAGE DETAILS



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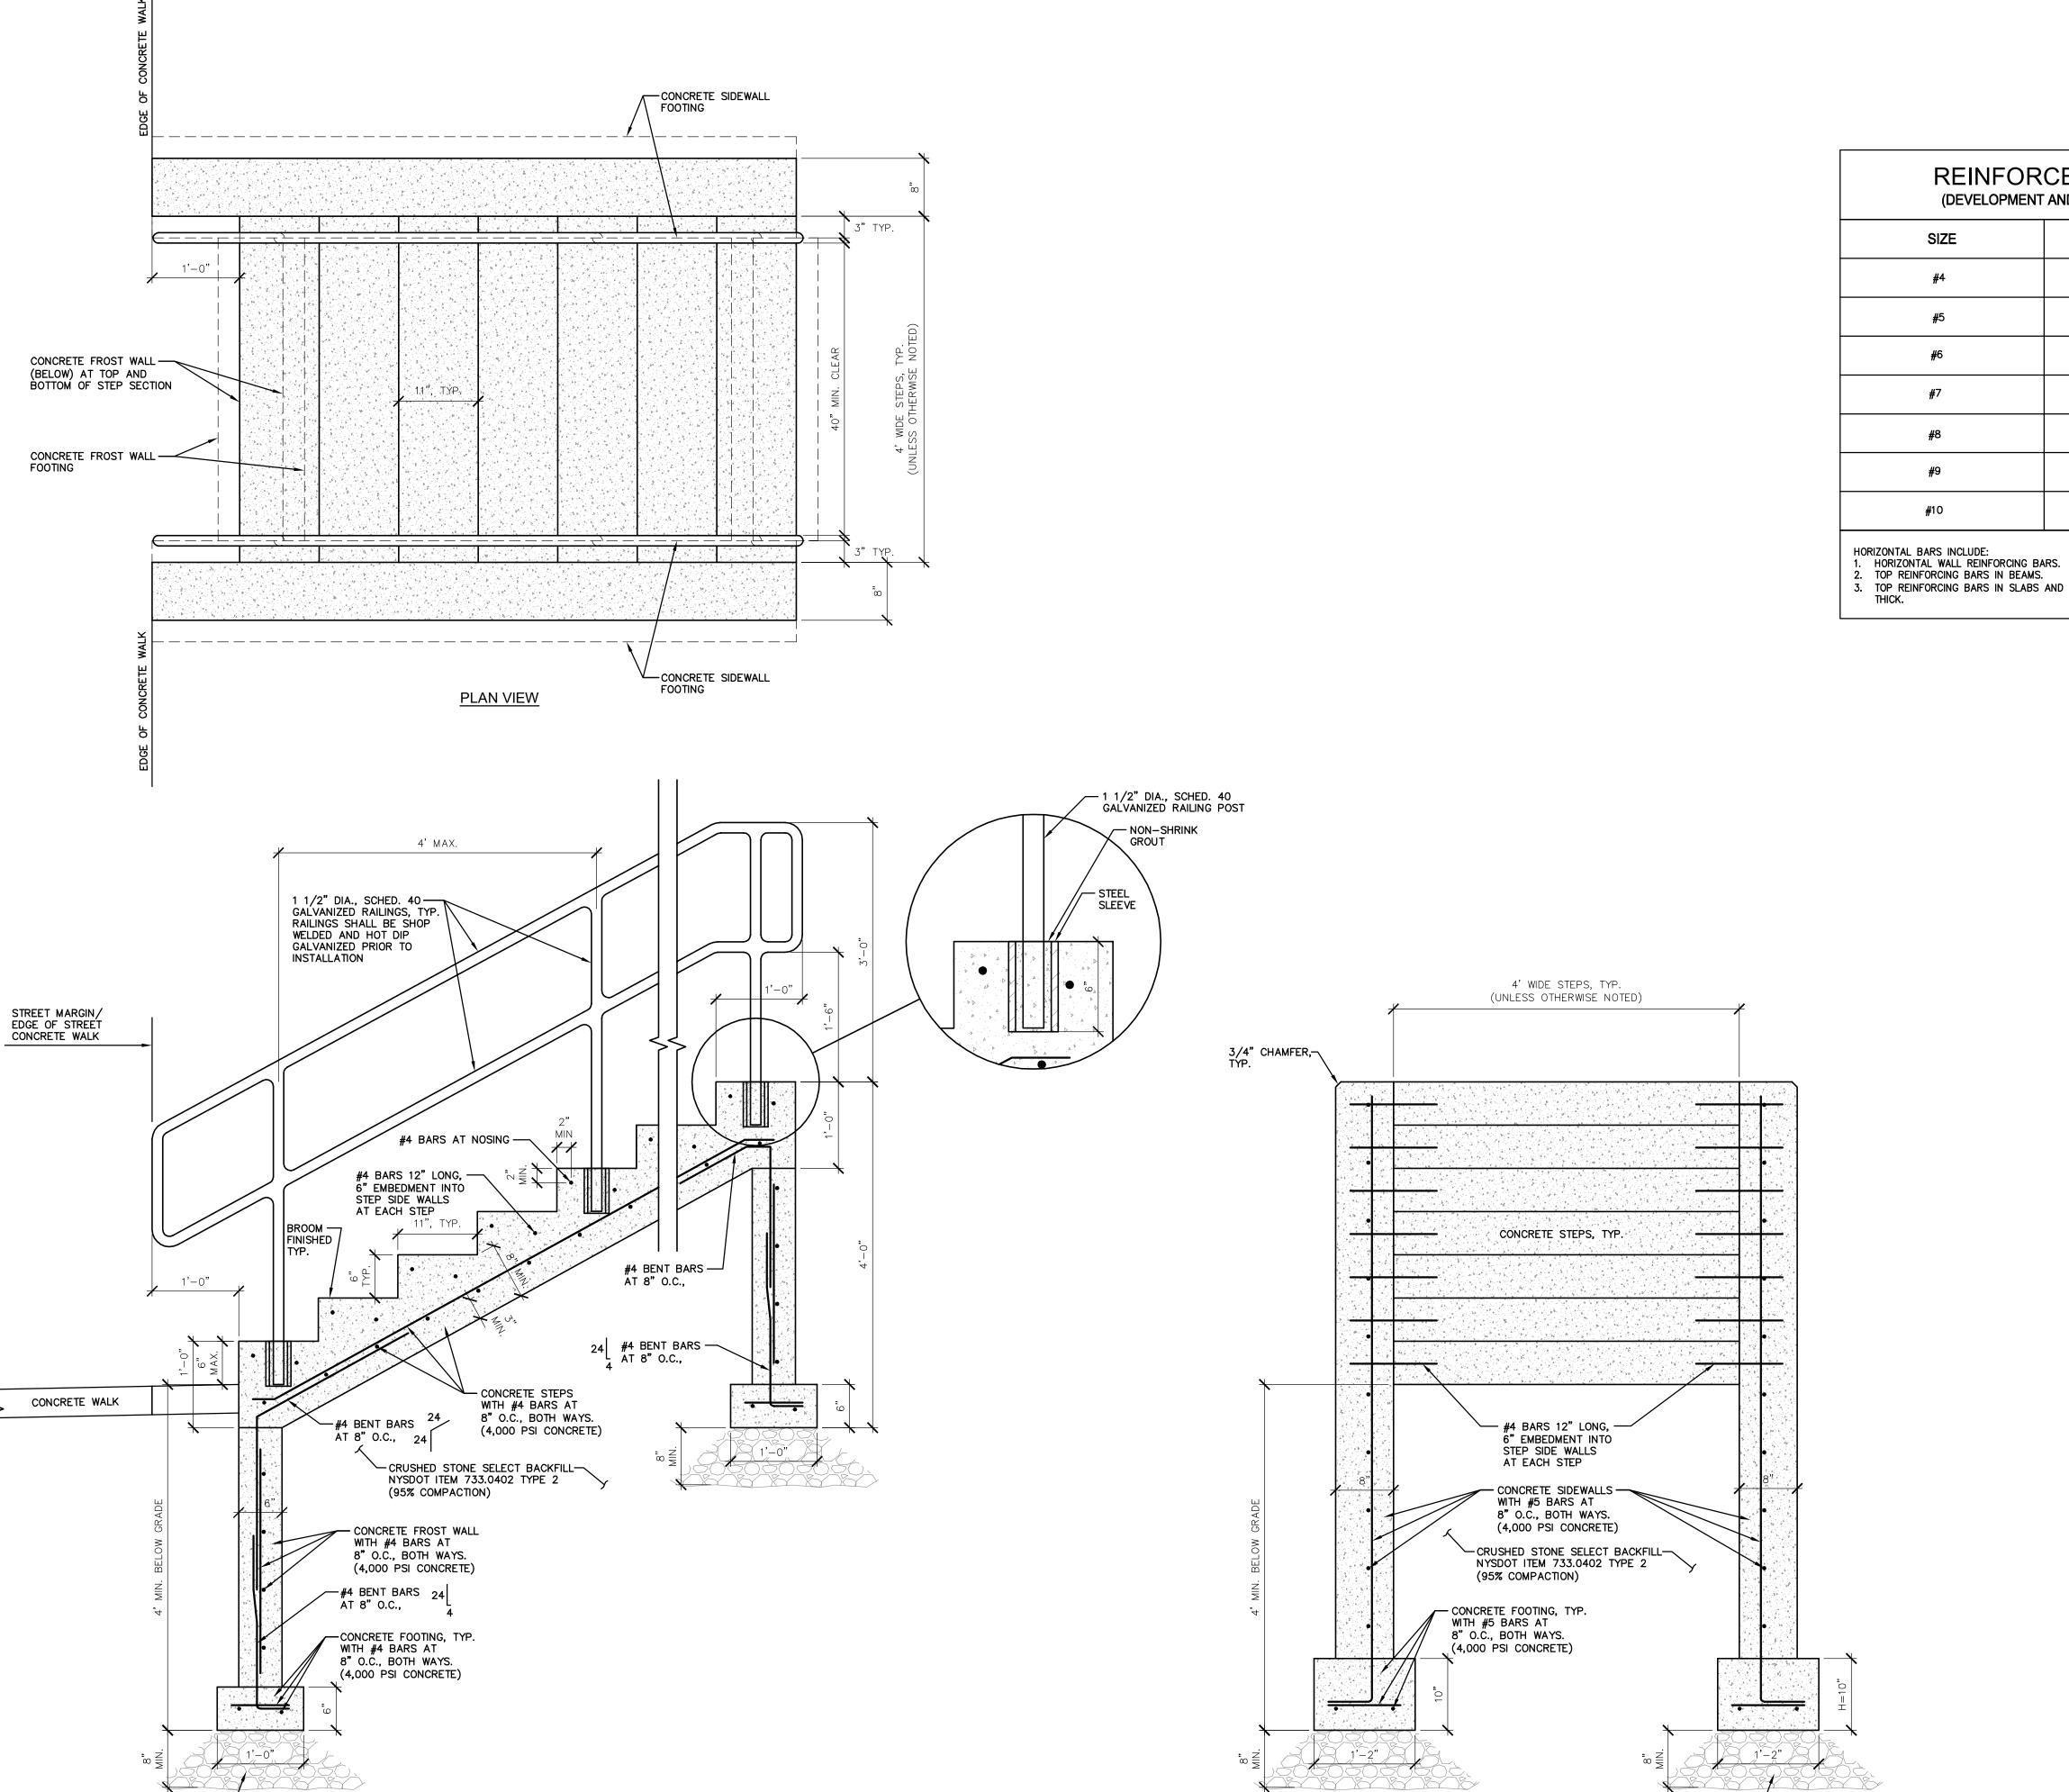
YORK

WATERTOWN ING DEPARTMENT ITY, STATE OF NEW N CITY OF WATENGINEERING DIEFFERSON COUNTY, S RECONS

PROJECT NO: 2023-052

DRAWN BY: TFT CHECKED BY: MRM ISSUE DATES:

> RETAINING WALL AND SITE DETAILS



	RCEMENT SPLICE IT AND LAP SPLICES FOR TYPICAL	
SIZE	HORIZONTAL BARS*	OTHER BARS*
#4	24" (2'-0")	18" (1'-6")
<b>#</b> 5	30" (2'-6")	24" (2'-0")
#6	36" (3'-0")	30" (2'-6")
#7	54" (4'-6")	42" (3'-6")
#8	60" (5'-0")	48" (4'-0")
#9	72" (6'-0")	54" (4'-6")
<i>#</i> 10	84" (7'-0")	60" (5'-0")

HORIZONTAL BARS INCLUDE:

CRUSHED STONE BASE COURSE NYSDOT ITEM 733.0402 TYPE 2 (95% COMPACTION)

**CROSS SECTION** 

3. TOP REINFORCING BARS IN SLABS AND WALL FOOTINGS GREATER THAN 12"

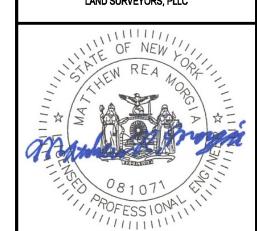
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YORK BURLINGTON STREET CITY OF WATENGINEERING L RECONSTRUC

PROJECT NO: 2023-052

DRAWN BY: TFT CHECKED BY: MRM


ISSUE DATES: 02/23/2024 04/30/2024 12/13/2024


CONCRETE STEP AND SIDEWALL DETAILS

- CRUSHED STONE BASE COURSE NYSDOT ITEM 733.0402 TYPE 2

(95% COMPACTION)


**ELEVATION VIEW** 

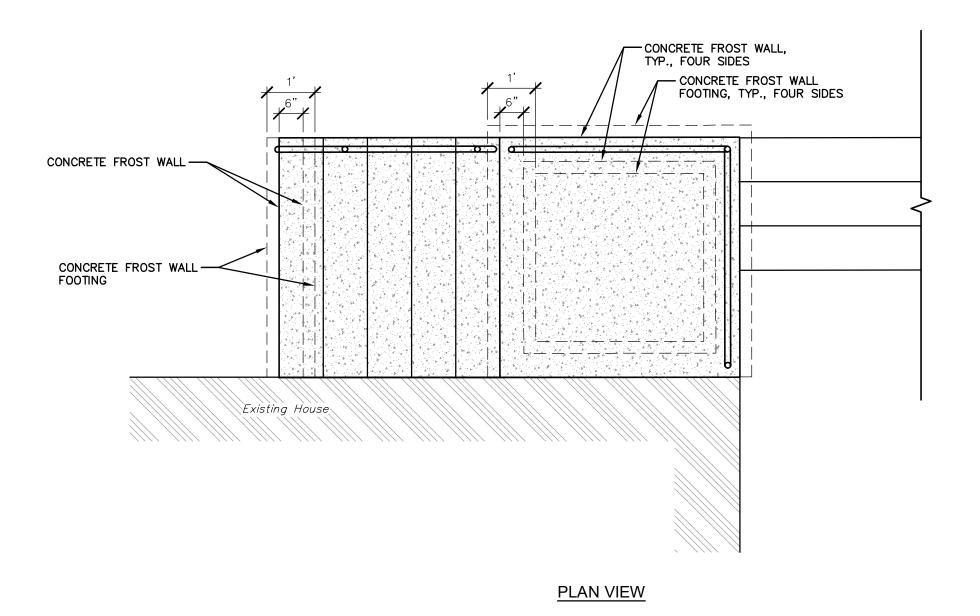


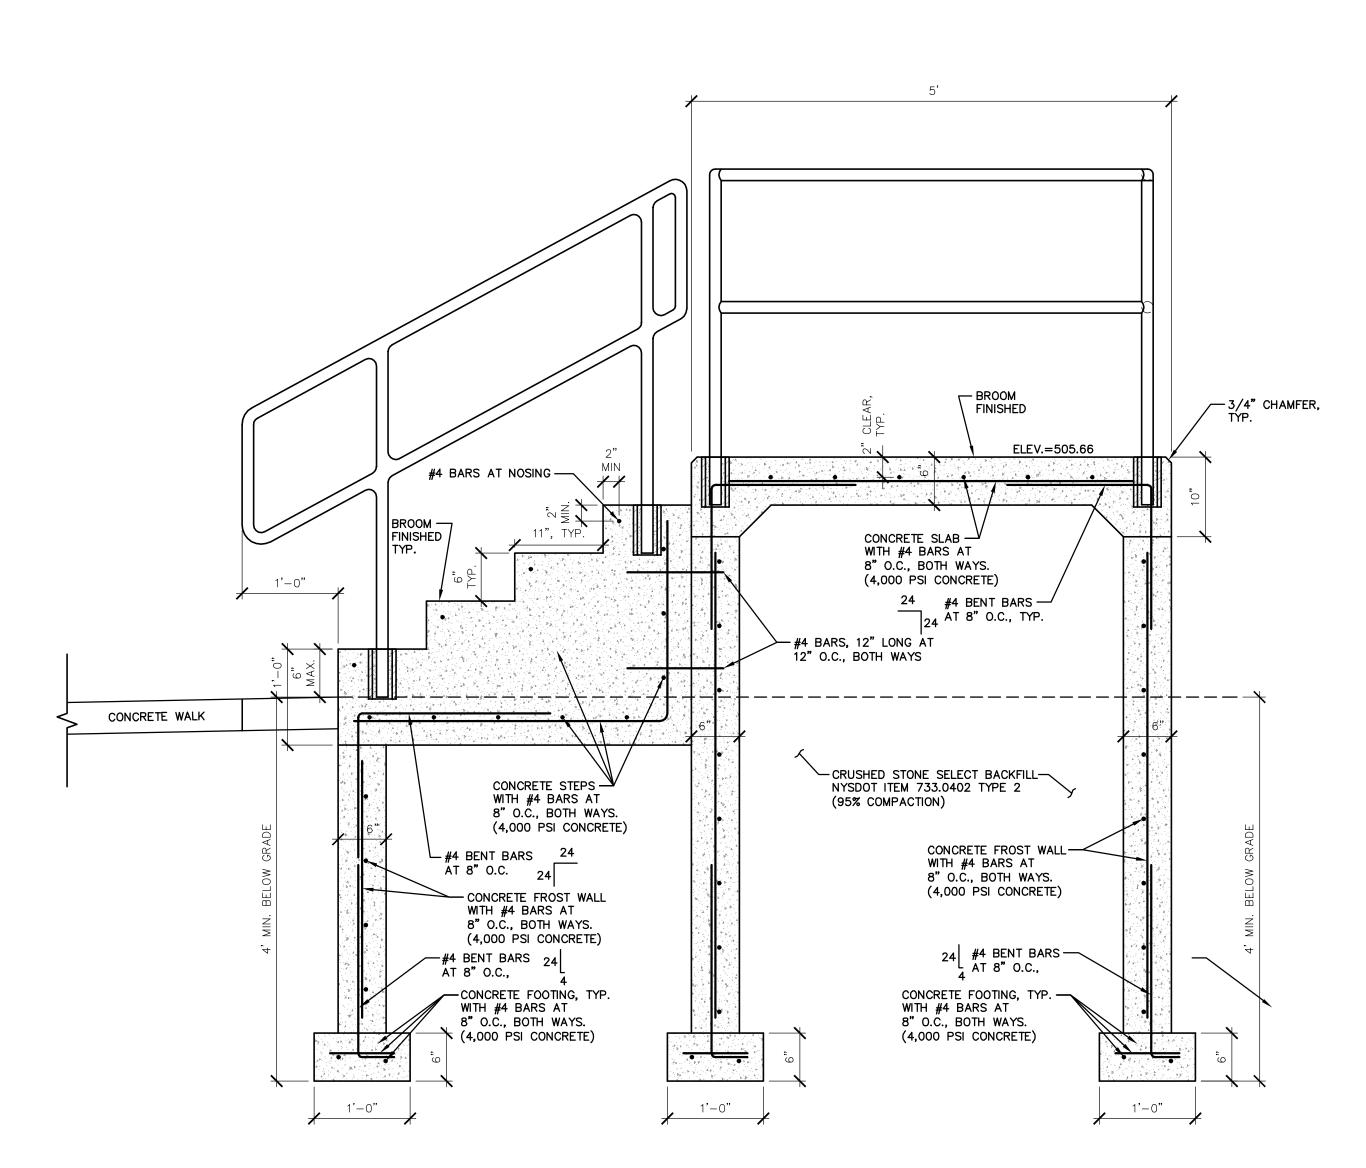


**ELEVATION VIEW** 

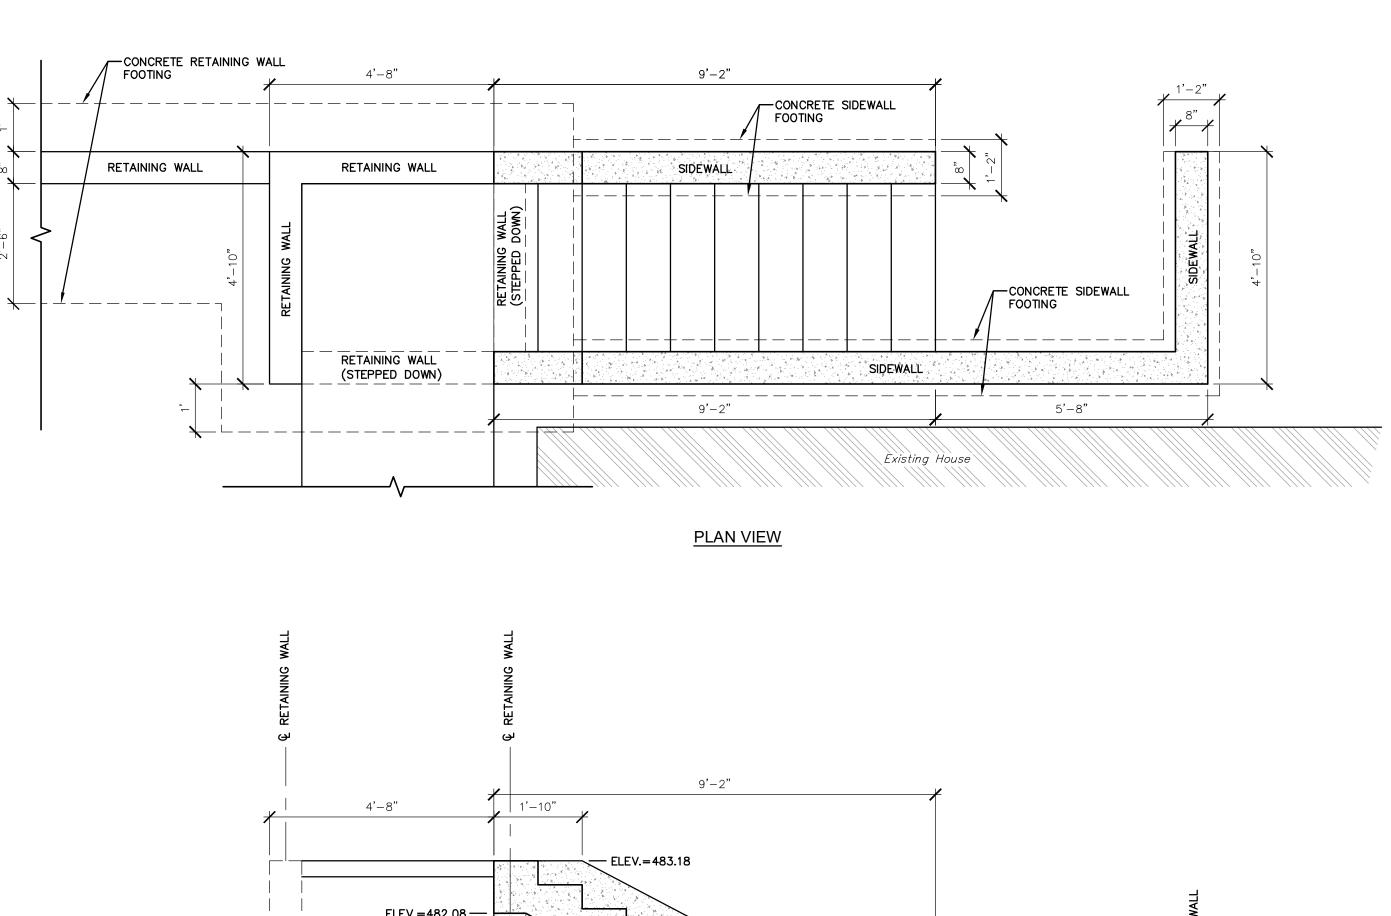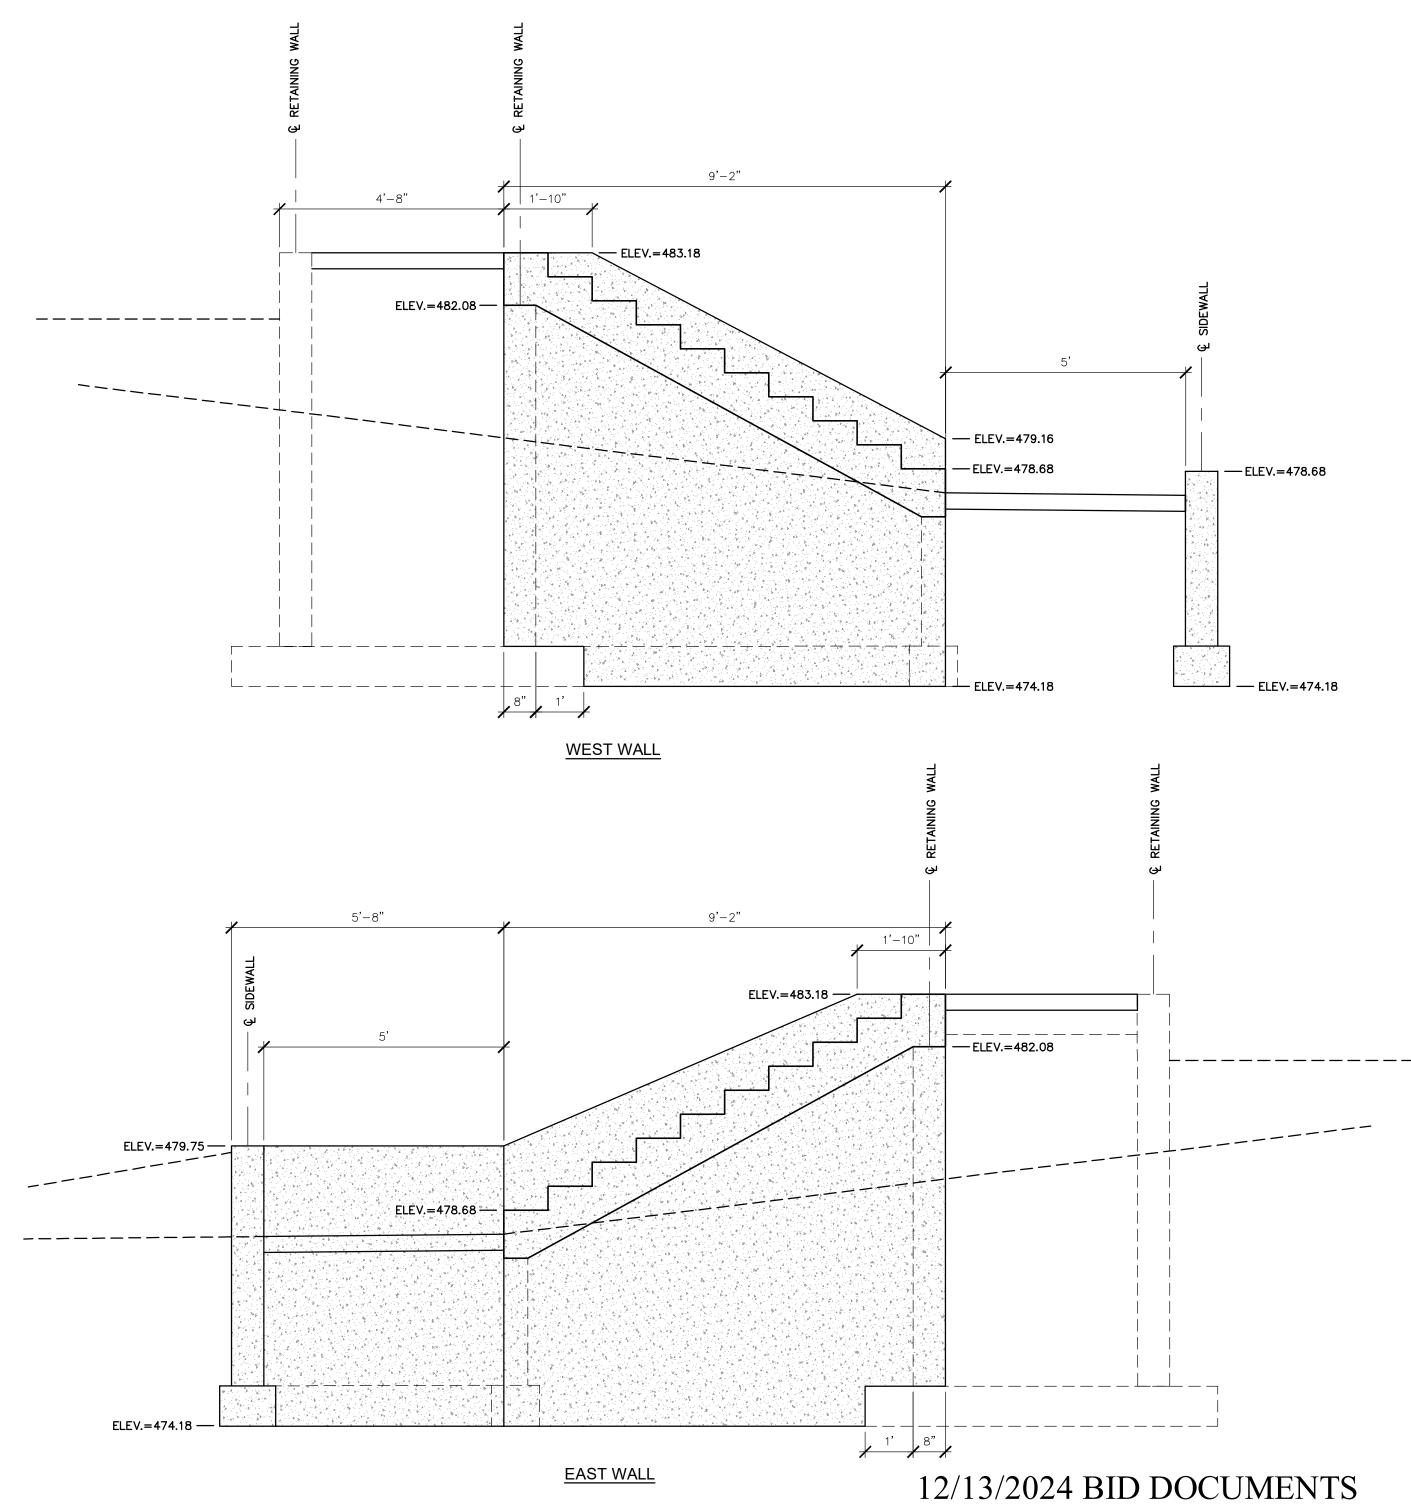1 CONCRETE STEPS DETAIL AT #237 EAST MAIN STREET
NOT TO SCALE





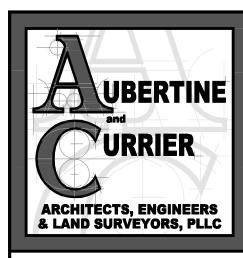
2 CONCRETE STEPS DETAIL AT #644/646 BURLINGTON STREET NOT TO SCALE



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RECONSTRUCTION PROJECT CITY OF WATERTOWN ENGINEERING DEPARTMENT JEFFERSON COUNTY, STATE OF NEW YORK


PROJECT NO: 2023-052

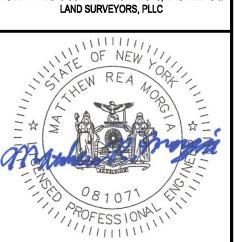AWN BY: TFT
ECKED BY: MRM


SUE DATES: /23/2024 /30/2024 /13/2024

FOR CONSTRUCTION

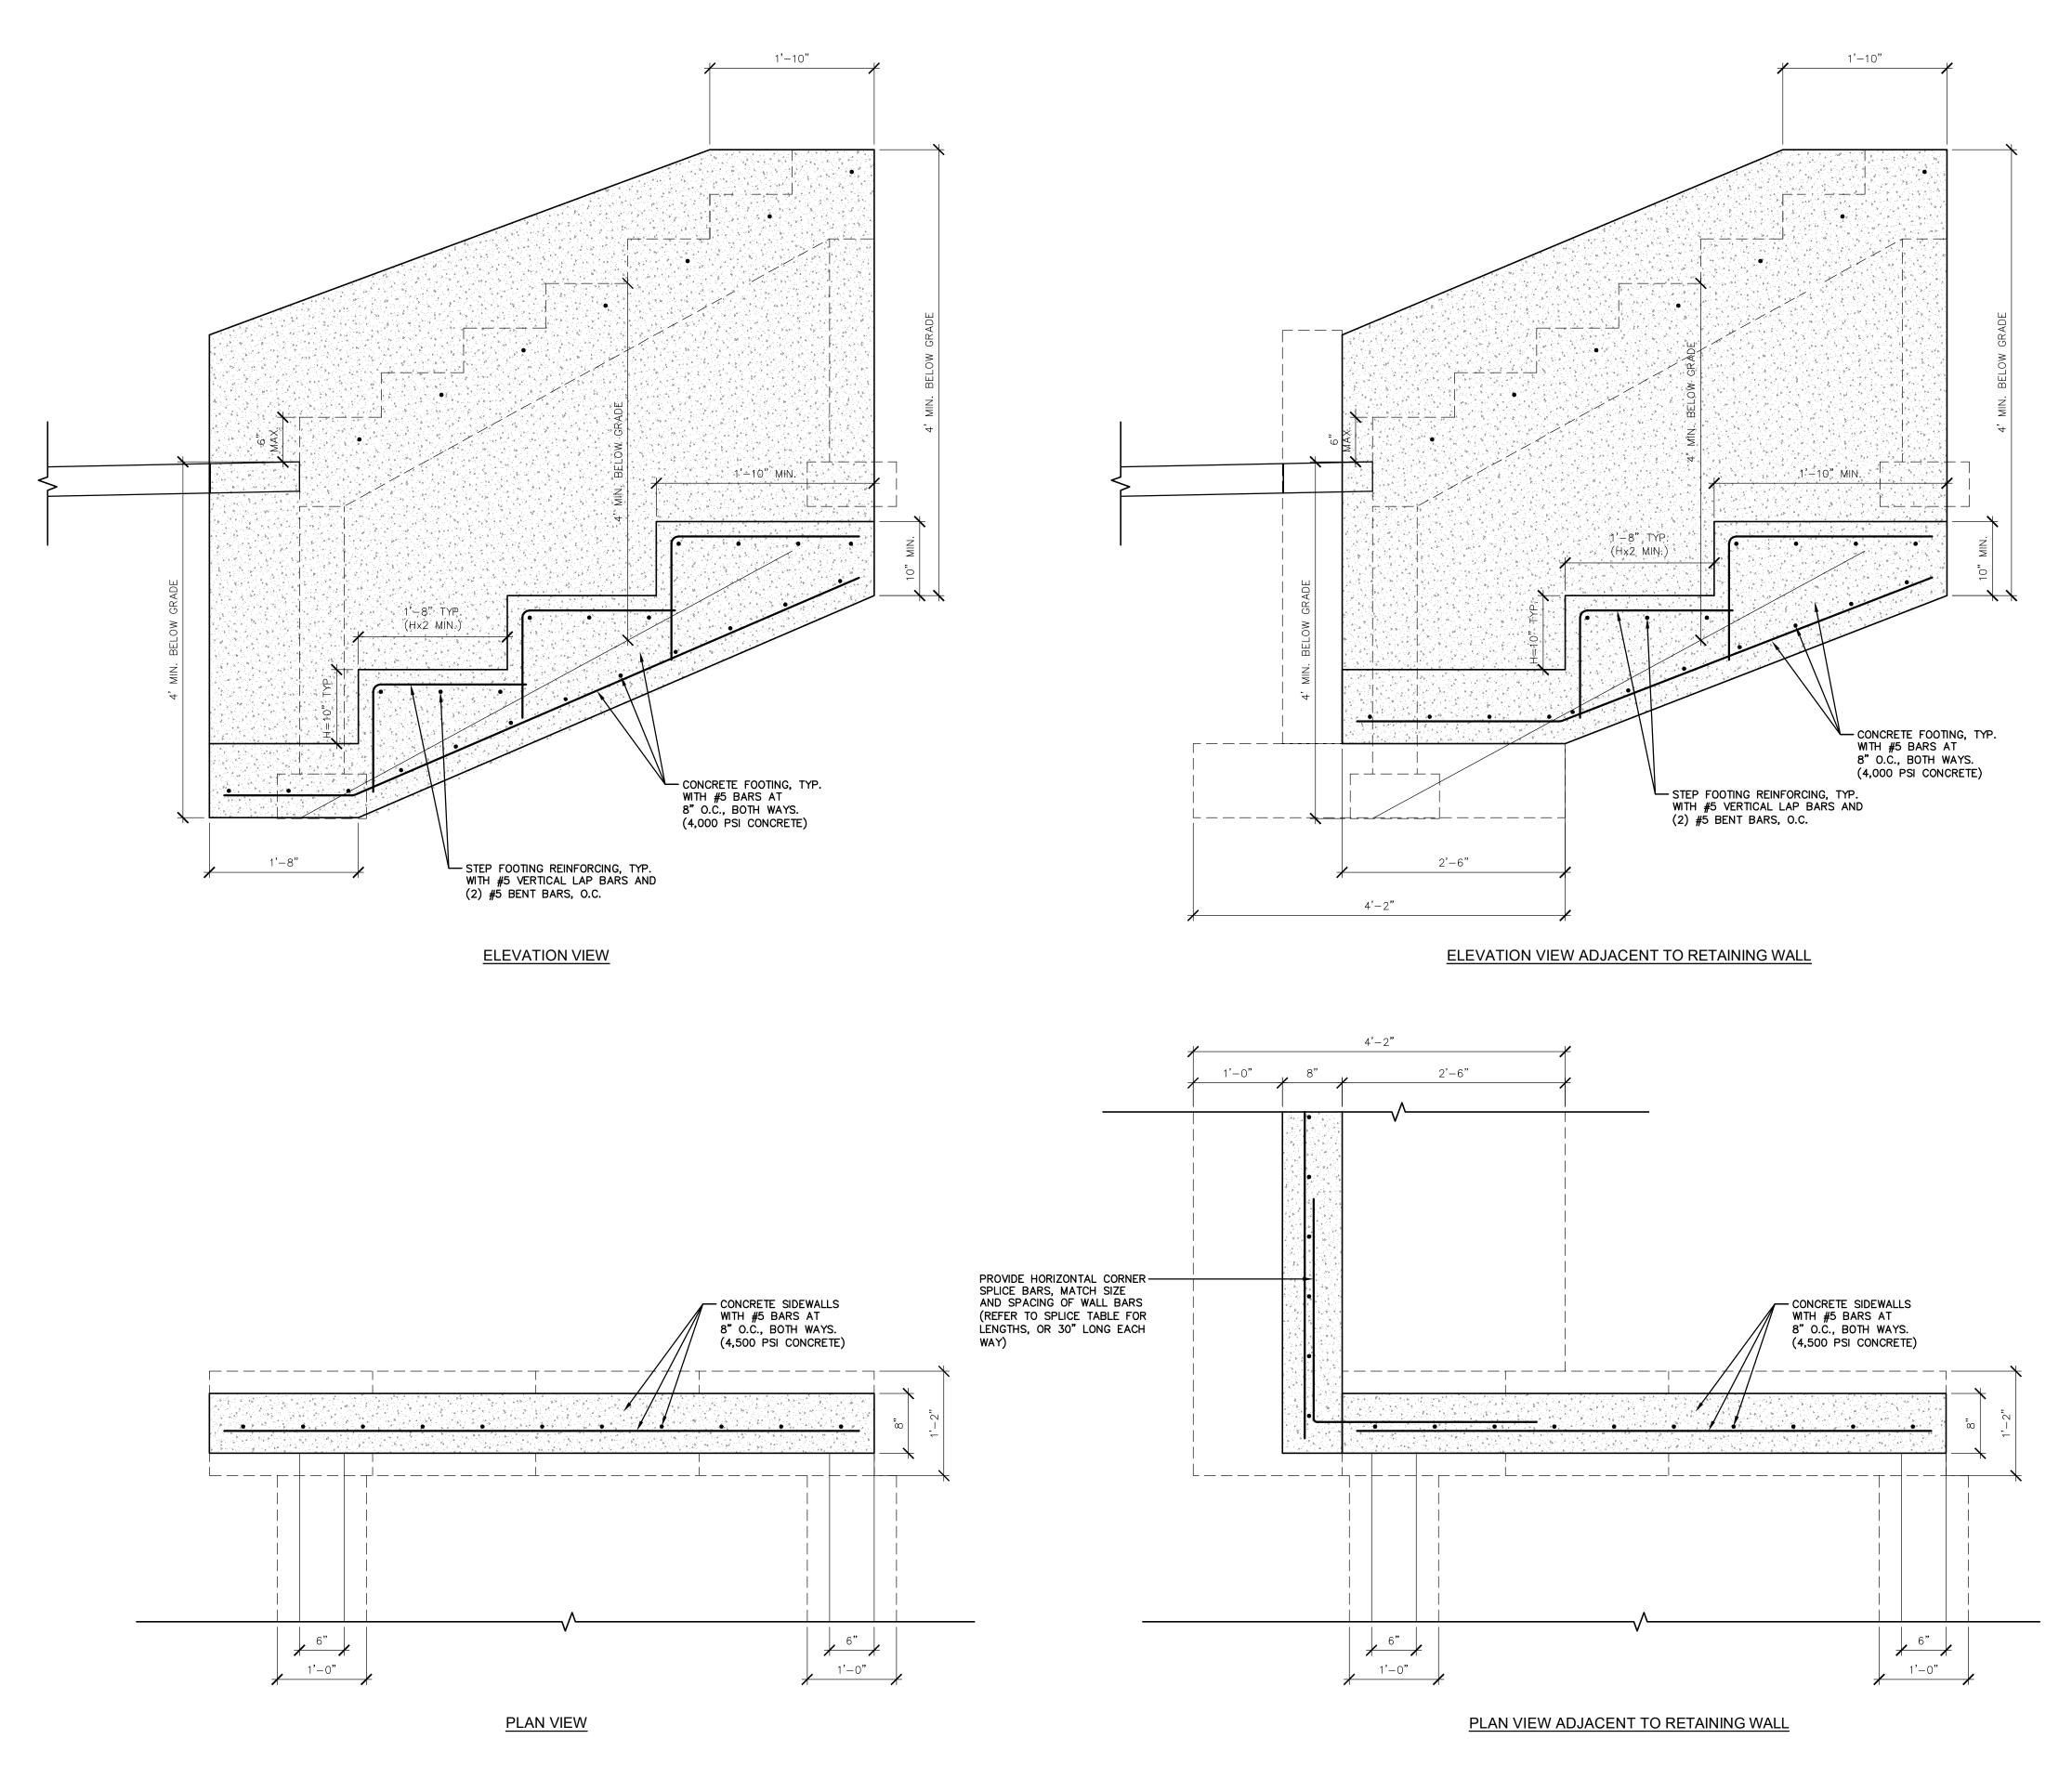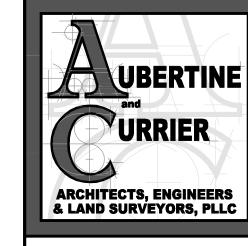CONCRETE STEP DETAILS








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ENGINEERING DEPARTMENT
JEFFERSON COUNTY, STATE OF NEW YORK


PROJECT NO: 2023-052

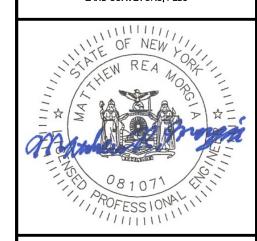SCALE: AS NOTED

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ISSUE DATES: 02/23/2024 04/30/2024 12/13/2024

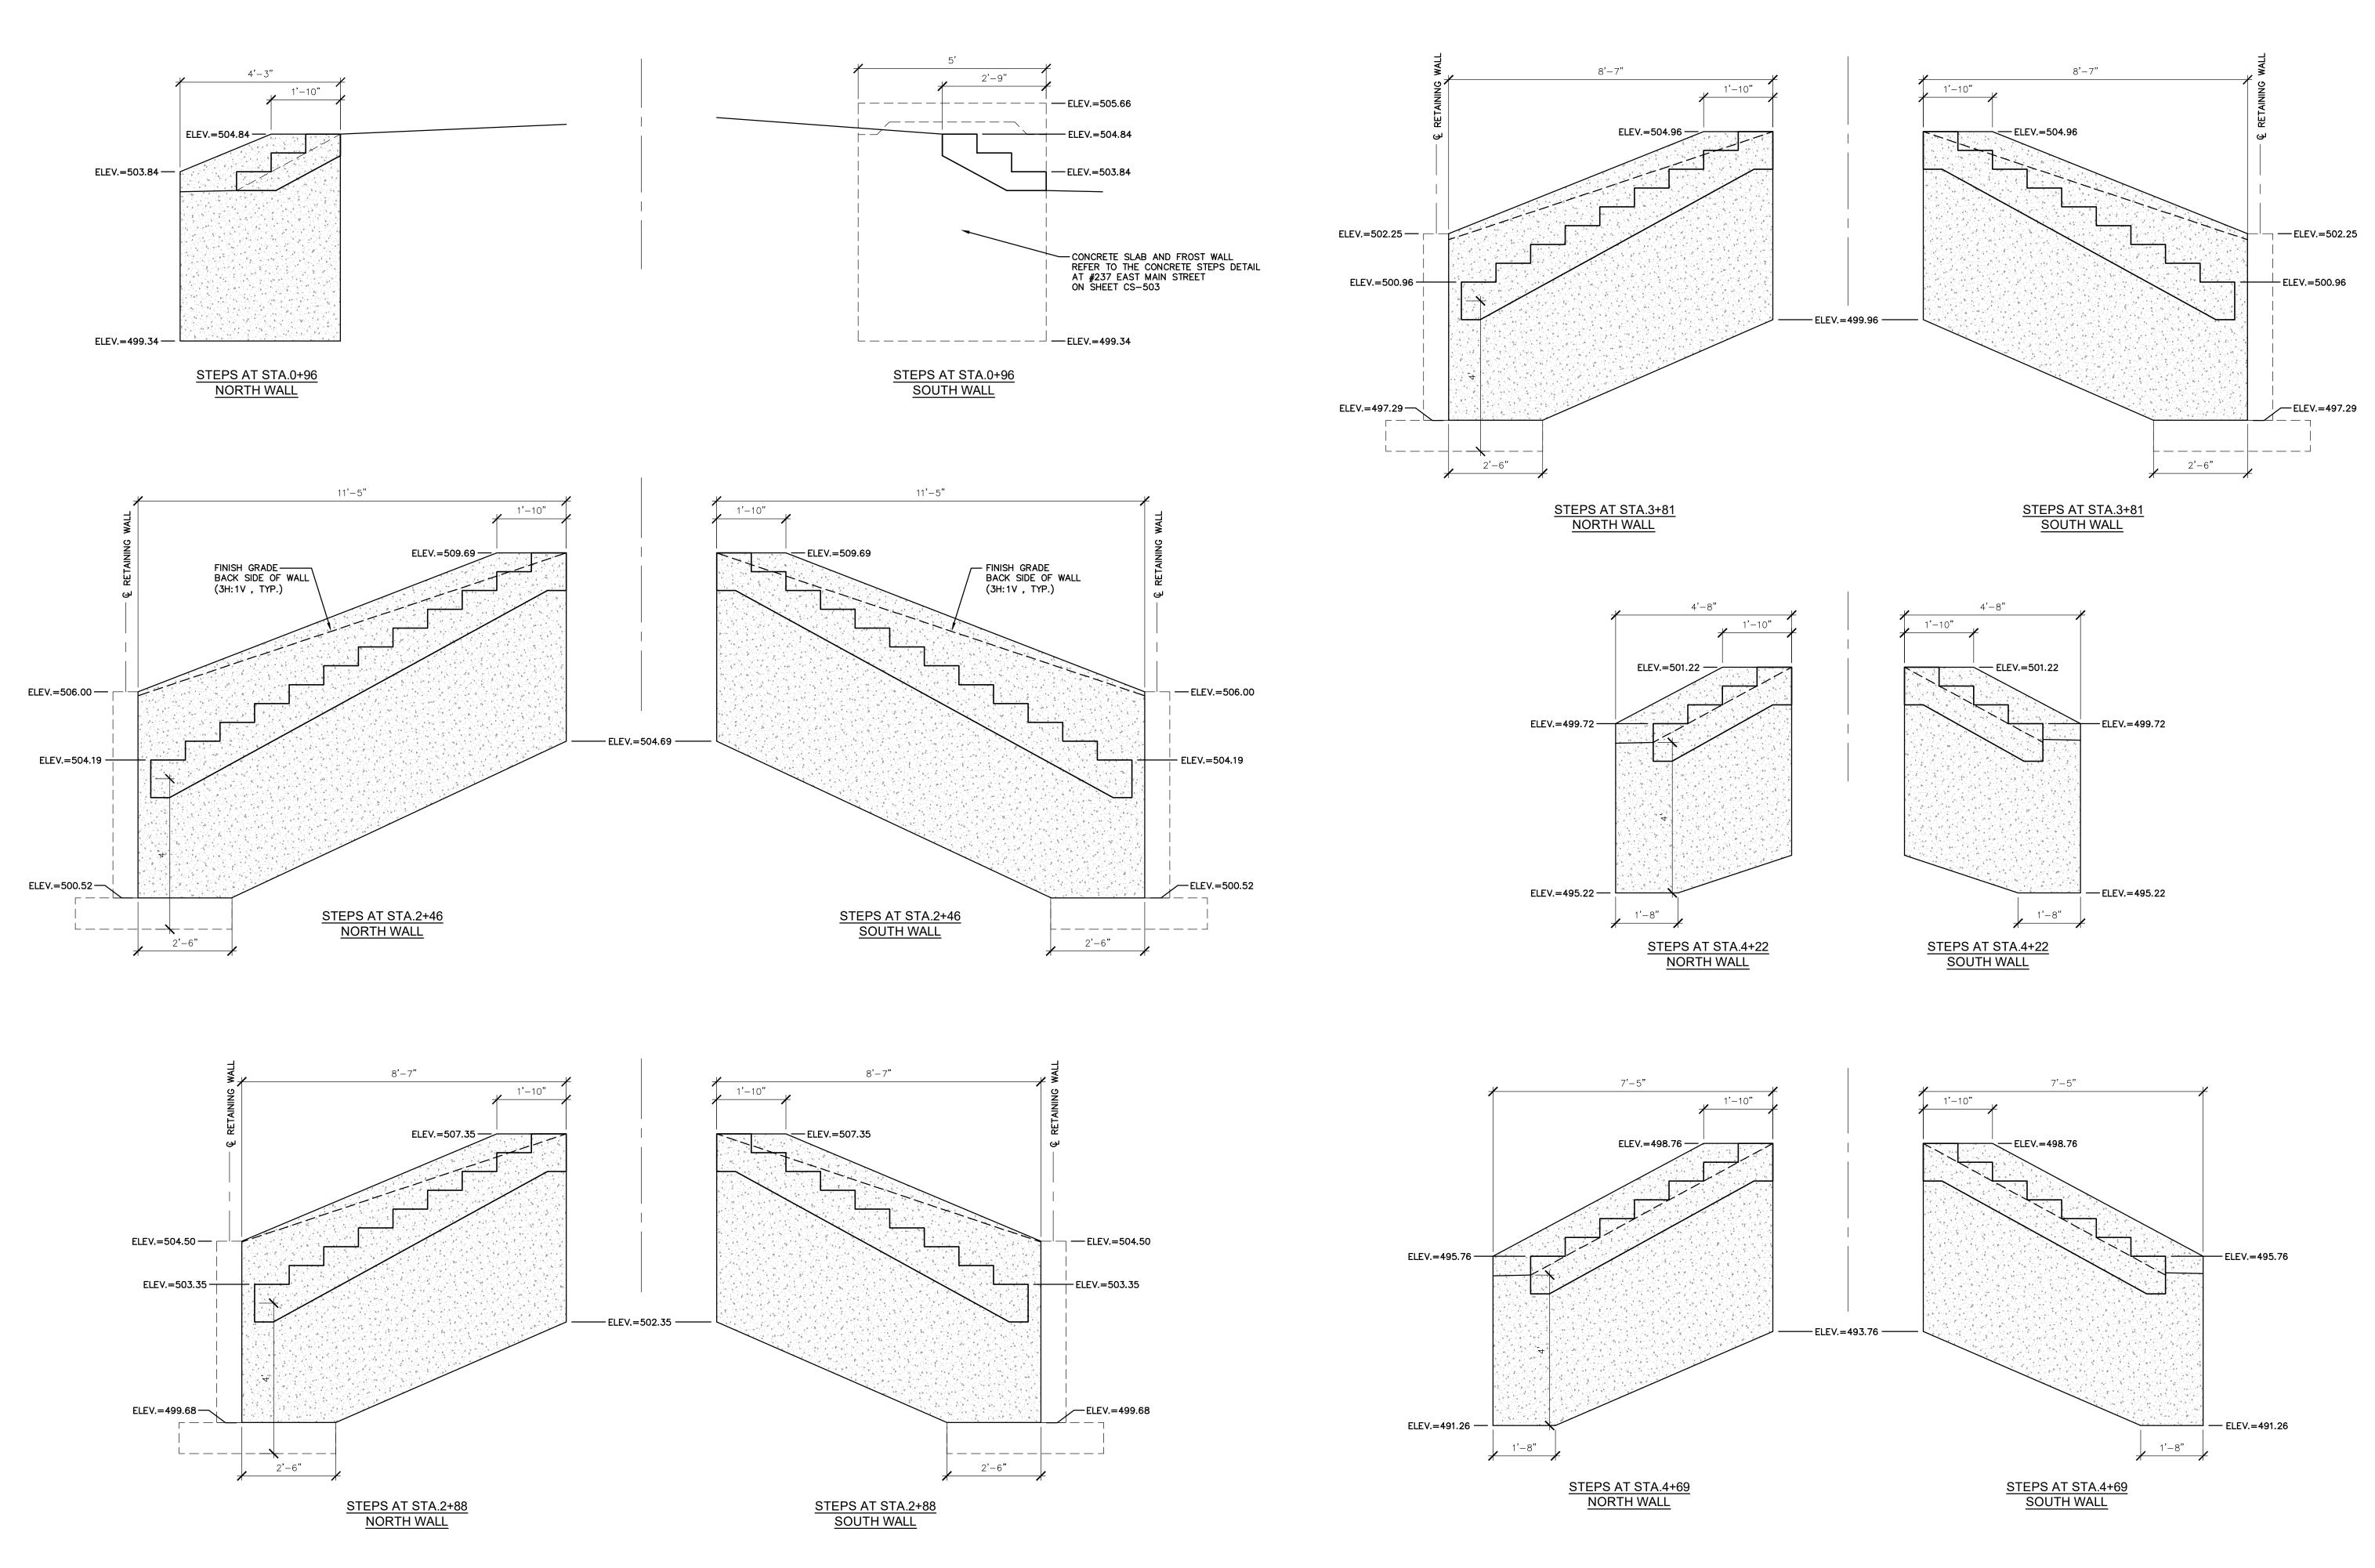CONCRETE STEP SIDEWALL DETAILS



UBERTINE


URRIER

ARCHITECTS, ENGINEERS
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NYS WBE/DBE Certified SBA Woman Owned Small Business (WOSB)

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BURLINGTON STREET
RECONSTRUCTION PROJECT
CITY OF WATERTOWN
ENGINEERING DEPARTMENT
JEFFERSON COUNTY, STATE OF NEW YORK

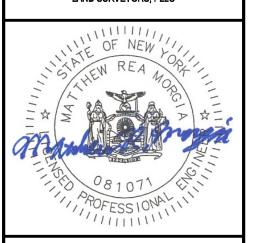 PROJECT NO:
 2023-052

 SCALE:
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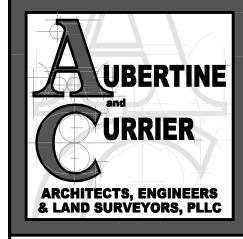
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ISSUE DATES: 02/23/2024 04/30/2024 12/13/2024

CONCRETE STEP SIDEWALL
CROSS SECTIONS



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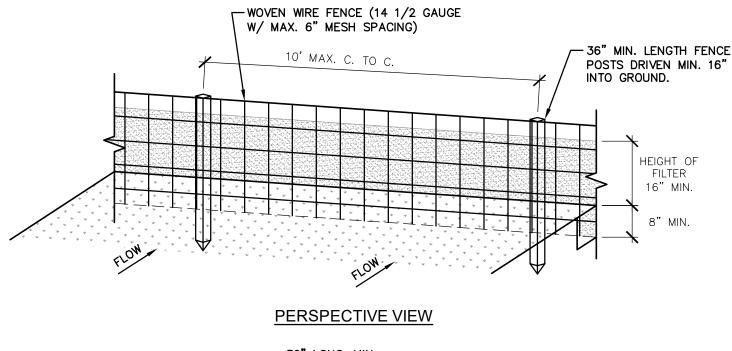
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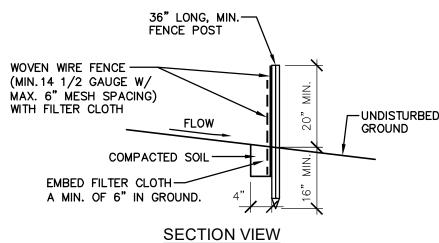
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CONCRETE STEP SIDEWALL CROSS SECTIONS






### CONSTRUCTION SPECIFICATIONS

- 1. WOVEN WIRE FENCE TO BE FASTENED SECURELY TO FENCE POSTS WITH WIRE TIES OR STAPLES. POSTS SHALL BE STEEL EITHER "T" OR "U" TYPE OR HARDWOOD.
- 2. FILTER CLOTH TO BE TO BE FASTENED SECURELY TO WOVEN WIRE FENCE WITH TIES SPACED EVERY 24" AT TOP AND MID SECTION. FENCE SHALL BE WOVEN WIRE, 12 1/2 GAUGE, 6" MAXIMUM MESH OPENING.
- 3. WHEN TWO SECTIONS OF FILTER CLOTH ADJOIN EACH OTHER THEY SHALL BE OVER-LAPPED BY SIX INCHES AND FOLDED. FILTER CLOTH SHALL MEET THE MINIMUM FOLLOWING REQUIREMENTS: a. 110 LBS, GRAB TENSILE STRENGTH (ASTM D4632)
  - b. 25 GAL/MIN/SF, FLOW THRU RATE (ASTM D4491)
  - c. 40-80 SEIVE, APPARENT OPENING SIZE (ASTM D4751) d. 70% MINIMUM UV RESIDUAL (ASTM D4355)
- 4. PREFABRICATED SILT FENCE IS ACCEPTABLE AS LONG AS ALL MATERIAL SPECIFICATIONS ARE MET.
- 5. MAINTENANCE SHALL BE PERFORMED AS NEEDED AND MATERIAL REMOVED WHEN "BULGES" DEVELOP IN

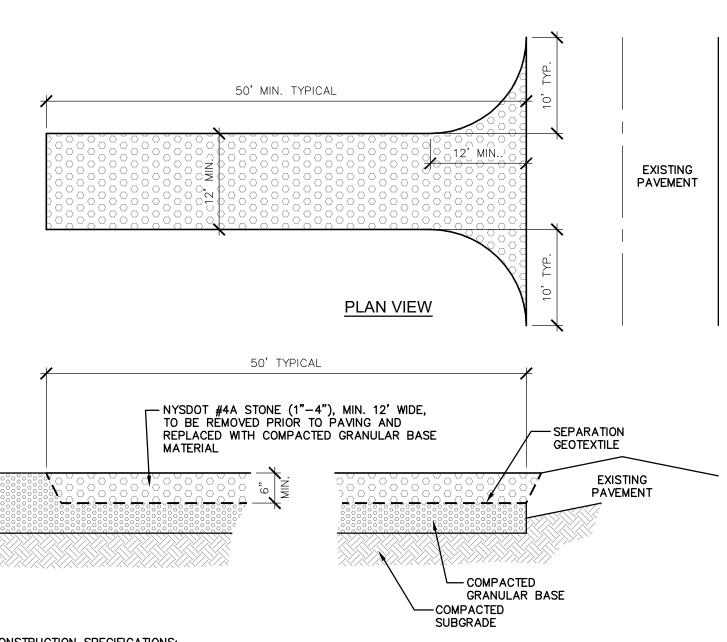
### TYPICAL SILT FENCE DETAIL



**CONSTRUCTION SPECIFICATIONS:** 1. LENGTH - NOT LESS THAN 50 FEET (EXCEPT ON A SINGLE RESIDENCE LOT WHERE A 30 FOOT MINIMUM LENGTH WOULD

- 2. THICKNESS NOT LESS THAN SIX (6) INCHES.
- 3. WIDTH TWELVE (12) FOOT MINIMUM, BUT NOT LESS THAN THE FULL WIDTH AT POINTS WHERE INGRESS OR EGRESS OCCURS. TWENTY-FOUR (24) FOOT IF SINGLE ENTRANCE TO SITE.
- 4. SEPARATION GEOTEXTILE WILL BE PLACED OVER THE ENTIRE AREA PRIOR TO PLACING OF STONE. SEPARATION GEOTEXTILE SHALL MEET THE MINIMUM FOLLOWING REQUIREMENTS:
  - a. 200 LBS, GRAB TENSILE STRENGTH (ASTM D4632) b. 50%, ELONGATION AT FAILURE (ASTM D4632)
  - c. 40-80 SEIVE, APPARENT OPENING SIZE (ASTM D4751)
- 5. SURFACE WATER ALL SURFACE WATER FLOWING OR DIVERTED TOWARD CONSTRUCTION ENTRANCES SHALL BE PIPED ACROSS THE ENTRANCE. IF PIPING IS IMPRACTICAL, A MOUNTABLE BERM WITH 5:1 SLOPES WILL BE PERMITTED.
- MAINTENANCE THE ENTRANCE SHALL BE MAINTAINED IN A CONDITION WHICH WILL PREVENT TRACKING OR FLOWING OF SEDIMENT ONTO PUBLIC RIGHTS-OF-WAY, ALL SEDIMENT SPILLED, DROPPED, WASHED OR TRACKED ONTO PUBLIC RIGHTS-OF-WAY MUST BE REMOVED IMMEDIATELY.
- WHEN WASHING IS REQUIRED, IT SHALL BE DONE ON A AREA STABILIZED WITH STONE AND WHICH DRAINS INTO AN APPROVED SEDIMENT TRAPPING DEVICE.
- 8. PERIODIC INSPECTION AND NEEDED MAINTENANCE SHALL BE PROVIDED AFTER EACH RAIN.


### TYPICAL OFFSITE SEDIMENT TRACKING DETAIL

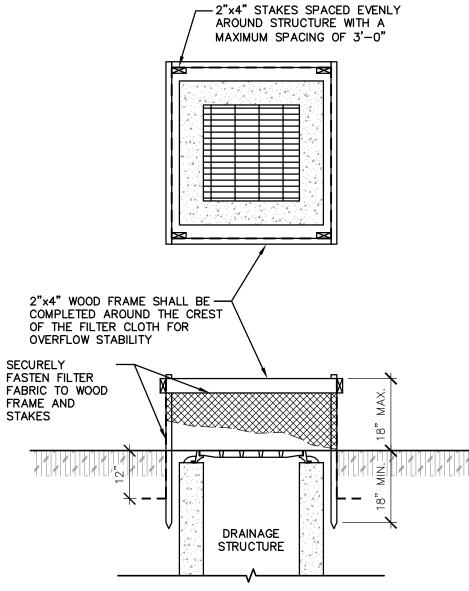

**INSTALLATION NOTES:** 

- 1. FILTER CLOTH TO BE CUT FROM A ROLL TO ELIMINATED JOINTS. IF JOINTS ARE NEEDED THEY WILL BE OVERLAPPED TO THE NEXT STAKE.
- 2. STAKE SHALL BE 2"x4" AND A MINIMUM OF 36" LONG.
- 3. MAINTENANCE SHALL BE PERFORMED AS NEEDED AND MATERIAL REMOVED AT REGULAR INTERVALS.
- 4. FILTER FABRIC SHALL BE NON-WOVEN, MINIMUM CRITERIA OF NYSDOT 737.01C, STRENGTH CLASS 2, DRAINAGE CLASS C OR APPROVED EQUAL
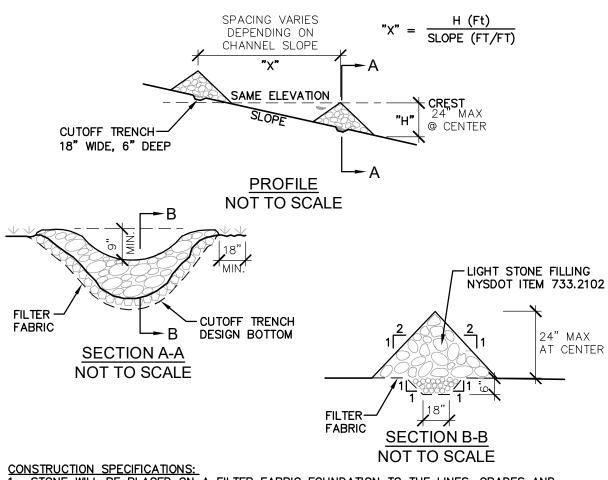
### **?** TYPICAL INLET PROTECTION DETAIL




CONSTRUCTION SPECIFICATIONS:

1. STONE WILL BE PLACED ON A FILTER FABRIC FOUNDATION TO THE LINES, GRADES AND LOCATIONS SHOWN IN THE PLAN.

- 2. SET SPACING OF CHECK DAMS TO ASSUME THAT THE ELEVATIONS OF THE CREST OF THE DOWNSTREAM DAM IS AT THE SAME ELEVATION OF THE TOE OF THE UPSTREAM DAM.
- 3. EXTEND THE STONE A MINIMUM OF 1.5 FEET BEYOND THE DITCH BANKS TO PREVENT CUTTING
- 4. PROTECT THE CHANNEL DOWNSTREAM OF THE LOWEST CHECK DAM FROM SCOUR AND EROSION WITH STONE OR LINER AS APPROPRIATE.
- 5. ENSURE THAT CHANNEL APPURTENANCES SUCH AS CULVERT ENTRANCES BELOW CHECK DAMS
- ARE NOT SUBJECT TO DAMAGE OR BLOCKAGE FROM DISPLACED STONE. MAXIMUM DRAINAGE

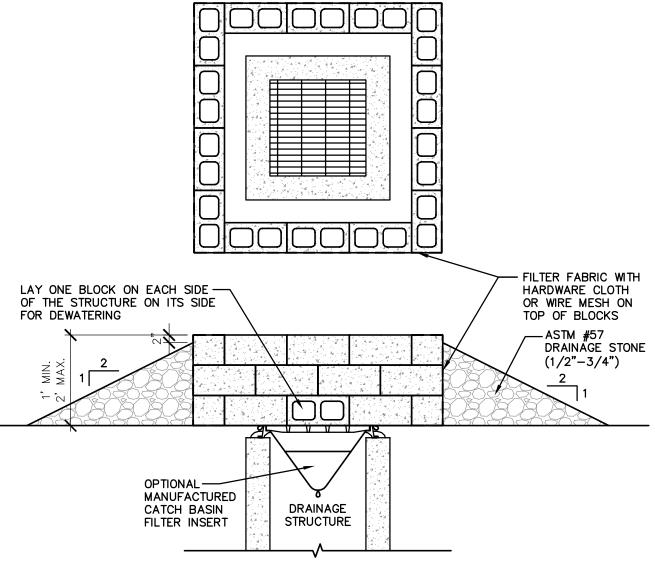TYPICAL STONE CHECK DAM DETAIL



#### **INSTALLATION NOTES:**

- 1. FILTER CLOTH TO BE CUT FROM A ROLL TO ELIMINATED JOINTS.
- 2. MAINTENANCE SHALL BE PERFORMED AS NEEDED AND MATERIAL REMOVED AT REGULAR INTERVALS.
- 3. FILTER FABRIC SHALL BE NON-WOVEN, MINIMUM CRITERIA OF NYSDOT 737.01C, STRENGTH CLASS 2, DRAINAGE CLASS C OR APPROVED
- 4. MANUFACTURED CATCH BASIN INSERT FILTER CAN BE USED INSIDE

### THE STRUCTURE INSTEAD OF USING AN ABOVE GRADE INLET INLET PROTECTION DETAIL

**EROSION AND SEDIMENT CONTROL NOTES:** 

- 1. PRIOR TO COMMENCING ANY CLEARING GRUBBING, EARTHWORK ACTIVITIES, ETC. AT THE SITE, THE CONTRACTOR SHALL FLAG THE WORK LIMITS AND SHALL INSTALL ALL TEMPORARY EROSION AND SEDIMENT CONTROL MEASURES (I.E. SILT FENCES, TREE PROTECTION/BARRIER FENCES, STABILIZED CONSTRUCTION ENTRANCES, STORM DRAIN SEDIMENT FILTERS, DRAINAGE DITCH SEDIMENT FILTERS, ETC.) INDICATED ON THE PROJECT DRAWINGS. TEMPORARY EROSION AND SEDIMENT CONTROL MEASURES MUST BE CONSTRUCTED, STABILIZED, AND FUNCTIONAL BEFORE SITE DISTURBANCE BEGINS WITHIN THEIR TRIBUTARY AREAS, ONCE CONSTRUCTED, ALL MEASURES SHALL BE PROPERLY MAINTAINED AND/OR REPLACED AS NECESSARY AND THEN REMOVED FROM THE SITE ONCE VEGETATION AND PAVEMENT ARE IN PLACE.
- 2. EARTH DISTURBANCE SHALL BE LIMITED TO AREAS WHERE TEMPORARY EROSION AND SEDIMENT CONTROL MEASURES ARE TO BE INSTALLED. ONCE ALL MEASURES ARE INSTALLED TO THE SATISFACTION OF THE
- ENGINEER, THE REMAINDER OF THE CLEARING AND GRADING ACTIVITIES SHALL COMMENCE. 3. ALL EROSION AND SEDIMENT CONTROL MEASURES SHALL BE IN STRICT COMPLIANCE WITH THE "NEW YORK STATE STANDARDS AND SPECIFICATIONS FOR EROSION AND SEDIMENT CONTROL" CURRENT EDITION.
- THE CONTRACTOR SHALL COMPLY WITH THE PROVISIONS OF ALL ENVIRONMENTAL PERMITS ISSUED FOR THIS PROJECT. THESE PLANS REFLECT THE PROVISIONS AND REQUIREMENTS OF SAID PERMIT(S). PERMIT(S) WILL BE AVAILABLE FROM THE ENGINEER-IN-CHARGE PRIOR TO THE START OF CONSTRUCTION.
- CONSTRUCTION IS TO PROCEED IN ACCORDANCE WITH THE CONSTRUCTION PHASING SCHEDULED SUPPLIE BY THE CONTRACTOR OR SHOWN ON THE PLANS. ALL ELEMENTS OF THE SCHEDULE SHALL BE COMPLETED PRIOR TO BEGINNING THE NEXT CONSTRUCTION PHASE. THESE ELEMENTS INCLUDE ALL UTILITY CONSTRUCTION, THE BASE COURSE OF ASPHALT PAVING, AND ESTABLISHING GRASSES ON ALL DISTURBED AREAS. FOR TIME FRAMES OUTSIDE THE GROWING SEASON, OTHER METHODS OF SOIL STABILIZATION (SUCH AS THE USE OF JUTE MESH) SHALL BE USED UNTIL SUCH TIME AS GRASSES CAN BE ESTABLISHED.
- 6. THE CONTRACTOR SHALL INSPECT AND MAINTAIN THE INTEGRITY AND FUNCTION OF ALL TEMPORARY EROSION CONTROL MEASURES THROUGHOUT THE DURATION OF THE DEVELOPMENT PROCESS. TO ASSURE PROPER FUNCTION, SILTATION BARRIERS SHALL BE MAINTAINED IN GOOD CONDITION AND REINFORCED, EXTENDED, REPAIRED OR REPLACED AS NECESSARY. WASHOUTS SHALL BE IMMEDIATELY REPAIRED, RE-SEEDED AND PROTECTED FROM FURTHER EROSION. ALL ACCUMULATED SEDIMENT SHALL BE REMOVED AND CONTAINED IN APPROPRIATE SPOIL AREAS. WATER SHALL BE APPLIED TO NEWLY SEEDED AREAS AS NEEDED UNTIL GRASS COVER IS WELL ESTABLISHED TO EFFECTIVELY CONTROL WIND EROSION. WATER SHALL BE APPLIED TO ALL EXPOSED SOILS AS NECESSARY UNTIL GROUND COVER IS PERMANENTLY ESTABLISHED.
- THE STABILIZED CONSTRUCTION ENTRANCE, UTILIZED DURING CONSTRUCTION, SHALL BE MAINTAINED IN A CONDITION THAT SHALL PREVENT TRACKING OR FLOWING OF SEDIMENT ONTO PUBLIC RIGHTS-OF-WAY. THIS MAY REQUIRE PERIODIC TOP DRESSING WITH ADDITIONAL STONE AS CONDITIONS DEMAND AND REPAIR AND/OR CLEANOUT OF ANY MEASURES USED TO TRAP SEDIMENT. ALL SEDIMENT SPILLED, DROPPED. WASHED, OR TRACKED ONTO PUBLIC RIGHTS-OF-WAY MUST BE REMOVED IMMEDIATELY. WHEELS SHALL BE CLEANED TO REMOVE SEDIMENT PRIOR TO ENTRANCE ONTO PUBLIC RIGHTS-OF-WAY. WHEN WASHING IS REQUIRED, IT SHALL BE DONE ON AN AREA STABILIZED WITH STONE AND WHICH DRAINS INTO AN APPROVED SEDIMENT TRAPPING DEVISE. PERIODIC INSPECTIONS AND NEEDED MAINTENANCE SHALL BE PROVIDED AFTER EACH RAIN EVENT.
- IMMEDIATELY FOLLOWING COMPLETION OF ANY AND ALL STORM DRAIN INLETS, STORM DRAIN INLET PROTECTION SHALL BE CONSTRUCTED. THE INLET PROTECTION SHALL FUNCTION TO PREVENT SEDIMENT FROM ENTERING THE STORM DRAINS, THEY SHALL BE MAINTAINED IN GOOD CONDITION UNTIL FINAL VEGETATIVE COVER IS WELL ESTABLISHED.
- 9. AS MUCH AS IS PRACTICAL, EXISTING VEGETATION SHALL BE PRESERVED. FOLLOWING THE COMPLETION OF CONSTRUCTION ACTIVITIES IN ANY PORTION OF THE SITE, PERMANENT VEGETATION SHALL BE ESTABLISHED
- 10. IN SOME INSTANCES, ESTABLISHING VEGETATION WILL BE NECESSARILY DELAYED WHILE CONSTRUCTION IS IN PROGRESS. DURING THESE TIMES, SEDIMENT CONTROL MEASURES WILL BE EMPLOYED TO PREVENT SEDIMENT FROM LEAVING THE SITE. VEGETATION SHALL BE ESTABLISHED IN THESE AREAS AS SOON AS IT
- 11. SITE PREPARATION ACTIVITIES SHALL BE PLANNED TO MINIMIZE THE SCOPE AND DURATION OF SOIL
- 12. PERMANENT TRAFFIC CORRIDORS SHALL BE ESTABLISHED AND "ROUTES OF CONVENIENCE" SHALL BE AVOIDED. STABILIZED CONSTRUCTION ENTRANCES SHALL BE INSTALLED AT ALL POINTS OF ENTRY ONTO THE PROJECT SITE.
- 13. AREAS UNDERGOING CLEARING OR GRADING AND WHERE WORK IS DELAYED OR COMPLETED AND WILL NOT BE REDISTURBED FOR 21 DAYS OR MORE SHALL BE STABILIZED WITH TEMPORARY OR PERMANENT VEGETATIVE COVER WITHIN 14 DAYS.
- 14. TOPSOIL AND FILL THAT IS TO REMAIN STOCKPILED ON-SITE FOR PERIODS GREATER THAN 30 DAYS SHALL BE STABILIZED BY SEEDING. PRIOR TO THE SEEDING OPERATION, THE STOCKPILED MATERIAL SHALL BE GRADED AS NEEDED AND FEASIBLE TO PERMIT THE USE OF CONVENTIONAL EQUIPMENT FOR SEEDBED PREPARATION, FERTILIZATION, SEEDING, MULCH APPLICATIONS AND MULCH ANCHORING
- 15. SILT FENCES SHALL BE CONSTRUCTED AROUND ALL STOCKPILES OF FILL, TOPSOIL, AND EXCAVATED OVERBURDEN. SILT FENCES SHALL BE ANCHORED AND MAINTAINED IN GOOD CONDITION UNTIL SUCH TIME AS SAID STOCKPILES ARE REMOVED AND STOCKPILING AREAS ARE BROUGHT TO FINAL GRADE AND PERMANENTLY STABILIZED.
- 16. IN NO CASE SHALL ERODIBLE MATERIALS BE STOCKPILED WITHIN 25 FEET OF ANY DITCH STREAM OR OTHER 17. DAMAGE TO SURFACE WATERS RESULTING FROM EROSION AND SEDIMENTATION SHALL BE MINIMIZED BY STABILIZING DISTURBED AREAS AND BY REMOVING SEDIMENT FROM CONSTRUCTION SITE DISCHARGES.
- 18. CONSTRUCTION TRAFFIC SHALL NOT CROSS STREAMS OR DITCHES EXCEPT AT SUITABLE CROSSING FACILITIES, AND SHALL NOT OPERATE UNNECESSARILY WITHIN WATERWAYS OR DRAINAGE DITCHES.
- 19. NO SYNTHETIC EROSION CONTROL MATERIAL, FENCING OR MATTING SHALL BE PART OF THE PERMANENT INSTALLATION.
- 20. WHERE CONCENTRATED FLOWS ARE CREATED AS A RESULT OF CONSTRUCTION OPERATIONS, CHECK DAMS SHALL BE INSTALLED DEEMED NECESSARY.

### SPECIFICATIONS:

- A. TEMPORARY SEED SPECIES: STATE CERTIFIED SEED FROM GRASS SPECIES, AS FOLLOWS: 1. PERENNIAL OR ANNUAL RYEGRASS, 100% (SPRING, SUMMER AND EARLY FALL)
- 2. AROOSTOOK WINTER RYEGRASS, 100% (LATE FALL AND WINTER) B. GRASS/LAWN AREA SEED SPECIES: STATE-CERTIFIED SEED OF GRASS SPECIES, AS FOLLOWS: 1. KENTÚCKY BLUEGRASS: 40%
- 2. TALL FESCUE OR SMOOTH BROMEGRASS: 20%
- 3. CREEPING RED FESCUE: 25% 4. PERENNIAL RYEGRASS: 15% C. WATERWAYS/DRAINAGE CHANNELS SEED SPECIES: STATE-CERTIFIED SEED OF GRASS SPECIES,
- AS FOLLOWS: . PERENNIAL RYE: 60% 2. TALL FESCUE OR SMOOTH BROMEGRASS: 40% 3. REDTOP: 4%

### PLANTING MATERIALS

- A. TOPSOIL: ASTM D 5268, PH RANGE OF 6.5 TO 7.5, A MINIMUM OF 6 PERCENT ORGANIC MATERIAL CONTENT AND A MAXIMUM OF 20 PERCENT; FREE OF STONES 1 INCH (25 MM) OR LARGER IN ANY DIMENSION AND OTHER EXTRANEOUS MATERIALS HARMFUL TO PLANT GROWTH NOT LESS THAN 20 PERCENT FINE TEXTURED MATERIAL C PASSING THE NO. 200 SIEVE, AND NOT MORE THAN 15 PERCENT CLAY: CONTAIN LESS THAN 500 PPM SOLUBLE SALTS
- 1. TOPSOIL SOURCE: REUSE SURFACE SOIL STOCKPILED ON-SITE AND SUPPLEMENT WITH IMPORTED OR MANUFACTURED TOPSOIL FROM OFF-SITE SOURCES WHEN QUANTITIES OR QUALITY
- IS INSUFFICIENT. VERIFY SUITABILITY OF STOCKPILED SURFACE SOIL TO PRODUCE TOPSOIL 2. TOPSOIL SOURCE: AMEND EXISTING IN-PLACE SURFACE SOIL TO PRODUCE TOPSOIL. VERIFY SUITABILITY OF SURFACE SOIL TO PRODUCE TOPSOIL. SURFACE SOIL MAY BE SUPPLEMENTED WITH IMPORTED OR MANUFACTURED TOPSOIL FROM OFF-SITE SOURCES.
- B. INORGANIC SOIL AMENDMENTS: 1. LIME: ASTM C 602, CLASS T OR O, AGRICULTURAL LIMESTONE CONTAINING A MINIMUM 80 PERCENT CALCIUM CARBONATE EQUIVALENT.
- C. ORGANIC SOIL AMENDMENTS 1. COMPOST: WELL-COMPOSTED, STABLE, AND WEED-FREE ORGANIC MATTER, PH RANGE OF 5.5
- 2. PEAT: SPHAGNUM PEAT MOSS, PARTIALLY DECOMPOSED, FINELY DIVIDED OR GRANULAR
- TEXTURE, WITH PH RANGE OF 3.4 TO 4.8 3. PEAT: FINELY DIVIDED OR GRANULAR TEXTURE, WITH PH RANGE OF 6 TO 7.5, CONTAINING PARTIALLY DECOMPOSED MOSS PEAT, NATIVE PEAT, OR REED-SEDGE PEAT AND HAVING
- WATER-ABSORBING CAPACITY OF 1100 TO 2000 PERCENT. 1. COMMERCIAL FERTILIZER: COMMERCIAL-GRADE COMPLETE FERTILIZER OF NEUTRAL CHARACTER, CONSISTING OF FAST- AND SLOW-RELEASE NITROGEN, 50 PERCENT DERIVED FROM NATURAL ORGANIC SOURCES OF UREA FORMALDEHYDE, PHOSPHOROUS, AND POTASSIUM IN THE FOLLOWING COMPOSITION: 1 LB/1000 SQ. FT. (0.45 KG/92.9 SQ. M) OF ACTUAL NITROGEN, 4 PERCENT PHOSPHOROUS, AND 2 PERCENT POTASSIUM, BY WEIGHT.
- 2. SLOW-RELEASE FERTILIZER: GRANULAR OR PELLETED FERTILIZER CONSISTING OF 50 PERCENT WATER-INSOLUBLE NITROGEN, PHOSPHORUS, AND POTASSIUM IN THE FOLLOWING COMPOSITION: 3. COMPOSITION: 20 PERCENT NITROGEN, 10 PERCENT PHOSPHOROUS, AND 10 PERCENT POTASSIUM, BY WEIGHT.
- E. MULCHES: 1. STRAW MULCH: PROVIDE AIR-DRY, CLEAN, MILDEW- AND SEED-FREE, SALT HAY OR THRESHED STRAW OF WHEAT, RYE, OATS, OR BARLEY. PEAT MULCH MAY BE REQUIRED IF SEEDED LAWNS ARE SUBJECT TO HOT, DRY WEATHER OR DRYING WINDS WITHIN 30 DAYS OF PLANTING.
- 2. PEAT MULCH: SPHAGNUM PEAT MOSS, PARTIALLY DECOMPOSED, FINELY DIVIDED OR GRANULAR TEXTURE, WITH PH RANGE OF 3.4 TO 4.8. 3. PEAT MULCH: FINELY DIVIDED OR GRANULAR TEXTURE, WITH PH RANGE OF 6 TO 7.5,
- CONTAINING PARTIALLY DECOMPOSED MOSS PEAT, NATIVE PEAT, OR REED-SEDGE PEAT AND HAVING WATER-ABSORBING CAPACITY OF 1100 TO 2000 PERCENT. 4. COMPOST MULCH: WELL-COMPOSTED, STABLE, AND WEED-FREE ORGANIC MATTER, PH RANGE
- 5. UTILIZE MULCH ANCHORING METHOD OR MATERIAL AS REQUIRED BY NYS STANDARD SPECIFICATIONS FOR EROSION AND SEDIMENT CONTROL. (PEG & TWINE, MULCHING NETTING, WOOD CELLULOSE, TACKIFIER, OR MECHANICAL METHODS)

### EXECUTION

#### LAWN PREPARATION

- A. NEWLY GRADED SUBGRADES: LOOSEN SUBGRADE TO A MINIMUM DEPTH OF 4 INCHES (100 MM). REMOVE STONES LARGER THAN 1 INCH (25 MM) IN ANY DIMENSION AND STICKS, ROOTS, RUBBISH, AND OTHER EXTRANEOUS MATTER AND LEGALLY DISPOSE OF THEM OFF OWNER'S PROPERTY. 1. APPLY SUPERPHOSPHATE FERTILIZER DIRECTLY TO SUBGRADE BEFORE LOOSENING. 2. THOROUGHLY BLEND PLANTING SOIL MIX OFF-SITE BEFORE SPREADING OR SPREAD TOPSOIL APPLY SOIL AMENDMENTS AND FERTILIZER ON SURFACE, AND THOROUGHLY BLEND PLANTING
- 3. SPREAD PLANTING SOIL MIX TO A DEPTH OF 4 INCHES (150 MM) BUT NOT LESS THAN REQUIRED TO MEET FINISH GRADES AFTER LIGHT ROLLING AND NATURAL SETTLEMENT. DO NOT SPREAD IF PLANTING SOIL OR SUBGRADE IS FROZEN, MUDDY, OR EXCESSIVELY WET.
- B. FINISH GRADING: GRADE PLANTING AREAS TO A SMOOTH, UNIFORM SURFACE PLANE WITH LOOSE. UNIFORMLY FINE TEXTURE. GRADE TO WITHIN PLUS OR MINUS 1/2 INCH (13 MM) OF FINISH ELEVATION. ROLL AND RAKE, REMOVE RIDGES, AND FILL DEPRESSIONS TO MEET FINISH GRADES.
- LIMIT FINE GRADING TO AREAS THAT CAN BE PLANTED IN THE IMMEDIATE FUTURE. MOISTEN PREPARED LAWN AREAS BEFORE PLANTING IF SOIL IS DRY. WATER THOROUGHLY AND ALLOW SURFACE TO DRY BEFORE PLANTING. DO NOT CREATE MUDDY SOIL D. RESTORE AREAS IF ERODED OR OTHERWISE DISTURBED AFTER FINISH GRADING AND BEFORE

### TEMPORARY EROSION AND SEDIMENTATION CONTROL

- A. PROVIDE TEMPORARY EROSION AND SEDIMENTATION CONTROL MEASURES TO PREVENT SOIL EROSION AND DISCHARGE OF SOIL-BEARING WATER RUNOFF OR AIRBORNE DUST TO ADJACENT PROPERTIES AND WALKWAYS. ACCORDING TO A SEDIMENT AND EROSION CONTROL PLAN, SPECIFIC TO THE SITE THAT COMPLIES WITH NYS DEC SPDES GENERAL PERMIT FOR STORMWATER
- DISCHARGES FROM CONSTRUCTION ACTIVITY, GP-0-20-001. THE OPERATOR SHALL INITIATE STABILIZATION MEASURES AS SOON AS PRACTICABLE IN PORTIONS OF THE SITE WHERE CONSTRUCTION ACTIVITIES HAVE TEMPORARILY OR PERMANENTLY CEASED. BUT IN NO CASE MORE THEN 14 DAYS AFTER THE CONSTRUCTION ACTIVITY IN THAT PORTION OF THE SITE HAVE TEMPORARILY OR PERMANENTLY CEASED. THIS REQUIREMENT DOES NOT APPLY IN THE FOLLOWING INSTANCES:
- 1. WHERE THE INITIATION OF STABILIZATION MEASURES BY THE 14TH DAY AFTER CONSTRUCTION ACTIVITY TEMPORARILY OR PERMANENTLY CEASED IS PRECLUDED BY SNOW COVER OR FROZEN GROUND CONDITIONS, STABILIZATION MEASURES SHALL BE INITIATED AS SOON AS PRACTICABLE:
- SEED WITHIN 24 HOURS OF DISTURBANCE OR LOOSEN SCARIFY THE SOIL SURFACE PRIOR TO D. SPRING, SUMMER OR EARLY FALL TEMPORARY SEEDING: ANNUAL OR PERENNIAL RYE GRASS AT A RATE OF 30 LBS/AC OR 1.0 LBS/1,000 SF. (PERENNIAL RYE GRASS MUST BE UTILIZED WHERE FINAL GRADING ACTIVITIES WILL NOT BE COMPLETED UNTIL THE FOLLOWING SPRING.)
- RATE OF 100 LBS/AC OR 2.5 LBS/1.000 SF. F. MULCH WITH HAY OR STRAW AT A RATE OF 2 TONS/ACRE (APPROXIMATELY 90 BALES PER ACRE) OR 2 BALES /1,000 SF. MULCH ANCHORING WILL BE REQUESTED WHERE WIND OR AREAS OF WATER ARE OF CONCERN. WOOD FIBER HYDROMULCH OR OTHER SPRAYABLE PRODUCTS APPROVED FOR EROSION CONTROL MAY BE USED IF APPLIED ACCORDING TO MANUFACTURERS SPECIFICATIONS.

E. LATE FALL OR EARLY WINTER TEMPORARY SEEDING: CERTIFIED "AROOSTOOK" WINTER RYE AT A

### PERMANENT SEEDING

- A. SOWING RATES VARY WITH GRASS SPECIES AND MIXTURES. B. SOW SEED AT THE RATE OF 6 LB/1000 SQ. FT. (250 LB/AC).
- C. RAKE SEED LIGHTLY INTO TOP 1/8 INCH (3 MM) OF TOPSOIL, ROLL LIGHTLY, AND WATER WITH
- D. MULCH WITH STRAW AT A RATE OF 2 TONS/ACRE (APPROXIMATELY 90 BALES PER ACRE). MULCH ANCHORING WILL BE REQUESTED WHERE WIND OR AREAS OF WATER ARE OF CONCERN. WOOD FIBER HYDROMULCH OR OTHER SPRAYABLE PRODUCTS APPROVED FOR EROSION CONTROL MAY BE USED IF APPLIED ACCORDING TO MANUFACTURERS SPECIFICATIONS.

### SATISFACTORY LAWNS

UNTIL LAWNS ARE SATISFACTORY.

- A. SATISFACTORY SEEDED LAWN: AT END OF MAINTENANCE PERIOD, A HEALTHY, UNIFORM, CLOSE STAND OF GRASS HAS BEEN ESTABLISHED, FREE OF WEEDS AND SURFACE IRREGULARITIES, WITH COVERAGE EXCEEDING 90 PERCENT OVER ANY 10 SQ. FT. (0.92 SQ. M) AND BARE SPOTS NOT EXCEEDING 5 BY 5 INCHES (125 BY 125 MM.)
- VEGETATION SHALL BE ESTABLISHED AS SOON AFTER CONSTRUCTION AS POSSIBLE TO ENSURE PROTECTION FROM EROSION. IF RILLING OCCURS, REGRADE AND USE FABRIC OR JUTE MESH TO
- C. REESTABLISH LAWNS THAT DO NOT COMPLY WITH REQUIREMENTS AND CONTINUE MAINTENANCE

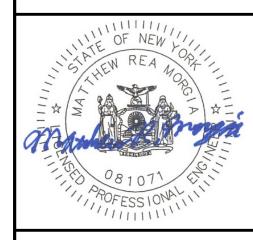
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## OR $\mathbf{C}$ Z V目○ ШS 0 $\mathbf{\Omega}$

PROJECT NO: 2023-052

DRAWN BY: TFT


CHECKED BY: MRM

EROSION AND SEDIMENT CONTROL DETAILS

ISSUE DATES:

04/30/2024 12/13/2024

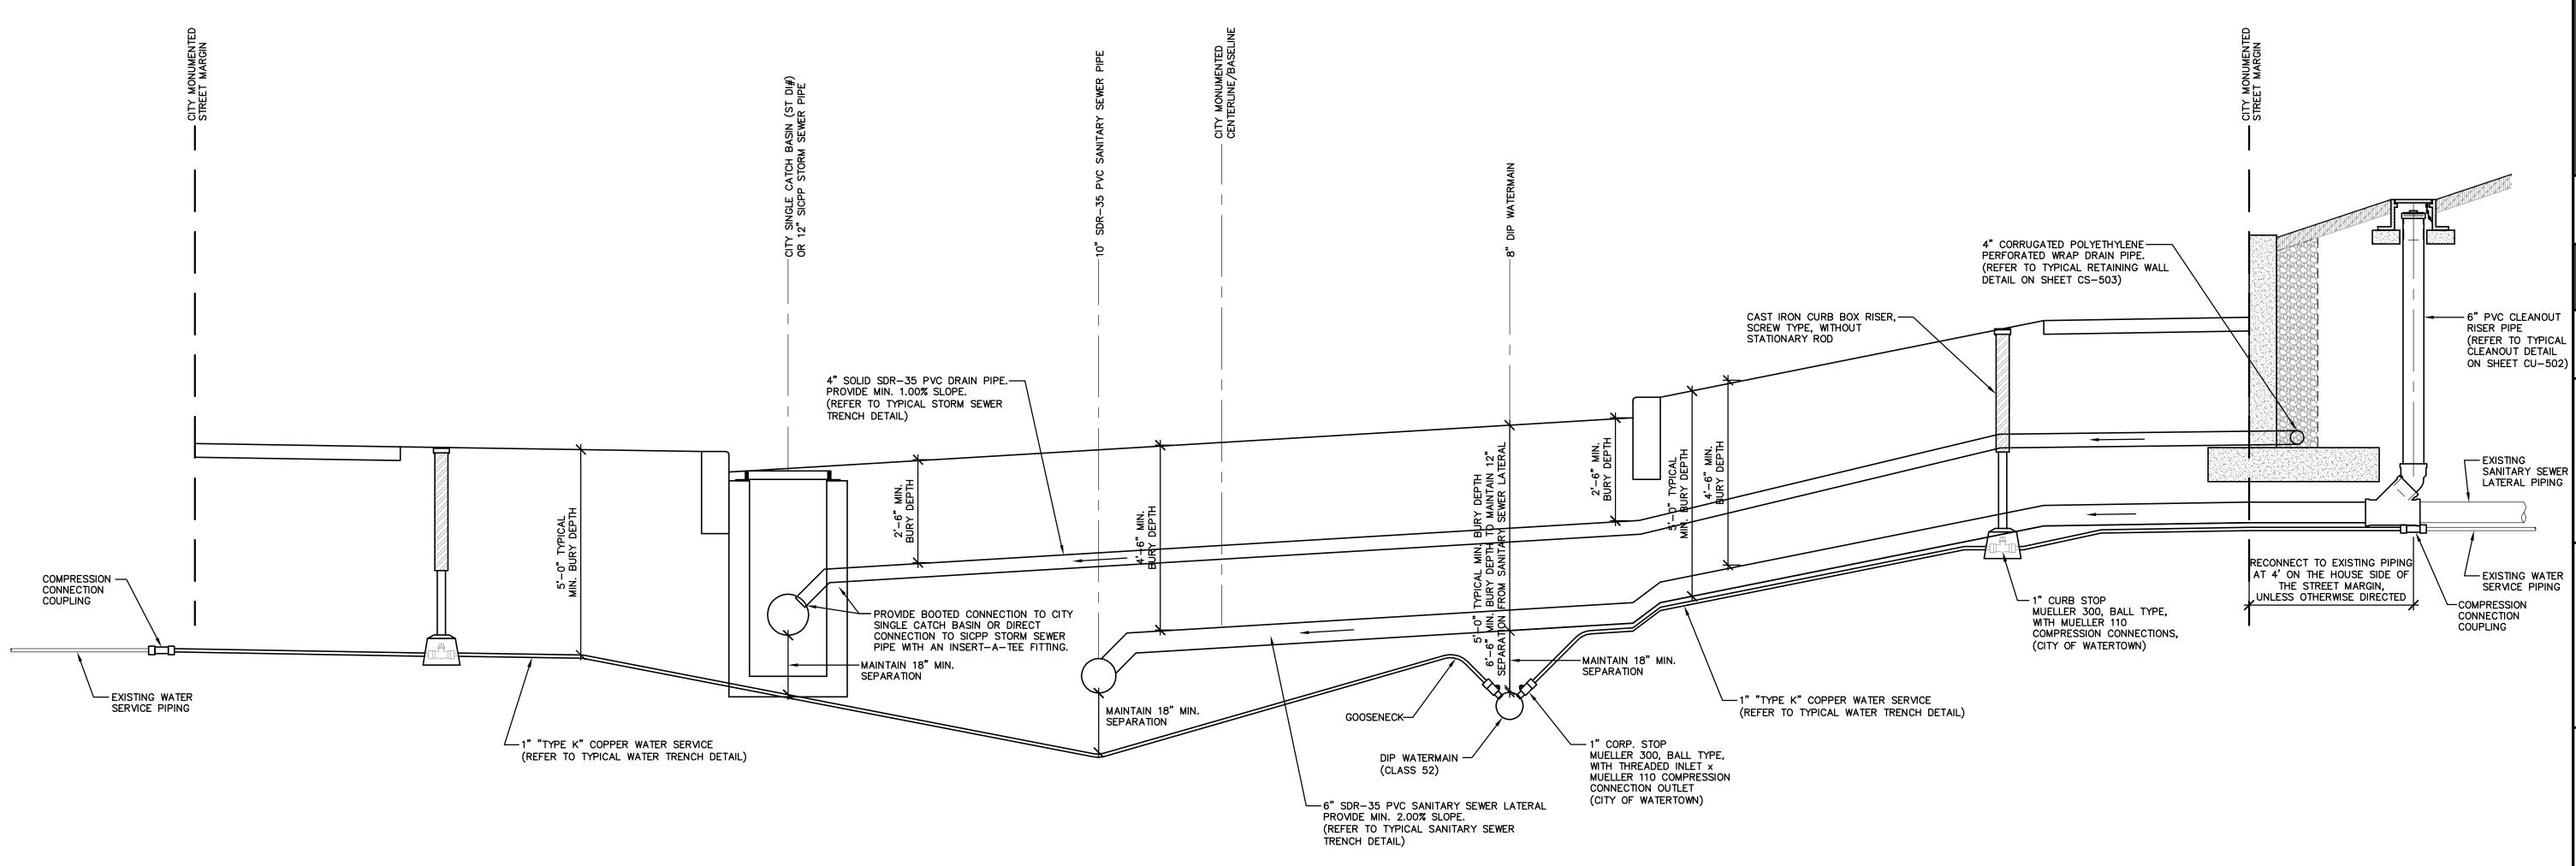12/13/2024 BID DOCUMENTS FOR CONSTRUCTION



1 TYPICAL UTILITIES STREET CROSS SECTION NOT TO SCALE




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YORK

BURLINGTON STREET
RECONSTRUCTION PROJECT
CITY OF WATERTOWN

ROJECT NO: 2023-052

CALE: AS NOTED

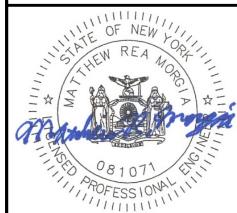
CHECKED BY: N ISSUE DATES: 02/23/2024


TYPICAL UTILITIES STREET CROSS SECTION


**CU-500** 

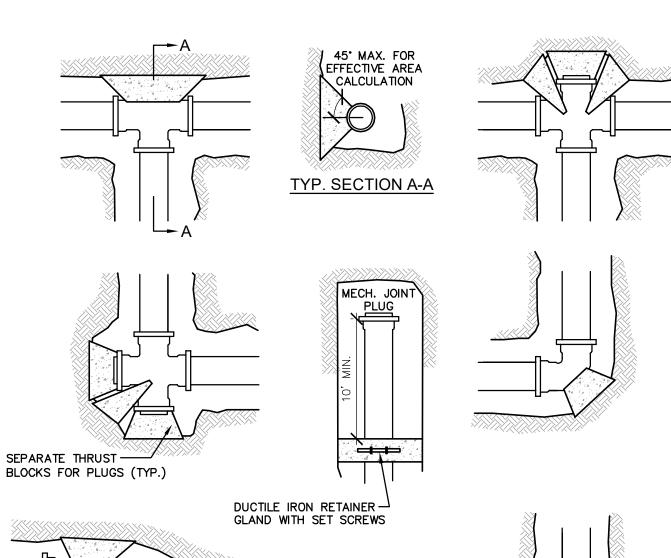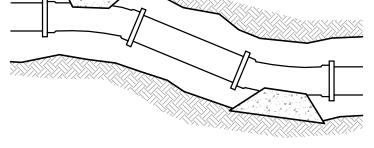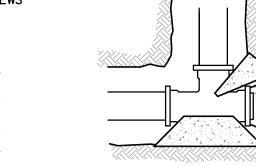- 1. DIMENSIONS 'X' AND 'Y' SHOWN ABOVE SHALL BE DETERMINED BY CONTRACTOR TO COMPLY WITH O.S.H.A., NEW YORK STATE DEPARTMENT OF LABOR, NEW YORK STATE INDUSTRIAL CODE AND ALL OTHER APPLICABLE SAFETY STANDARDS.
- 2. SAFETY SHEETING OR TRENCH BOX MAY BE USED IN PLACE OF SLOPED TRENCH WALLS.
- 3. SHEETING, WHEN REQUIRED, TO BE CUT OFF AT LEAST 5 FEET BELOW STREET AND A MINIMUM OF 1 FOOT ABOVE TOP OF PIPE. WOOD SHEETING DRIVEN BELOW MID-DIAMETER OF THE PIPE SHALL BE LEFT IN PLACE. STEEL SHEETING DRIVEN BELOW MID-DIAMETER MAY BE WITHDRAWN IF APPROVED IN WRITING BY THE ENGINEER. FOR PVC PIPE ALL SHEETING DRIVEN BELOW MID-DIAMETER SHALL BE LEFT IN PLACE.
- 4. TRENCHES LOCATED WITHIN 5' OF ROAD SHOULDERS SHALL BE TREATED THE SAME AS UNDER
- 5. PIPE TO TRENCH WALL DISTANCE MAY BE REDUCED WHEN INSTALLED IN SAWCUT ROCK TRENCH. 6. PROVIDE WARNING TAPE AT ALL UNDERGROUND UTILITIES.
- 7. DUCTILE IRON PIPE SHALL BE CLASS 52 WITH FOUR (4) BRONZE WEDGES PER JOINT.
- 8. COPPER WATER SERVICE PIPING SHALL BE TYPE K, SOFT.

### TYPICAL WATER TRENCH DETAIL NOT TO SCALE








**ANCHOR SCHEDULE** 

				ESSURE AC .S.F. BRNG.	GAINST CAPACITY			STATIC PR 10,000 P.S		
NOMINAL PIPE SIZE	MINIMUM	REQUIRE	D BEARING	G AREA IN	SQ. FT.	MINIMUM	REQUIRE	BEARING	AREA IN	SQ. FT.
	11-1/4° BEND	22-1/2° BEND	45° BEND	90. BEND	PLUG OR TEE	11-1/4° BEND	22-1/2° BEND	45° BEND	90. BEND	PLUG OR TEE
4"	1.0	1.0	1.0	1.9	1.4	1.0	1.0	1.0	1.0	1.0
6"	1.0	1.1	2.1	4.0	2.8	1.0	1.0	1.0	1.0	1.0
8"	1.0	1.9	3.7	6.8	4.8	1.0	1.0	1.0	1.4	1.0
10"	1.4	2.8	5.6	10.3	7.3	1.0	1.0	1.1	2.1	1.5
12"	2.0	4.0	7.9	14.5	10.3	1.0	1.0	1.6	2.9	2.1
14"	2.7	5.4	10.6	19.5	13.8	1.0	1.1	2.1	3.9	2.8
16"	3.5	7.0	13.6	25.2	17.8	1.0	1.4	2.7	5.0	3.6
18"	4.4	8.7	17.1	31.7	22.4	1.0	1.7	3.4	6.3	4.5
20"	5.4	10.7	21.0	38.9	27.5	1.2	2.1	4.2	7.8	5.5
24"	7.7	15.3	30.0	55.5	39.2	1.5	3.1	6.0	11.1	7.8

TYPICAL HORIZONTAL THRUST BLOCK DETAIL
NOT TO SCALE

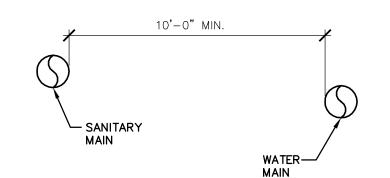
FINISH GRADE




### TYPICAL WATER / SEWER CROSSING HORIZONTAL SEPARATION DETAIL

	WATER MAIN / SANITARY	SEWER DETAIL
CONDITION	SCHEMATIC	REQUIREMENTS
WATER LINE ABOVE SEWER LINE	WATER  IF MORE THAN 18"  SANITARY	A:) WATER LINE AND SEWER LINE PIPE LENGTHS TO BE CENTERED AT CROSSING. PIPE SECTIONS SHALL BE MIN. 20' LONG WITH EACH PIPE JOINTS AT MIN. 10' FROM CROSSING.
WATER LINE ABOVE SEWER LINE	WATER  IF MORE THAN 12" BUT LESS THAN 18"  SANITARY	A:) WATER LINE AND SEWER LINE PIPE LENGTHS TO BE CENTERED AT CROSSING. PIPE SECTIONS SHALL BE MIN. 20' LONG WITH EACH PIPE JOINTS AT MIN. 10' FROM CROSSING.  B:) SEWER LINE TO BE AWWA C900 WATER WORKS GRADE 150 PSI PRESSURE RATED PVC PIPE. PRESSURE TEST TO ENSURE WATER TIGHTNESS OR ENCASE SEWER LINE WITH CONCRETE FOR 10' MIN. EACH SIDE OF CROSSING. 6" MIN. AROUND BELL OF PIPE
SEWER LINE ABOVE WATER LINE	A:) IF MORE THAN 18" B:) IF LESS THAN 18"  WATER	A:) WATER LINE AND SEWER LINE PIPE LENGTHS TO BE CENTERED AT CROSSING. PIPE SECTIONS SHALL BE MIN. 20' LONG WITH EACH PIPE JOINTS AT MIN. 10' FROM CROSSING.  B:) SEWER LINE TO BE AWWA C900 WATER WORKS GRADE 150 PSI PRESSURE RATED PVC PIPE. PRESSURE TEST TO ENSURE WATER TIGHTNESS OR ENCASE SEWER LINE WITH CONCRETE FOR 10' MIN. EACH SIDE OF CROSSING. 6" MIN. AROUND BELL OF PIPE
	CASE SHALL PIPES BE CLOSER THAN 1 ASURED BETWEEN OUTSIDE OF PIPES	2" APART. DISTANCES SHOULD BE

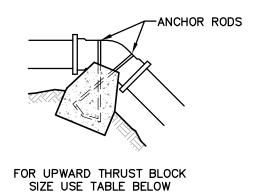TYPICAL WATER / SEWER CROSSING VERTICAL SEPARATION DETAIL
NOT TO SCALE




**ANCHOR SCHEDULE** 

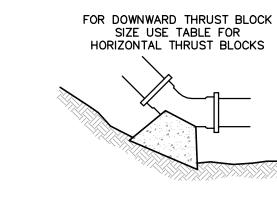


_										
				15	50 P.S.I. H	YDROSTATI	C PRESSU	RE		
I	NOMINAL	11	-1/4° BEN	1D	2	2-1/2° BE	ND		45° BEND	
	PIPE SIZE	CONCRETE VOLUME (CU. YDS.)	ANCHOR ROD (DIA.)	EMBED LENGTH	CONCRETE VOLUME (CU. YDS.)	ANCHOR ROD (DIA.)	EMBED LENGTH	CONCRETE VOLUME (CU. YDS.)	ANCHOR ROD (DIA.)	EMBEI LENGT
ĺ	4"	0.2	3/8"	0.4	3/8"	3/8"	1'-2"	0.4	3/8"	1'-2"
ĺ	6"	0.4	3/8"	0.7	3/8"	3/8"	1'-2"	0.7	3/8"	1'-2"
	8"	0.8	3/8"	1.2	3/8"	3/8"	1'-2"	1.2	3/8"	1'-2"
	10"	0.9	3/8"	1.7	3/8"	3/8"	1'-2"	1.7	3/8"	1'-2"
	12"	1.3	3/8"	2.5	1/2"	3/8"	1'-6"	2.5	1/2"	1'-6"
	14"	1.7	3/8"	3.3	1/2"	3/8"	1'-6"	3.3	1/2"	1'-6"
	16"	2.2	3/8"	4.3	1/2"	3/8"	1'-6"	4.3	1/2"	1'-6"
	18"	2.7	1/2"	5.4	5/8"	1/2"	2'-0"	5.4	5/8"	2'-0"
I			4 /0"		E /0"	4 /0"	-1 -1		F /O"	-1 -1

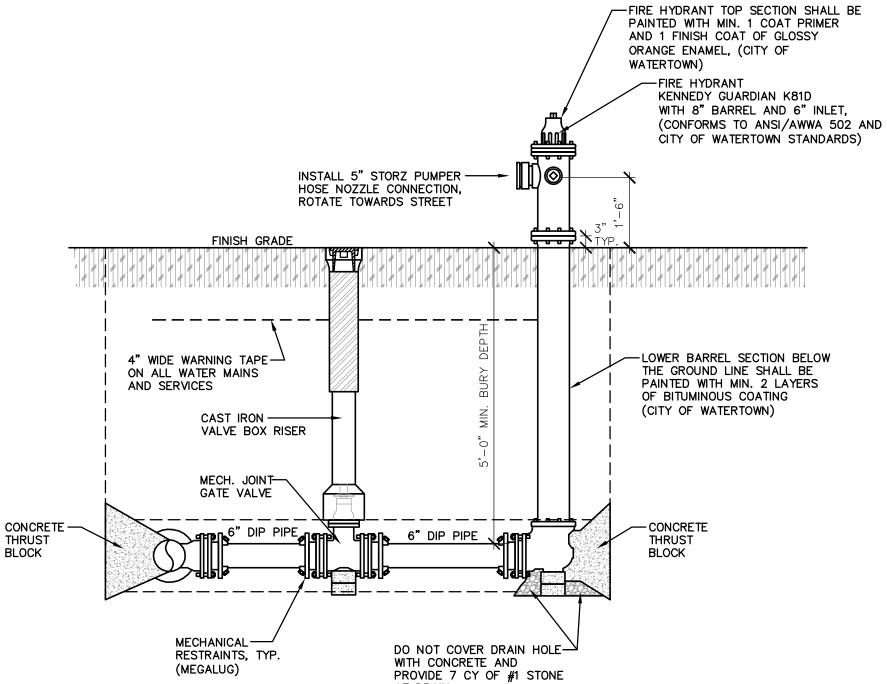5 TYPICAL VERTICAL THRUST BLOCK DETAIL NOT TO SCALE




AT DRAIN **ELEVATION VIEW** 

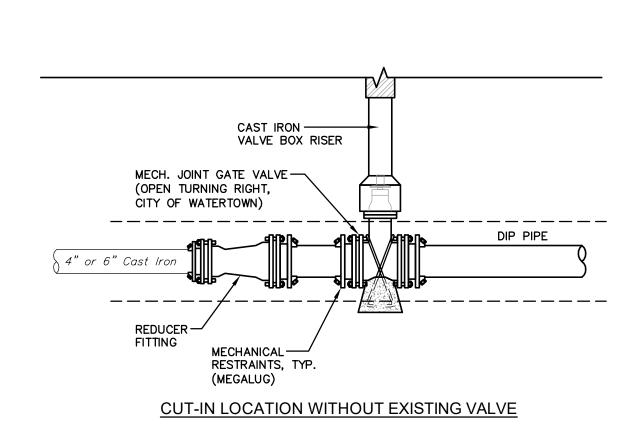


9 TYPICAL CUT-IN VALVE DETAILS
NOT TO SCALE

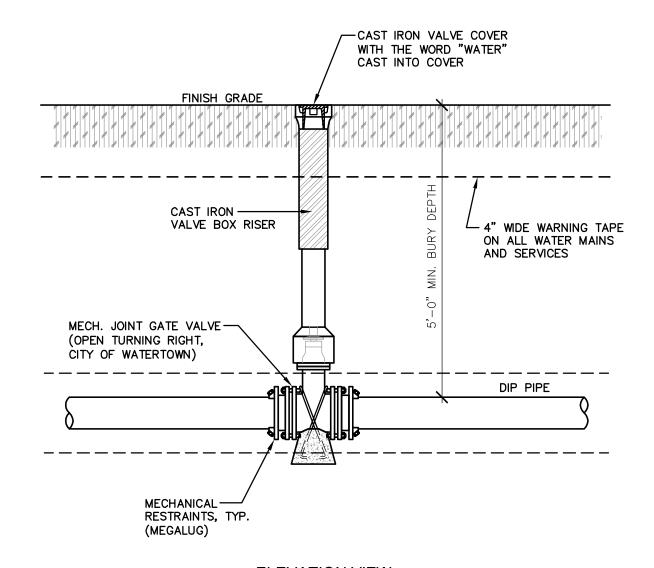
6 TYPICAL FIRE HYDRANT ASSEMBLY DETAIL
NOT TO SCALF



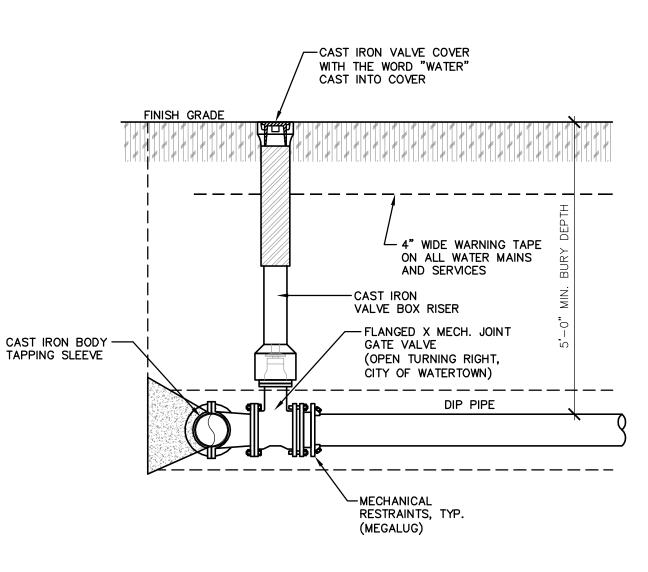
**ELEVATION VIEW** TYPICAL GATE VALVE DETAIL
NOT TO SCALE



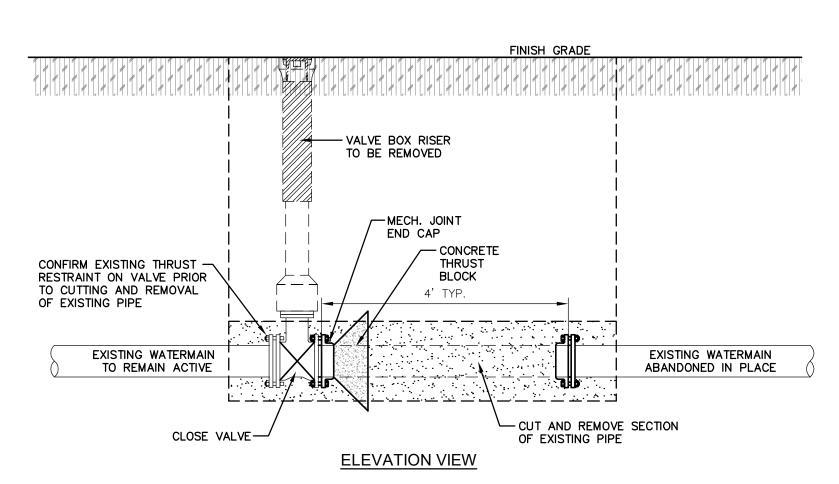**ELEVATION VIEW** 8 TYPICAL TAPPING SLEEVE AND VALVE DETAIL NOT TO SCALE




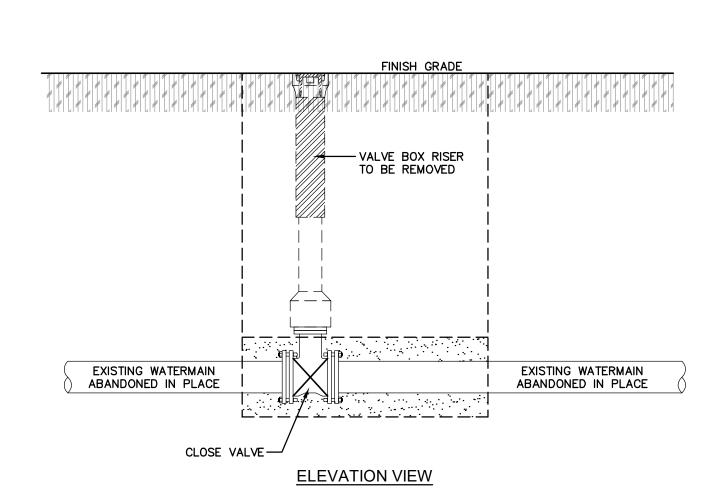CUT AND CAP OF EXISTING WATERMAIN 10 FOR ABANDONMENT OF WATERMAIN DETAIL
NOT TO SCALE



**CLOSE VALVE AND REMOVAL OF RISER** FOR ABANDONMENT OF WATERMAIN DETAIL
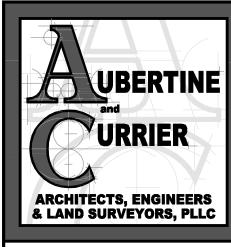
> 12/13/2024 BID DOCUMENTS FOR CONSTRUCTION



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YORK ENGIN JEFFERSON ( RECONS

PROJECT NO: 2023-052 CHECKED BY: MRM

ISSUE DATES: 02/23/2024 04/30/2024 12/13/2024

WATER DETAILS


**CU-501** 

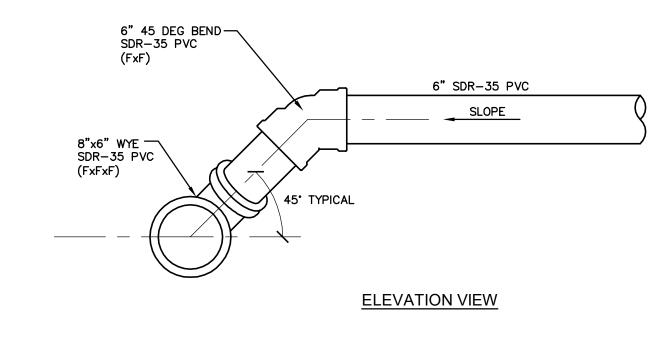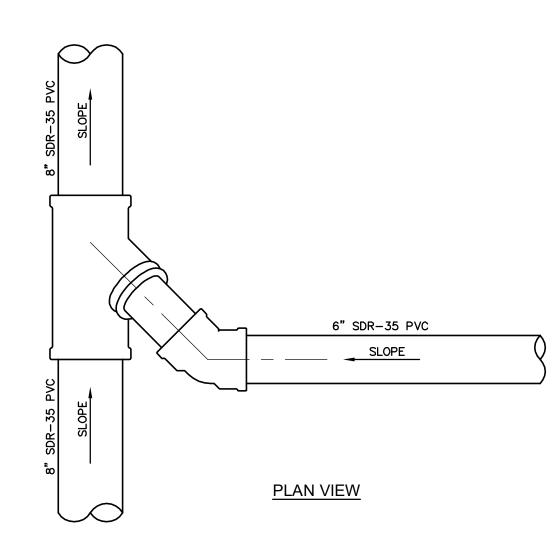
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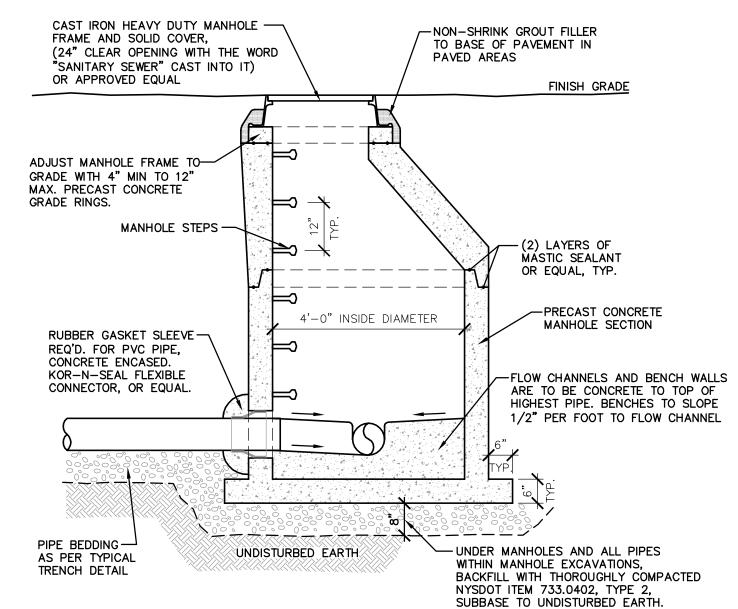
  STEEL SHEETING DRIVEN BELOW MID-DIAMETER MAY BE WITHDRAWN IF APPROVED IN WRITING BY THE ENGINEER. FOR PVC PIPE ALL SHEETING DRIVEN BELOW MID-DIAMETER SHALL BE LEFT IN PLACE.
- 4. TRENCHES LOCATED WITHIN 5' OF ROAD SHOULDERS SHALL BE TREATED THE SAME AS UNDER PAVEMENT.
- 5. PIPE TO TRENCH WALL DISTANCE MAY BE REDUCED WHEN INSTALLED IN SAWCUT ROCK TRENCH.
- 6. PROVIDE WARNING TAPE AT ALL UNDERGROUND UTILITIES.

### TYPICAL SANITARY SEWER TRENCH DETAIL NOT TO SCALE





TYPICAL LATERAL CONNECTION AT SEWER MAIN DETAIL

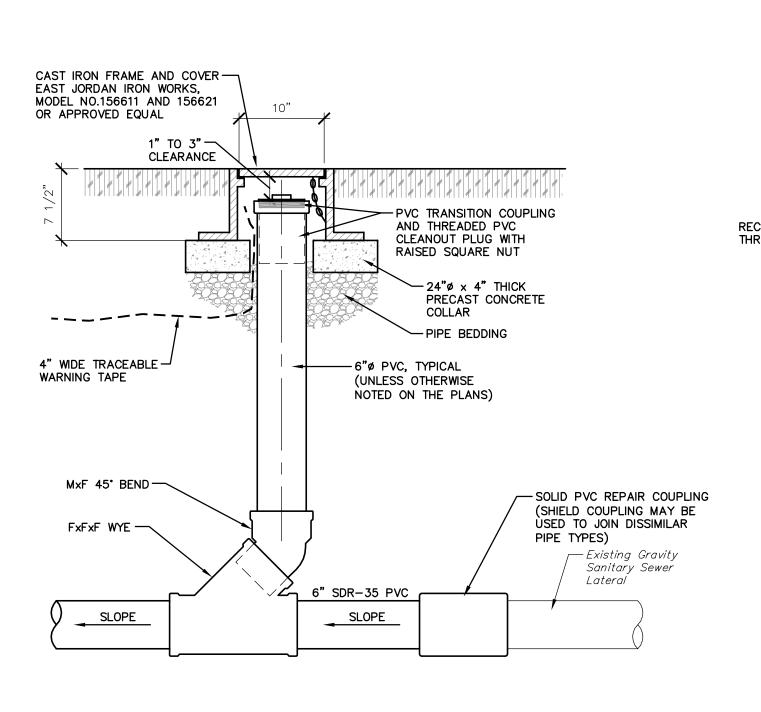


TYPICAL PRECAST SANITARY SEWER MANHOLE NOTES:


8. ALL MANHOLES SHALL BE 4'-0" I.D. UNLESS OTHERWISE NOTED.

- CONCRETE SHALL HAVE A MINIMUM COMPRESSIVE STRENGTH OF 5,000 PSI AT 28 DAYS. CONCRETE SHALL BE AIR ENTRAINED 5%-8%.
- 3. WALLS, FLOOR, TOP SLAB AND ACCESS COVERS SHALL BE DESIGNED IN ACCORDANCE WITH ASTM C890 (HS-20 4. REINFORCEMENT - ASTM A497/A615 GRADE 60.
- . ALL JOINTS SHALL BE SEALED SUCH THAT THE TANK IS WATERTIGHT WITH BUTYL SEALANT CS-102 ASTM C-990. 6. 2 COATS OF BITUMASTIC WATERPROOF COATING TO BE APPLIED TO OUTER SURFACE OF PRECAST CONCRETE
- 7. ALL MANHOLE COVERS SHALL HAVE THE WORDS "SANITARY SEWER" IN 2" LETTERS, CAST IN COVERS.

# 2 TYPICAL SANITARY SEWER MANHOLE DETAIL NOT TO SCALE



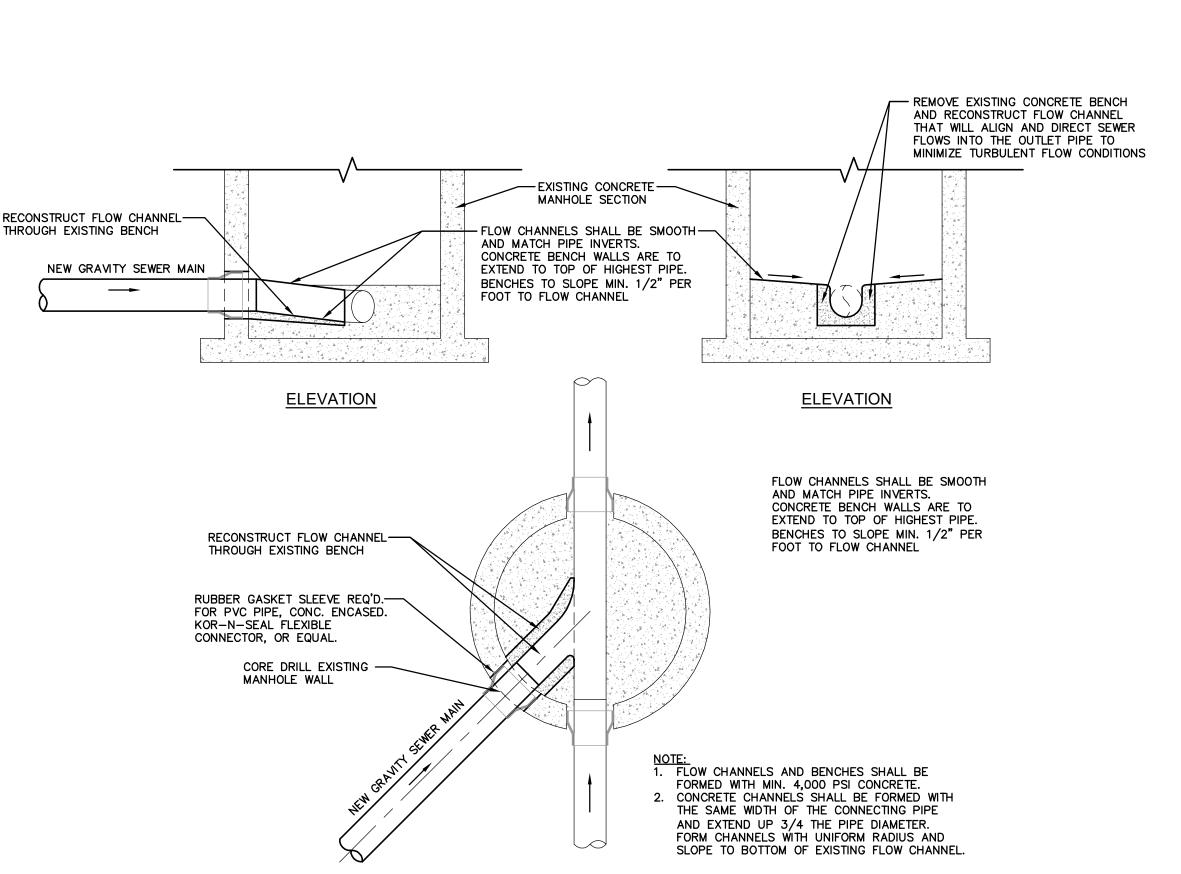**ELEVATION VIEW** TYPICAL CLEANOUT DETAIL
NOT TO SCALE



EXISTING PVC -

GRAVITY

SANITARY SEWER MAIN

24" DIA.

(CLEAR

OPENING)

36" DIA.

CAST IRON HEAVY DUTY MANHOLE

REFER TO PLANS FOR LOCATIONS,

7" HIGH AND 2'-0" CLEAR OPENING

**?** FRAME AND COVER DETAIL

TYPICAL SANITARY SEWER

(THE WORD "SANITARY SEWER"

EAST JORDAN MODEL 104033

EAST JORDAN MODEL 104511

FRAME AND SOLID COVER

SOLID COVER-

CAST INTO IT)

FRAME-

OR APPROVED EQUAL

OR APPROVED EQUAL

**GRAVITY SANITARY SEWER PIPE CONNECTION AT EXISTING SANITARY MANHOLE DETAIL** (ST. MARY STREET)

**PLAN VIEW** 

12/13/2024 BID DOCUMENTS FOR CONSTRUCTION

-PRECAST CONCRETE

FLOW CHANNELS SHALL BE SMOOTH

CONCRETE BENCH WALLS ARE TO

EXTEND TO TOP OF HIGHEST PIPE.

BENCHES TO SLOPE MIN. 1/2" PER

(FARWELL STREET)

AND MATCH PIPE INVERTS.

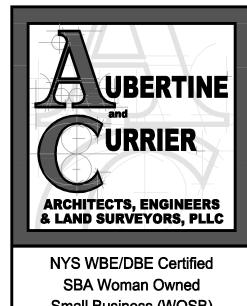
FOOT TO FLOW CHANNEL

SOLID PVC

SANITARY SEWER CUT-IN MANHOLE DETAIL

REPAIR COUPLING

MANHOLE SECTION



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ORK BURLINGTON S ECONSTRUCTIO CITY OF WA ENGINEERING JEFFERSON COUNTY,

PROJECT NO: 2023-052

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DRAWN BY: TFT

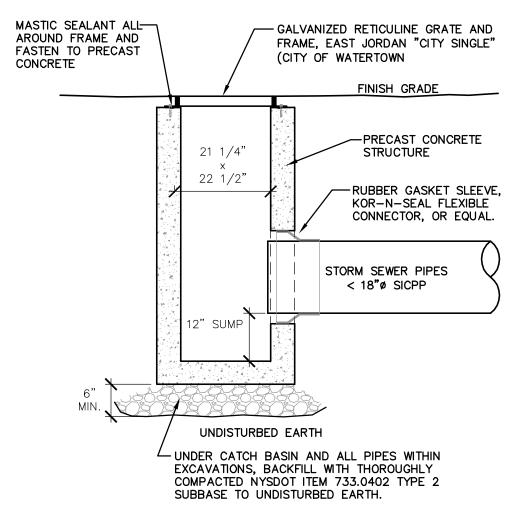
CHECKED BY: MRM 02/23/2024 04/30/2024 12/13/2024

> SANITARY SEWER **DETAILS**

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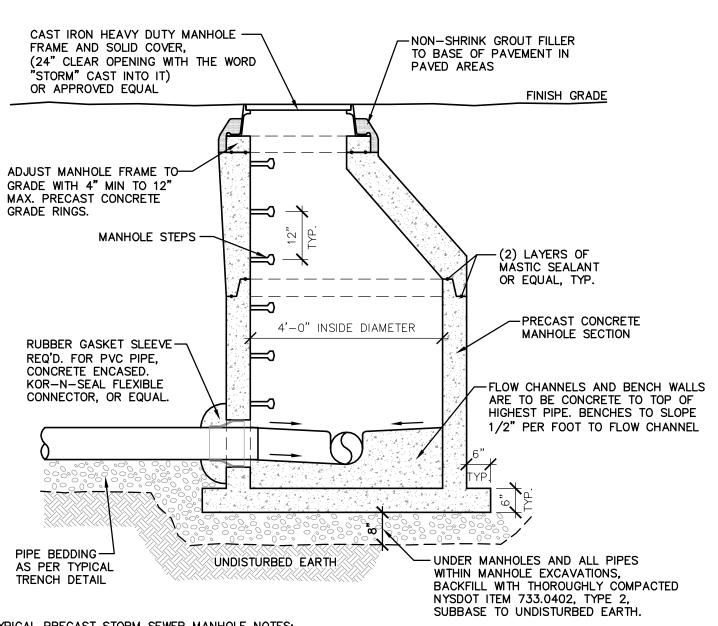
### TYPICAL STORM SEWER TRENCH DETAIL



### TYPICAL PRECAST CATCH BASIN NOTES:

- CONCRETE SHALL HAVE A MINIMUM COMPRESSIVE STRENGTH OF 5,000 PSI AT 28 DAYS. CONCRETE SHALL BE AIR ENTRAINED 5%-8%.
- WALLS, FLOOR, TOP SLAB AND ACCESS COVERS SHALL BE DESIGNED IN ACCORDANCE WITH ASTM C890 AND NYSDOT STANDARD SHEETS 604-5 TO 604-8 (HS-20 LOAD).
- 4. REINFORCEMENT ASTM A497/A615 GRADE 60.
- 5. ALL JOINTS SHALL BE SEALED SUCH THAT THE TANK IS WATERTIGHT WITH BUTYL SEALANT CS-102 ASTM C-990.

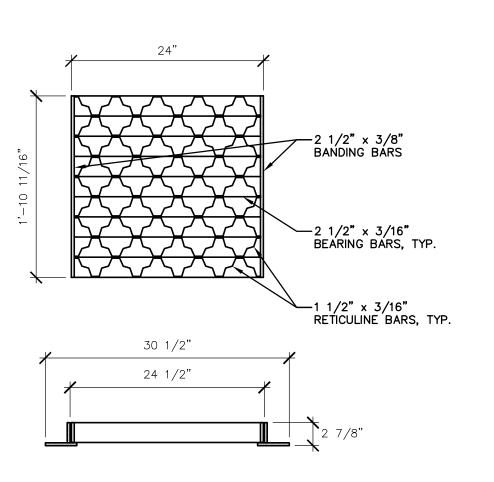
### TYPICAL CITY SINGLE CATCH BASIN DETAIL



TYPICAL PRECAST STORM SEWER MANHOLE NOTES: CONCRETE SHALL HAVE A MINIMUM COMPRESSIVE STRENGTH OF 5,000 PSI AT 28 DAYS.


- . CONCRETE SHALL BE AIR ENTRAINED 5%-8%. 3. WALLS, FLOOR, TOP SLAB AND ACCESS COVERS SHALL BE DESIGNED IN ACCORDANCE WITH ASTM C890 (HS-20
- 4. REINFORCEMENT ASTM A497/A615 GRADE 60.
  5. ALL JOINTS SHALL BE SEALED SUCH THAT THE TANK IS WATERTIGHT WITH BUTYL SEALANT CS—102 ASTM C—990.
  6. 2 COATS OF BITUMASTIC WATERPROOF COATING TO BE APPLIED TO OUTER SURFACE OF PRECAST CONCRETE
- 7. ALL MANHOLE COVERS SHALL HAVE THE WORDS "STORM" IN 2" LETTERS, CAST IN COVERS. 8. ALL MANHOLES SHALL BE 4'-0" I.D. UNLESS OTHERWISE NOTED.

### **7** TYPICAL STORM SEWER MANHOLE DETAIL



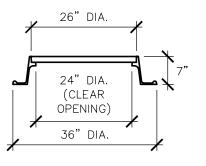
TYPICAL RETICULINE STORM SEWER "CITY SINGLE" FRAME AND GRATE DETAIL
NOT TO SCALE






CAST IRON HEAVY DUTY MANHOLE FRAME AND SOLID COVER REFER TO PLANS FOR LOCATIONS, SOLID COVER-(THE WORD "STORM" CAST INTO IT) EAST JORDAN MODEL 103525 OR APPROVED EQUAL 7" HIGH AND 2'-0" CLEAR OPENING EAST JORDAN MODEL 104511 OR APPROVED EQUAL

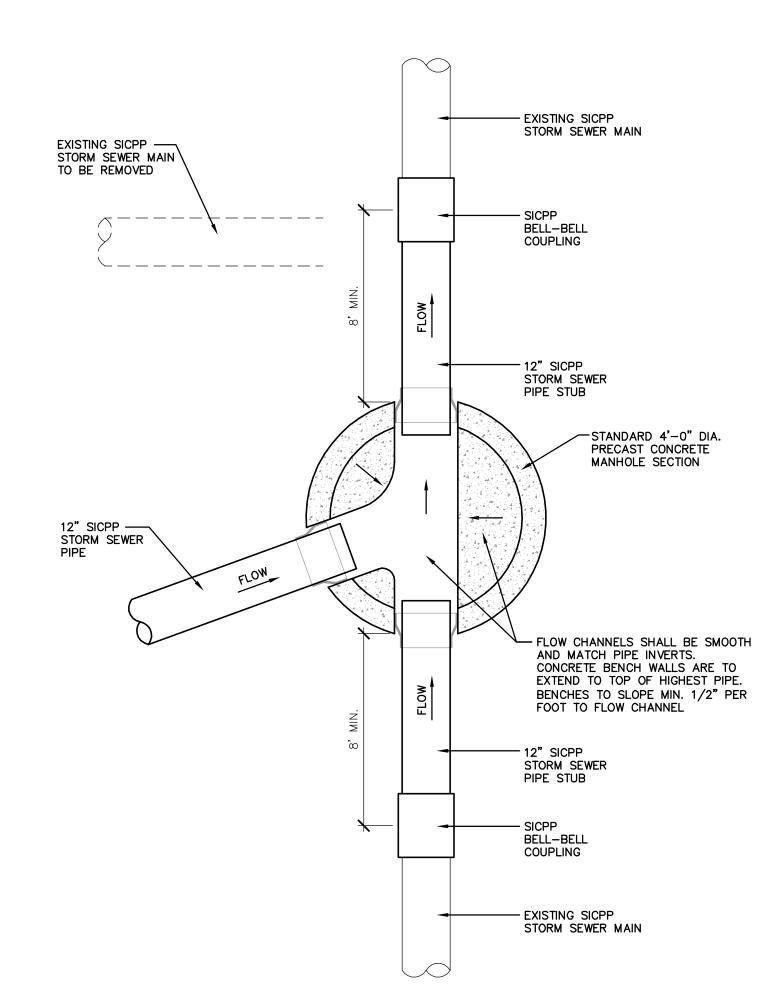
TYPICAL STORM SEWER FRAME AND COVER DETAIL



# STORM SEWER CUT-IN MANHOLE DETAIL NOT TO SCALE (ST. MARY STREET)

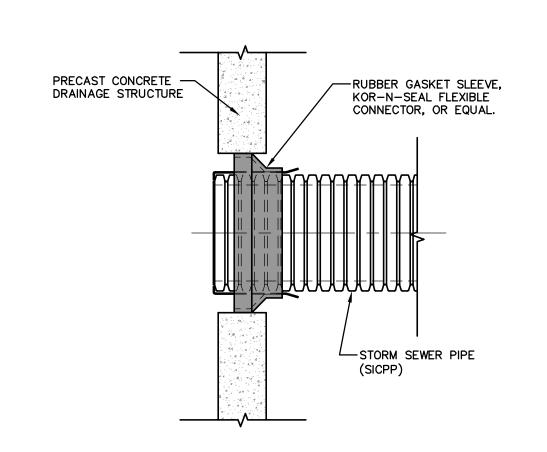


# TYPICAL STORM SEWER CONNECTION DETAIL

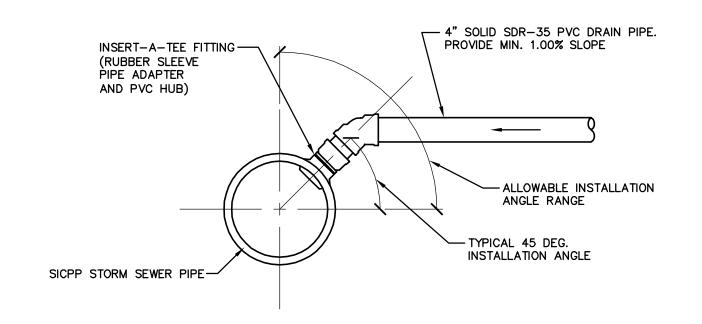

# 8 TYPICAL INSERT-A-TEE CONNECTION DETAIL NOT TO SCALE

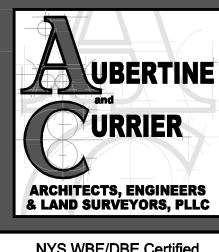12/13/2024 BID DOCUMENTS FOR CONSTRUCTION



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YORK CITY OF W. ENGINEERING JEFFERSON COUNTY, CONS

PROJECT NO: 2023-052 DRAWN BY: TFT

R

CHECKED BY: MRM ISSUE DATES: 02/23/2024 04/30/2024 12/13/2024

> STORM SEWER **DETAILS**

GENERAL NOTES

- THE TYPICAL DETAILS DEPICTED ON THE STANDARD SHEETS AND IN THE MUTCD, REFLECT THE MINIMUM REQUIREMENTS.
- 2. PROPOSED REVISIONS TO THE TRAFFIC CONTROL PLAN SHALL BE PROVIDED, IN WRITING, TO THE DOT ENGINEER FOR REVIEW AND APPROVAL BY THE REGIONAL DIRECTOR OR HIS/HER DESIGNEE FIVE (5) WORK DAYS PRIOR TO THE PLANNED IMPLEMENTATION OF SUCH PROPOSED REVISIONS, EXCEPT FOR CHANGES THAT ALTER THE SCOPE OF THE TRAFFIC CONTROL PLAN. SUCH CHANGES IN SCOPE MUST BE SUBMITTED TO THE ENGINEER FOR APPROVAL BY THE REGIONAL DIRECTOR OR HIS/HER DESIGNEE THIRTY (30) WORKING DAYS PRIOR TO IMPLEMENTATION OF SUCH REVISIONS.
- 3. THE NAMES, ADDRESSES, AND TELEPHONE NUMBERS OF STAFF WHO ARE AUTHORIZED TO SECURE LABOR, MATERIALS, AND EQUIPMENT FOR EMERGENCY REPAIRS OUTSIDE NORMAL WORKING HOURS SHALL BE PROVIDED. IN WRITING, TO THE DOT ENGINEER, THE ENGINEER WILL PROVIDE THE SUBMITTED INFORMATION TO REGIONAL MANAGEMENT, THE NEW YORK STATE POLICE, THE RESIDENT ENGINEER, AND THE LOCAL POLICE.
- 4. STANDARD SHEET 619-503 MAY BE USED FOR AN OFFSITE DETOUR SETUP FOR BOTH LONG TERM AND SHORT TERM WORK DURATIONS.
- 5. FOLLOW REGIONAL HIGH-VOLUME RESTRICTIONS. CONSULT WITH DOT ENGINEER IF
- PLAN AHEAD TO AVOID CONFLICTING WORK ZONES. CHECK FOR CONSTRUCTION PROJECTS, CLOSURES, & RESTRICTIONS AT WWW.511NY.ORG, WWW.DOT.NY.GOV/PROJECTS, AND WITH
- 7. DOCUMENT AND REPORT WORK ZONE INCIDENTS USING EITHER THE DEPARTMENT'S WORK ZONE INCIDENT FORM, OR THE CONSTRUCTION INCIDENT REPORTING SYSTEM, AS APPROPRIATE.
- CONSIDER CLOSURE WIDTH & CLEAR WIDTH FOR WIDE VEHICLES ON WIDE LOAD ROUTES.

### ACTIVITY AREA

- 1. A 500' MINIMUM LONGITUDINAL DISTANCE SHALL BE MAINTAINED BETWEEN CONSTRUCTION OPERATIONS ON ALTERNATE SIDES OF THE ROADWAY, UNLESS OTHERWISE APPROVED BY THE
- 2. WHEN TWO OR MORE AREAS ARE ADJACENT, OVERLAP, OR ARE IN CLOSE PROXIMITY, THE CONTRACTOR SHALL ENSURE THERE ARE NO CONFLICTING SIGNS AND THAT LANE CONTINUITY IS MAINTAINED THROUGHOUT ALL WORK AREAS.

- THE LOCATIONS OF THE SIGNS SHOWN ON THE WORK ZONE TRAFFIC CONTROL PLANS AND DETAILS MAY BE ADJUSTED BASED ON SIGHT DISTANCE AND OTHER CONSIDERATIONS. THE FINAL LOCATIONS OF SIGNS ARE SUBJECT TO APPROVAL OF THE ENGINEER.
- 2. FOR LONG TERM WORK DURATIONS, ANY EXISTING SIGNS, INCLUDING OVERHEAD SIGNS, WHICH CONFLICT WITH THE TEMPORARY TRAFFIC CONTROL SIGN LAYOUT SHALL BE COVERED. REMOVED, STORED OR RESET, AS APPROVED BY THE ENGINEER. ALL APPROPRIATE EXISTING SIGNS SHALL BE RESTORED TO THEIR ORIGINAL CONDITION AND/OR LOCATION UNLESS OTHERWISE REPLACED IN THIS CONTRACT.
- SIGNS AT OR NEAR INTERSECTIONS SHALL BE PLACED SO THAT THEY DO NOT OBSTRUCT A MOTORIST'S LINE OF SIGHT.
- I. SIGNS MOUNTED ON THE MEDIAN OF DIVIDED HIGHWAYS WHERE MEDIAN BARRIER IS IN PLACE MAY BE MOUNTED ON THE BARRIER WITH A SADDLE TYPE BRACKET OR OMMITED WITH THE APPROVAL OF THE DOT ENGINEER. LAYING THE SIGN DOWN IN A HORIZONTAL POSITION IS NOT PERMITTED.
- THE DIMENSIONS OF WORK ZONE TRAFFIC CONTROL SIGNS ARE DESCRIBED IN THE MUTCD. ANY CHANGES TO THE DIMENSIONS SHALL BE APPROVED BY THE REGIONAL DIRECTOR OR BY
- 6. NYR9-12 SHALL BE USED IN PLACE OF NYR9-11 WHEN A REDUCED REGULATORY SPEED LIMIT
- 7. RIGID AND FLEXIBLE "ROLL-UP" SIGNS MAY BE USED FOR MOBILE, SHORT DURATION AND SHORT-TERM STATIONARY WORK, RIGID SIGNS MUST BE MOUNTED AT LEAST 5 FEET ABOVE GRADE (7 FEET WHERE THERE ARE PEDESTRIANS OR PARKED CARS), FLEXIBLE SIGNS SHALL BE MOUNTED AT LEAST ONE FOOT ABOVE GRADE. MESH SIGNS SHALL NOT BE USED. USE RETRO REFLECTORIZED RIGID SIGNS FOR NIGHTTIME WORK.

### CHANNELIZING DEVICES

 WHERE POSSIBLE ALL CHANNELIZING AND GUIDING DEVICES ARE TO BE PLACED SO AS TO PROVIDE A MINIMUM 2' LATERAL CLEARANCE TO THE TRAVELED WAY.

### PUBLIC ACCESS

- PROPERTY OWNERS WHOSE DRIVEWAYS WILL BE MADE INACCESSIBLE SHALL BE NOTIFIED AT LEAST 24 HOURS PRIOR TO RESTRICTING USE OF THE DRIVEWAY. FOR MULTIPLE ACCESS PROPERTIES, AT LEAST ONE DRIVEWAY SHALL BE OPEN AT ALL TIMES. ACCESS SHALL BE RESTORED TO ALL DRIVEWAYS AS SOON AS POSSIBLE.
- 2. SUITABLE RAMPS SHALL BE INSTALLED TO MAINTAIN SMOOTH TRANSITIONS FROM RESIDENTIAL AND COMMERCIAL DRIVEWAYS TO AND FROM THE WORK AREA.

### LANE CLOSURES

- LANE CLOSURES SHALL BE LOCATED TO PROVIDE OPTIMUM VISIBILITY, I.E. BEFORE CURVES AND CRESTS. TO THE EXTENT CONDITIONS PERMIT.
- 2. THE ENGINEER MAY REQUIRE THAT ALL LANES BE RE-OPENED AT ANY TIME IF THE ROUTE IS NEEDED FOR EMERGENCY PURPOSES. THIS COULD INCLUDE INCIDENTS AT LOCATIONS OUTSIDE THE CONTRACT LIMITS.
- ARROW PANELS SHALL BE LEGIBLE CONTINUOUSLY FROM ANY POINT WITHIN THE ROADWAY (INCLUSIVE OF SHOULDERS) FROM 1,500 FEET IN ADVANCE OF THE LANE CLOSURE TAPER TO THE BEGINNING OF THE LANE CLOSURE TAPER.

### LANE WIDTHS

- 1. UNLESS AUTHORIZED BY THE ENGINEER, THE MINIMUM LANE WIDTHS FOR WORK ZONE TRAVEL LANES SHALL BE AS FOLLOWS: FREEWAYS AND/OR EXPRESSWAYS IS 11'. THE MINIMUM LANE WIDTH FOR ALL OTHER TYPES OF ROADWAYS IS 10'.
- 2. A WRITTEN NOTE SHALL BE PROVIDED TO THE ENGINEER, A MINIMUM OF 21 CALENDAR DAYS IN ADVANCE OF PERFORMING ANY WORK THAT RESULTS IN THE REDUCED WIDTH OF AN EXISTING ROADWAY, SO THAT THE ENGINEER MAY NOTIFY THE REGIONAL PERMIT ENGINEER IN A TIMELY MANNER.

#### PROTECTIVE VEHICLES

- 1. A PROTECTIVE VEHICLE IS A LARGE DUMP TRUCK, A LARGE RACK TRUCK OR OTHER VEHICLE HAVING A GROSS WEIGHT OF AT LEAST 24,000 POUNDS. IF THE PROTECTIVE VEHICLE ENCROACHES INTO THE TRAVEL LANE, OR IF IT REMAINS ENTIRELY ON THE SHOULDER OF ANY HIGH SPEED ROAD (45 MPH OR HIGHER). IT SHALL BE EQUIPPED WITH A DEPLOYED TRUCK/TRAILER MOUNTED IMPACT ATTENUATOR (TMIA. SEE TABLE 011-01 ON SHEET 619-11). PROTECTIVE VEHICLES MAY BE LOADED WITH SAND, GRAVEL, OR FINE AGGREGATION AS BALLAST TO ENHANCE THE VEHICLE'S GROSS WEIGHT. ANY BALLAST ADDED TO ENHANCE THE VEHICLE'S GROSS WEIGHT SHALL BE SECURED AS NOT TO BECOME DISLODGED IF
- 2. A PROTECTIVE VEHICLE USED IN A MOVING OPERATION IS REFERRED TO AS A SHADOW
- 3. A PROTECTIVE VEHICLE USED IN A STATIONARY OPERATION IS REFERRED TO AS A BARRIER
- 4. IN A MOVING OPERATION OR A STATIONARY OPERATION THAT OCCUPIES A LOCATION FOR UP TO 1 HOUR. THE OPERATOR SHALL REMAIN IN THE PROTECTIVE VEHICLE WITH THE SAFETY BELT AND HEADREST PROPERLY ADJUSTED, MAINTAIN VEHICLE SPACING, AND KEEP THE WHEELS ALIGNED WITH THE LANE STRIPING. TWO-WAY RADIOS SHOULD BE USED TO COMMUNICATE BETWEEN THE OPERATOR AND THE WORK CREW.
- 5. IN A STATIONARY OPERATION THAT OCCUPIES A LOCATION FOR MORE THAN 1 HOUR, ONCE THE PROTECTIVE VEHICLE HAS BEEN APPROPRIATELY PLACED. IT SHOULD BE UNOCCUPIED. UNOCCUPIED VEHICLE SHALL BE POSITIONED PARALLEL TO TRAFFIC, PARKING BRAKE SET, PLACED IN 2ND GEAR (MANUAL TRANSMISSIONS /ENGINE OFF) OR PARK / NEUTRAL (AUTOMATIC TRANSMISSIONS) AND HAVE THE FRONT WHEELS ALIGNED WITH THE LAND STRIPING AND LANE TO MAINTAIN LANE DISCIPLINE AND TO STAY IN LANE IF STRUCK.
- 6. WHEN A PROTECTIVE VEHICLE IS USED IN ADVANCE OF EITHER MOVING OR STATIONARY OPERATIONS TO DISPLAY SIGN MESSAGES, IT IS REFERRED TO AS AN ADVANCE WARNING VEHICLE. ADVANCED WARNING VEHICLES MAY BE OCCUPIED OR UNOCCUPIED. WHEN SIGNS ARE MOUNTED ON AN ADVANCED WARNING VEHICLE, THEY SHALL NOT OBSTRUCT VISIBILITY OF ANY LIGHTS (TAILLIGHTS OR WARNING LIGHTS) OR SIDE-VIEW MIRRORS ON THE
- 7. NO WORK ACTIVITY, EQUIPMENT, VEHICLES AND/OR MATERIALS SHALL BE LOCATED BETWEEN THE PROTECTIVE VEHICLE AND THE ACTIVE WORK AREA (ROLL AHEAD DISTANCE).
- 8. PROTECTIVE VEHICLES MAY BE REQUIRED IN CONJUNCTION WITH POLICE PRESENCE IN THE WORK ZONE, TO BE INCLUDED IN THE UNIT BID PRICE FOR BASIC WORK ZONE TRAFFIC CONTROL, FOR CAPITOL CONSTRUCTION PROJECTS.
- 9. DIRECT VERBAL COMMUNICATION BETWEEN THE PROTECTIVE VEHICLES AND THE WORK VEHICLE(S) / EQUIPMENT SHALL BE UTILIZED WHERE AVAILABLE.

### WORK DURATION DEFINITIONS

- THERE ARE MAINLY FIVE WORK DURATIONS:
  - A. LONG-TERM IS STATIONARY WORK THAT OCCUPIES A LOCATION MORE THAN 3 CONSECUTIVE DAYS.
  - B. INTERMEDIATE-TERM IS STATIONARY WORK THAT OCCUPIES A LOCATION MORE THAN ONE DAYLIGHT PERIOD UP TO 3 CONSECUTIVE DAYS, OR NIGHTTIME WORK LASTING MORE THAN 1 HOUR.
  - C. SHORT-TERM IS STATIONARY DAYTIME WORK THAT OCCUPIES A LOCATION FOR MORE THAN 1 HOUR WITHIN A SINGLE DAYLIGHT PERIOD.
  - D. SHORT DURATION IS WORK THAT OCCUPIES A LOCATION UP TO 1 HOUR. IT CAN BE PERFORMED DURING THE DAYTIME OR AT NIGHT IN ACCORDANCE WITH NOTES N1 TO N10 NOTES ON NIGHTTIME WORK.
  - E, MOBILE IS WORK THAT MOVES INTERMITTENTLY OR CONTINUOUSLY WHERE THE WORK AT ANY SPECIFIC LOCATION COMPLETES WITHIN 15 MINUTES. IT IS USED FOR VEHICLE BASED OPERATIONS AND DOES NOT INVOLVE WORKERS ON FOOT. IT CAN BE PERFORMED DURING THE DAYTIME OR AT NIGHT IN ACCORDANCE WITH NOTES N1 TO N10 NOTES ON NIGHTTIME WORK.
- SPECIAL OPERATIONS ARE WORK OPERATIONS THAT DO NOT FIT INTO ONE OF THE ABOVE FIVE CATEGORIES. SPECIAL OPERATIONS INCLUDE:
  - A. STOP AND GO OPERATIONS WORK THAT COMPLETES WITHIN 5 MINUTES AND ALLOWS WORKERS ON FOOT.
  - B. OTHER OPERATIONS INCLUDING MOWING, MULCHING/HERBICIDE OPERATIONS. TEMPORARY ROAD/INTERSECTION CLOSURES, ETC.

### ROADWAY TYPE DEFINITIONS

### 1. FREEWAY:

- A. INTERSTATE: INTERREGIONAL HIGH-SPEED, HIGH-VOLUME, DIVIDED FACILITIES WITH COMPLETE CONTROL OF ACCESS.
- B. PARKWAY: DIVIDED HIGHWAYS FOR NON-COMMERCIAL TRAFFIC WITH FULL CONTROL OF ACCESS, GRADE PARKWAY SEPARATIONS, INTERCHANGES, AND OCCASIONAL AT-GRADE INTERSECTIONS. PARKWAYS ARE DESIGNATED BY LAW.

### ROADWAY TYPE DEFINITIONS (CONTINUED)

2. EXPRESSWAY: DIVIDED HIGHWAYS FOR THROUGH TRAFFIC WITH FULL OR PARTIAL CONTROL OF ACCESS AND GENERALLY WITH GRADE SEPARATIONS AT MAJOR CROSSROADS, ALL FREEWAY STANDARD SHEETS ARE APPLICABLE TO EXPRESSWAY.

### 3. NON-FREEWAY:

- A. MULTILANE DIVIDED HIGHWAY
- B. MULTILANE UNDIVIDED HIGHWAY
- C. TWO-LANE TWO-WAY ROADWAY
- ALL NON-FREEWAYS CAN BE EITHER URBAN OR RURAL:

URBAN: (MEETS MORE THAN 1 OF THE FOLLOWING CRITERIA) \*HIGH DENSITY DEVELOPMENT \*ON-STREET PARKING \*VARIED BUILDING SETBACKS \*MULTI-STORY AND LOW-TO MEDIUM-RISE STRUCTURES FOR RESIDENTIA \*COMMERCIAL, AND EDUCATIONAL USES, STRUCTURES THAT ACCOMMODATE MIXED USES: COMMERCIAL, RESIDENTIAL, AND PARKING

\*LIGHT INDUSTRIAL, AND SOMETIMES HEAVY INDUSTRIAL, LAND USE \*PROMINENT DESTINATIONS WITH SPECIALIZED STRUCTURES, E.G., LARGE THEATERS, SPORTS FACILITIES OR CONFERENCE CENTERS \*HIGH LEVELS OF PEDESTRIAN AND BICYCLIST ACTIVITY, WITH NEARLY CONTINUOUS SIDEWALKS AND MARKED CROSSWALKS

\*HIGHER DENSITY OF TRANSIT STOPS AND ROUTES \*DRIVEWAY DENSITIES GREATER THAN 25 DRIVEWAYS/MILE ON EACH SIDE OF THE \*MINOR COMMERCIAL DRIVEWAY DENSITIES OF 10 DRIVEWAYS/MILE OR GREATER

\*MAJOR COMMERCIAL DRIVEWAYS \*HIGH DENSITY OF CROSS STREETS

#### RURAL: DOES NOT MEET MORE THAN ONE OF THE ABOVE CRITERIA.

#### NOTES FOR NIGHTTIME OPERATIONS:

- N1. WORK OCCURRING AFTER SUNSET AND BEFORE SUNRISE WILL BE CONSIDERED NIGHTTIME
- N2. ALL SIGNS, STOP/SLOW PADDLES AND RED FLAGS USED TO WARN/ALERT/CONTROL TRAFFIC SHALL BE RETROREFLECTIVE.
- N3. ALL WORKERS INVOLVED SHALL WEAR PROTECTIVE HELMETS AND NIGHTIME APPAREL IN ACCORDANCE WITH §107-05A. HIGH VISIBILITY APPAREL AT ALL TIMES.
- N4. VEHICLES OPERATING ON THE PAVEMENT OF A CLOSED ROADWAY OR TRAVEL LANE SHALL DISPLAY ROTATING AMBER BEACONS OR FLASHING LED BEACONS AT ALL TIMES.
- N5. LEVEL I ILLUMINATION SHALL BE PROVIDED NEAR THE BEGINNING OF LANE CLOSURE TAPERS AND AT ROAD CLOSURES, INCLUDING THE SETUP AND REMOVAL OF THE CLOSURE
- N6. LEVEL II ILLUMINATION SHALL BE PROVIDED FOR FLAGGING STATIONS, ASPHALT PAVING, MILLING, AND CONCRETE PLACEMENT AND/OR REMOVAL OPERATIONS, INCLUDING BRIDGE DECKS, 50 FEET AHEAD OF AND 100 FEET BEHIND A PAVING OR MILLING MACHINE.
- N7. LEVEL III ILLUMINATION SHALL BE PROVIDED FOR PAVEMENT OR STRUCTURAL CRACK FILLING, JOINT REPAIR, PAVEMENT PATCHING AND REPAIRS, INSTALLATION OF SIGNAL EQUIPMENT OR OTHER ELECTRICAL/MECHANICAL EQUIPMENT, AND OTHER TASKS INVOLVING FINE DETAILS OR INTRICATE PARTS AND EQUIPMENT.
- NB. ALL LIGHTING SHALL BE DESIGNED, INSTALLED, AND OPERATED TO AVOID GLARE THAT AFFECTS TRAFFIC ON THE ROADWAY OR THAT CAUSES ANNOYANCE OR DISCOMFORT FOR RESIDENCES ADJOINING THE ROADWAY.
- N9. PRIOR TO THE START OF NIGHTTIME OPERATIONS, A WRITTEN NIGHTTIME OPERATIONS AND LIGHTING PLAN IS REQUIRED FOR APPROVAL FROM THE DOT ENGINEER.
- N10. SEE STANDARD SPECIFICATIONS §619 FOR ADDITIONAL REQUIREMENTS AND CONSIDERATIONS.





RobertLimoges ROBERT LIMOGES, P.E.

DIRECTOR, OTSM

619-010

DRAWN BY: TFT CHECKED BY: MRM ISSUE DATES:

> WORK ZONE TRAFFIC CONTROL SHEETS

Department of **Transportation** U.S. CUSTOMARY STANDARD SHEET WORK ZONE TRAFFIC CONTROL **GENERAL NOTES** APPROVED APRIL 8, 2022 ISSUED UNDER EI 22-008

12/13/2024 BID DOCUMENTS FOR CONSTRUCTION

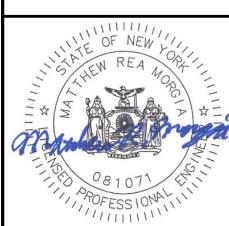


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PROJECT NO: 2023-052

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							T	TABLE 011-01	: PROTEC	TIVE VEHI	CLE REQU	IREMENTS									
CLOSURE TYPE	DURATION	CONTINUOUS LOCATI	THAT MOVE SLY, WHERE ON COMPLET ES "STOP A	MOBILE ES INTERMITTENT THE WORK AT AL TES WITHIN 15 M ND GO OPERATION ES OR LESS	NY SPECIFIC INUTES)	(WORK THA	AT OCCUPIES	T DURATION S A LOCATION FO HOUR)	R UP TO 1	(DAYTIME MORE THA	WORK THAT AN 1 HOUR V	ORT TERM OCCUPIES A LOC WITHIN A SINGLE PERIOD)	ATION FOR DAYLIGHT	ONE DAY	IAT OCCUPIE 'LIGHT PERIO OR NIGHT TI	EDIATE TERM S A LOCATION M OD UP TO 3 CON ME WORK LASTIN N 1 HOUR)	SECUTIVE	(WORK T	HAT OCCUPIE	NG TERM ES A LOCATION F INSECUTIVE DAYS	
	ROAD TYPE & SPEED	FREEWAY		NON-FREEW	AY	FREEWAY		NON-FREEW	AY	FREEWAY		NON-FREEW	/AY	FREEWAY		NON-FREEW	IAY	FREEWAY		NON-FREEW	AY
	ROAD TIPE & SPEED	FREEWAI	≥ 45 MPH	35 - 40 MPH	≤ 30 MPH	FILLHAI	≥ 45 MPH	35 - 40 MPH	≤ 30 MPH	FREEWAI	≥ 45 MPH	35 - 40 MPH	≤ 30 MPH	FILEMAI	≥ 45 MPH	35 - 40 MPH	≤ 30 MPH	FREEMAI	≥ 45 MPH	35 - 40 MPH	≤ 30 MPH
	EXPOSURE CONDITIONS <sup>1</sup>																				1
LANE CLOSURE OR	WORKERS ON FOOT OR VEHICLE EXPOSED TO TRAFFIC	P, TMIA	P, TMIA	P, TMIA	Р	P, TMIA	P, TMIA	P, TMIA	Р	P, TMIA	P, TMIA	P, TMIA	P	P, TMIA	P, TMIA	P, TMIA	SEE NOTE 2	P, TMIA	P, TMIA	P, TMIA	SEE NOTE 2
ENCROACHMENT	OTHER HAZARDS NO WORKERS EXPOSED	NA	NA	NA	NA	P, TMIA	P, TMIA	P	Р	P, TMIA	P, TMIA	Р	SEE NOTE 2	P, TMIA	P, TMIA	SEE NOTE 2	SEE NOTE 2	P, TMIA	P, TMIA	SEE NOTE 2	SEE NOTE 2
SHOULDER CLOSURE	WORKERS ON FOOT OR VEHICLE EXPOSED TO TRAFFIC	P, TMIA	P, TMIA	Р	Р	P, TMIA	P, TMIA	Р	Р	P, TMIA	P, TMIA	Р	Р	P, TMIA	P, TMIA	SEE NOTE 2	SEE NOTE 2	P, TMIA	P, TMIA	SEE NOTE 2	SEE NOTE 2
OR ENCROACHMENT	OTHER HAZARDS NO WORKERS EXPOSED	NA	NA	NA	NA	P, TMIA	P, TMIA	Р	Р	P, TMIA	P, TMIA	Р	SEE NOTE 2	P, TMIA	SEE NOTE 2	SEE NOTE 2	SEE NOTE 2	P, TMIA	SEE NOTE 2	SEE NOTE 2	SEE NOTE 2

NOTES
1. THE EXPOSURE CONDITIONS ASSUMES THERE IS NO POSITIVE PROTECTION PRESENT
2. EITHER A PROTECTIVE VEHICLE OR THE STANDARD BUFFER SPACE SHALL BE PROVIDED

LEGEND
P: PROTECTIVE VEHICLE REQUIRED FOR EACH CLOSED LANE & EACH CLOSED PAVED SHOULDER 8' OR WIDER, IF
THE WORK SPACE MOVES WITHIN THE STATIONARY CLOSURE, THE PROTECTIVE VEHICLE SHALL BE REPOSITIONED REQUIRED

MOCOUNTINGE I				
TMIA: TRUCK/TRAILER	MOUNTED	IMPACT	ATTENUATOR	(TMTA)
	MODITIES	THE LIGHT	ATTEMOSTICAL.	1 2 20147 37
NA: NOT APPLICABLE				

				TABLE 011-0	)2: TAPER LE	NGTHS & NUM	BER OF CONE	S CHART				
PRECONSTRUCTION				TAPER LENGTH	: L (FT.)/ # OF	SKIP LINES/ # (	OF CHANNELIZING	DEVICES		(FT.)/ <sup>‡</sup>	ER TAPER LENGT * OF SKIP LINES ANNELIZING DEVI	/ # 0F
POSTED SPEED				l	LATERAL SHIFT (	OF TRAFFIC FLOW	PATH (FT.)			F0	R SHOULDER WID	TH
LIMIT (MPH)	4	5	6	7	8	9	10	11	12	≤ 4 FT.	5 - 7 FT.	≥8 FT.
25	40/1/2	80/2/3	80/2/3	80/2/3	80/2/3	120/3/4	120/3/4	120/3/4	120/3/4	40/1/2	40/1/2	40/1/2
30	80/2/3	80/2/3	80/2/3	120/3/4	120/3/4	160/4/5	160/4/5	160/4/5	200/5/6	40/1/2	40/1/2	40/1/2
35	80/2/3	120/3/4	120/3/4	160/4/5	160/4/5	200/5/6	200/5/6	240/6/7	240/6/7	40/1/2	40/1/2	80/2/3
40	120/3/4	160/4/5	160/4/5	200/5/6	240/6/7	240/6/7	280/7/8	320/8/9	320/8/9	40/1/2	80/2/3	80/2/3
45	200/5/6	240/6/7	280/7/8	320/8/9	360/9/10	400/10/11	440/11/12	520/13/14	560/14/15	80/2/3	80/2/3	120/3/4
50	200/5/6	240/6/7	320/8/9	360/9/10	400/10/11	440/11/12	520/13/14	560/14/15	600/15/16	80/2/3	120/3/4	160/4/5
55	240/6/7	280/7/8	320/8/9	400/10/11	440/11/12	520/13/14	560/14/15	600/15/16	680/17/18	80/2/3	120/3/4	160/4/5
60	240/6/7	320/8/9	360/9/10	440/11/12	480/12/13	560/14/15	600/15/16	680/17/18	720/18/19	80/2/3	120/3/4	160/4/5
65	280/7/8	320/8/9	400/10/11	480/12/13	520/13/14	600/15/16	640/16/17	720/18/19	800/19/20	80/2/3	160/4/5	200/5/6
. THIS TABLE MAC O	OCATED WITH DE	CCDENCE TO LUC	TOD TABLE OU A	·	·				·			

\* THIS TABLE WAS CREATED WITH REFERENCE TO MUTCD TABLE 6H-4.
\*\* THE NUMBER OF CHANNELIZING DEVICES SHOWN IS CALCULATED BASED ON A 40FT DEVICE SPACING. THE NUMBER OF CHANNELIZING DEVICES CAN BE ADJUSTED AS NECESSARY.

	011-03 BUFFER SPACE
PRECONSTRUCTION POSTED SPEED LIMIT (MPH)	DISTANCE (FT.)/ * OF SKIP LINES
25	155 / 4
30	200 / 5
35	250 / 6
40	305 / 8
45	360 / 9
50	425 / 11
55	495 / 13
65	645 / 16
* THIS TABLE IS THE TABLE 6C-2.	SAME AS MUTCD


TABLE 011-	-04: ROLL AHI	EAD DISTANCE FO	OR PROTECTIVE	VEHICLES
ROLL	AHEAD DISTANC	E (FT.)/# OF SKIP LI	INES FOR VEHICLES	S
PRECONSTRUCTION	(BASED ON	PERATION PROTECTIVE D OF 15 MPH)	STATIONAR	Y OPERATION
POSTED SPEED LIMIT (MPH)	MIN	MAX	MIN	MAX
≥ 55	200/5	280/7	120/3	200/5
45 - 50	160/4	240/6	80/2	160/4
≤ 40	120/3	200/5	40/1	120/3
* THIS TABLE WAS C	REATED WITH RE	FERENCE TO MUTCO	TABLES NY-2 AND	NY2-B.

TABLE 011-05 FLARE RATES FOR POSITIVE BARRIER								
	F	OSTED	SPEEL	) LIMI	T			
TYPE OF POSITIVE BARRIER	30 MPH	40 MPH	50 MPH	55 MPH	65 MPH			
TEMPORARY POSITIVE BARRIER	8:1	11:1	14:1	16:1	20:1			
BOX BEAM OR HEAVY POST CORRUGATED BEAM	7:1	9:1	11:1	12:1	15:1			

ADVANC	TABLE E WARNIN	011-06 IG SIGN	SPACIN	IG	
	DISTANC	E BETWEE	N SIGNS	SIGN	LEGEND
ROAD TYPE	A (FT.)	B (FT.)	C (FT.)	XX	YY
URBAN (≤ 30 MPH*)	100	100	100	AHEAD	AHEAD
URBAN (35-40 MPH*)	200	200	200	AHEAD	AHEAD
URBAN (≥45 MPH*)	350	350	350	1000 FT.	AHEAD
RURAL	500	500	500	1500 FT.	1000 FT.
FREEWAY	1000	1500	2640	1 MILE	1/2 MILE
<ul> <li>PRECONSTRUCTION POSTED</li> <li>** THIS TABLE IS THE SAME</li> </ul>	SPEED LII E AS MUTC	MIT. D TABLE	NY6H-3.		
	ABLE 011	-07			

TAPER LENGTH FOR TRAFFIC CONTRO	
TYPE OF TAPER	TAPER LENGTH (L)
MERGING TAPER	L
SHIFTING TAPER	L/2
SHOULDER TAPER	L/3
ONE-LANE, TWO-WAY TRAFFIC TAPER	50 FT. MIN -100 FT. MA
DOWNSTREAM TAPER	50 FT. MIN -100 FT. MA
DOWNSTREAM TAPER  ◆ THIS TABLE IS THE SAME AS MUTCD	

SYMBOL	DESCRIPTION		
0 0 0 0 0	ARROW PANEL		
0 • • • • • • • • • • • • • • • • • • •	ARROW PANEL, CAUTION MODE		
000	ARROW PANEL TRAILER OR SUPPORT		
Ι	CHANGEABLE MESSAGE SIGN (PVMS)		
	CHANNELIZING DEVICE		
A	CONE		
	CRASH CUSHION/TEMPORARY IMPACT ATTENUATOR		
	DIRECTION OF TEMPORARY TRAFFIC DETOUR		
<b>→</b>	DIRECTION OF TRAFFIC		
	AUTOMATED FLAGGER ASSISTANCE DEVICE WITH OPERATOR		
	FLAGGER		
	FLAG TREE		
	LUMINAIRE		
	MOWER		
	PARKWAY GRASS SHOULDER		
11111	PAVEMENT MARKINGS THAT SHALL BE REMOVED FOR A LONG TERM PROJECT		
PVMS	PORTABLE VARIABLE MESSAGE SIGN		
***	ADVANCE WARNING SIGN WITH ORANGE FLACS		
	TRAILER FOR ARROW PANEL OR PORTABLE VARIABLE MESSAGE SIGN (PVMS)		

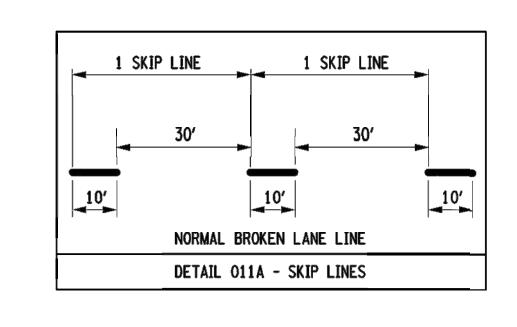

WOR	K ZONE TRAFFIC CONTROL LEGEND
SYMBOL	DESCRIPTION
F	SIGN, TEMPORARY
	SPOTTER
	TEMPORARY POSITIVE BARRIER
	TEMPORARY POSITIVE BARRIER WITH WARNING LIGHTS
<b>⊗</b> →	TEMPORARY TRAFFIC SIGNAL HEAD
	TYPE III BARRICADE
<u> </u>	WARNING LIGHTS
	WORK AREA
	WORK VEHICLE
	WORK VEHICLE (MULCHING/HERBICIDE OPERATION)
	WORK VEHICLE (PAVEMENT MARKING)
<b>DEL</b>	WORK VEHICLE (SIGNAL WORK)
	24,000LB PROTECTIVE VEHICLE WITH TRUCK/TRAILER MOUNTED ATTENUATOR (TMIA)
	24,000LB PROTECTIVE VEHICLE WITHOUT TRUCK/ TRAILER MOUNTED ATTENUATOR

	NEW YORK STATE OF OPPORTUNITY.	Department of Transportation
	U.S. CUSTOMARY S	STANDARD SHEET
	WORK ZONE TRA GENERAL TABLE	S AND LEGEND
AF	PPROVED DECEMBER 2. 2021	ISSUED UNDER EI 21-028
ROE	BERT LIMOGES, P.E. ECTOR, OTSM	619-011

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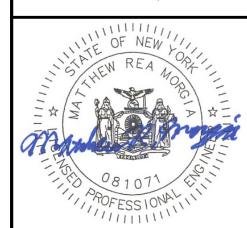
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BURLINGTON STREET RECONSTRUCTION PROJE

YORK

DRAWN BY: TFT

WORK ZONE TRAFFIC CONTROL SHEETS

CT-501

2022

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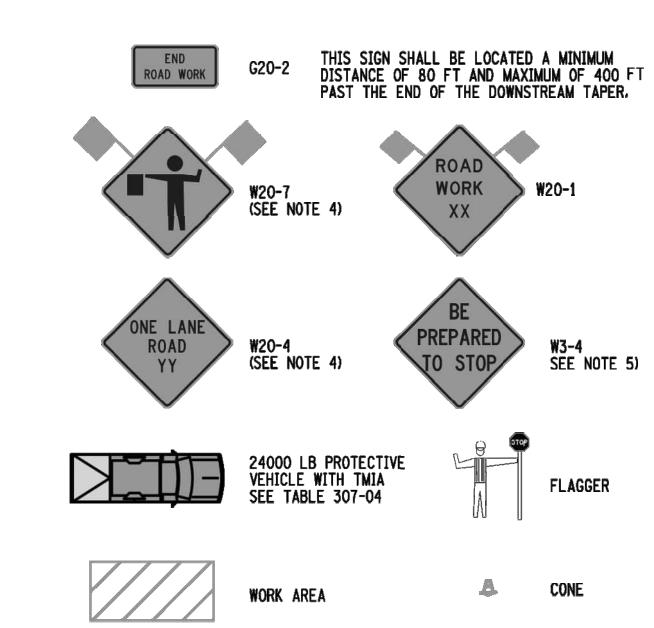
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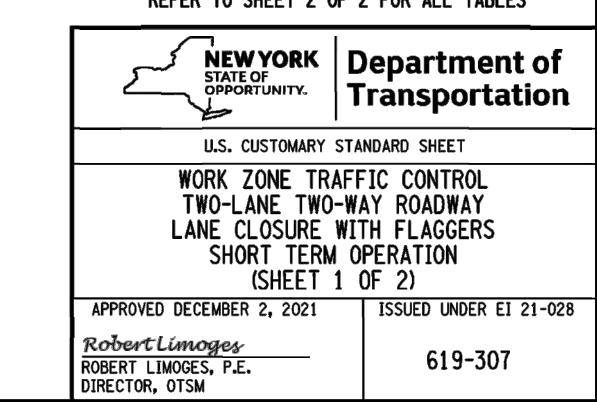
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FILE NAME DATE/TIME USER NOTES:

- 1. SHORT-TERM STATIONARY IS DAYTIME WORK THAT OCCUPIES A LOCATION FOR MORE THAN 1 HOUR WITHIN A SINGLE DAY PERIOD.
- 2. IN URBAN CONDITIONS, ADVANCE WARNING SIGN SPACINGS MAY BE ADJUSTED IN ORDER TO ACCOMMODATE SIDE STREETS AND DRIVEWAYS. IF THERE IS A CONFLICT, MOVE THE SIGN UPSTREAM.
- CENTERLINE CONES MAY BE ADDED TO ENHANCE THE VISIBILITY OF THE FLAGGER STATION. IF CONES ARE USED, PLACE THEM 100 FT. (MINIMUM) FROM FLAGGER.
- 4. FLAGGER SYMBOL SIGN (W20-7) AND "ONE LANE ROAD AHEAD" SIGN (W20-4) SHALL BE REMOVED, COVERED OR TURNED AWAY FROM ROAD USERS WHEN FLAGGING OPERATIONS ARE NOT OCCURING.
- 5. IF THE TRAFFIC IS EXPECTED TO QUEUE PAST THE W20-4 SIGN, A W3-4 SIGN SHOULD BE ADDED.
- 6. IF CONDITIONS WARRANT, PROTECTIVE VEHICLE WITH APPROPRIATE ROLL AHEAD DISTANCE MAY BE USED IN ADVANCE OF THE WORK AREA. TO USE PROTECTIVE VEHICLE, BUFFER SPACE SHALL BE PROVIDED ACCORDINGLY.
- 7. WHEN A SIDE ROAD OR DRIVEWAY INTERSECTS THE ROADWAY WITHIN A WORK ZONE TRAFFIC CONTROL AREA, ADDITIONAL TEMPORARY TRAFFIC CONTROL DEVICES AND/OR FLAGGERS SHALL BE PLACED AS NEEDED. ADDITIONAL FLAGGERS SHALL BE LOCATED AT ALL INTERSECTIONS AND COMMERCIAL DRIVEWAYS LOCATED WITHIN OR NEAR THE ACTIVE WORK SPACE.
- 8. CHANNELIZING DEVICE SPACING (CENTER TO CENTER) SHALL NOT EXCEED 40' IN THE ACTIVE WORK SPACE.
- 9. CHANNELIZING DEVICES SHALL BE PLACED TRANSVERSELY A MINIMUM OF EVERY 800' AS SHOWN WHEN A PAVED SHOULDER HAVING A WIDTH OF 8' OR GREATER IS CLOSED FOR A DISTANCE GREATER THAN 800'.
- 10. ALL FLAGGERS SHALL USE 24"(MIN.) OCTAGON SHAPED STOP/SLOW PADDLES HAVING 6' STAFF. THE PADDLE IS THE PREFERRED DEVICE, BUT THE FLAG MAY BE USED AT INTERSECTIONS WHERE THE STOP/SLOW PADDLE WOULD OFFER CONTRADICTING INFORMATION TO DRIVERS TRAVELING IN OPPOSITE DIRECTIONS/LEGS OF THE INTERSECTION OR DURING INCIDENT MANAGEMENT SITUATIONS.



REFER TO SHEET 2 OF 2 FOR ALL TABLES



UBERTINE


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BURLINGTON STREET
RECONSTRUCTION PROJECT
CITY OF WATERTOWN
ENGINEERING DEPARTMENT
JEFFERSON COUNTY, STATE OF NEW YORK

PROJECT NO: 2023-052

DRAWN BY: TFT

CHECKED BY: MRM

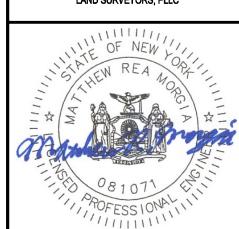2024 2024

WORK ZONE TRAFFIC CONTROL SHEETS

**CT-502** 

TABLE 307-01: ADVANCE WARNING SIGN SPACING					
	DISTANCE	BETWEE	N SIGNS	SIGN	LEGEND
ROAD TYPE	A (FT.)	B (FT.)	C (FT.)	xx	ΥΥ
URBAN (≤ 30 MPH*)	100	100	100	AHEAD	AHEAD
URBAN (35-40 MPH+)	200	200	200	AHEAD	AHEAD
URBAN (≥45 MPH*)	350	350	350	1000 FT.	AHEAD
RURAL	500	500	500	1500 FT.	1000 FT.

PRECONSTRUCTION POSTED SPEED LIMIT

TABLE 307-02: LONGIT	UDINAL BUFFER SPACE
PRECONSTRUCTION POSTED SPEED LIMIT (MPH)	LONGITUDINAL BUFFER SPACE DISTANCE (FT.)/ # OF SKIP LINES
25	155/4
30	200/5
35	250/6
40	305/8
45	360/9
50	425/11
55	495/13

T	ABLE 307-03: REQUIRED S	IGN SIZES*
SIGN	NON-FREEWAY	FREEWAY
G20-2	36x18	48x24
W3-4	36x36	48×48
W20-1	36x36	48×48
W20-4	36x36	48×48
W20-7	36x36	48×48
WARNING FLAG	18x18	18×18
*FREEWA	Y SIZES MAY BE USED ON NON-F CONSTRAINTS DO NOT EXI	

	TABLE	307-04: PROTECTIV	VE VEHICLE REQUIR	EMENTS
	ROAD TYPE & SPEED		NON-FREEWAY	
CLOSURE TYPE	ROAD TIPE & SPEED	≥ 45 MPH	35 - 40 MPH	≤ 30 MPH
	EXPOSURE CONDITIONS 1			
LANE CLOSURE OR	WORKERS ON FOOT OR VEHICLE EXPOSED TO TRAFFIC	P, TMIA	P, TMIA	P
ENCROACHMENT	OTHER HAZARDS NO WORKERS EXPOSED	P, TMIA	Р	SEE NOTE 2
SHOULDER CLOSURE	WORKERS ON FOOT OR VEHICLE EXPOSED TO TRAFFIC	P, TMIA	Р	Р
OR ENCROACHMENT	OTHER HAZARDS NO WORKERS EXPOSED	P, TMIA	Р	SEE NOTE 2


TABLE 307-05:	ROLL AHEAD	DISTANCE
ROLL AHEAD DISTAN	ICE (FT.)/* OF S VEHICLES	KIP LINES FOR
PRECONSTRUCTION	STATIONARY	OPERATION
POSTED SPEED LIMIT (MPH)	MIN	MAX
≥ 55	120/3	200/5
45 - 50	80/2	160/4
≤ 40	40/1	120/3

P: PROTECTIVE VEHICLE REQUIRED FOR EACH CLOSED LANE & EACH CLOSED PAVED SHOULDER 8' OR WIDER, IF THE WORK SPACE MOVES WITHIN THE STATIONARY CLOSURE, THE PROTECTIVE VEHICLE SHALL BE REPOSITIONED ACCORDINGLY TMIA: TMIA REQUIRED

NOTES:
1. THE EXPOSURE CONDITIONS ASSUMES THERE IS NO POSITIVE PROTECTION PRESENT

2. EITHER A PROTECTIVE VEHICLE OR THE STANDARD BUFFER SPACE SHALL BE PROVIDED

TABLE 307-05:	ROLL AHEAD	DISTANCE	
ROLL AHEAD DISTANCE (FT.)/* OF SKIP LINES FOR VEHICLES			
PRECONSTRUCTION	STATIONARY OPERATION		
POSTED SPEED LIMIT (MPH)	MIN	MAX	
≥ 55	120/3	200/5	
45 - 50	80/2	160/4	
≤ 40	40/1	120/3	

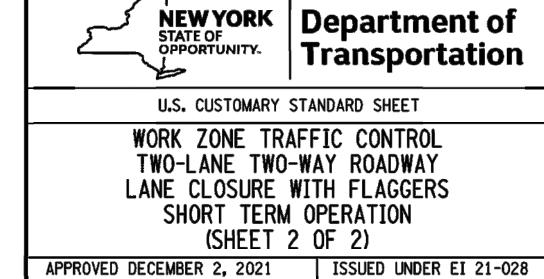

Robert Limoges ROBERT LIMOGES, P.E. DIRECTOR, OTSM

619-307

PROJECT NO: 2023-052

BURLINGTON STREET RECONSTRUCTION PROJE

WORK ZONE TRAFFIC CONTROL SHEETS

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